

# GENERAL NOTES

- THIS PROJECT IS TO BE CONSTRUCTED IN ACCORDANCE WITH THE DELAWARE DEPARTMENT OF TRANSPORTATION "STANDARD SPECIFICATIONS", DATED AUGUST 2001 AND THE DELAWARE DEPARTMENT OF TRANSPORTATION "STANDARD CONSTRUCTION DETAILS", DATED 2001, INCLUDING ALL REVISIONS UP TO THE DATE OF ADVERTISEMENT.
- THE CONTRACTOR SHALL GIVE TWO (2) WEEKS NOTICE TO THE PROPERTY OWNER WHEN ANY FIXTURE, SHRUB OR OTHER OBJECT MUST BE REMOVED FROM THE RIGHT OF WAY OR EASEMENT AREA. IF THE OWNER HAS NOT ATTEMPTED TO SALVAGE THIS PROPERTY, THE CONTRACTOR SHALL REMOVE IT WITHOUT OBLIGATION. COMPENSATION SHALL BE INCIDENTAL TO THE CONTRACT.
- THE ENDS OF ALL CURBS SHALL BE DEPRESSED FLUSH WITH THE PAVEMENT AT A RATIO OF TWELVE TO ONE (12:1) UNLESS OTHERWISE DIRECTED BY THE ENGINEER.
- THE CONTRACTOR SHALL PROVIDE AND INSTALL PVC SLEEVES (4" INSIDE MINIMUM DIAMETER, 6" INSIDE MAXIMUM DIAMETER) IN PROPOSED CONCRETE SIDEWALKS, ISLANDS, AND MEDIANS FOR FUTURE TRAFFIC SIGN POSTS AS DIRECTED BY THE ENGINEER. THE LOWER END OF THE SLEEVE SHALL SIT ON THE TOP OF THE SUBBASE MATERIAL. THE COST SHALL BE INCIDENTAL TO THE CONTRACT.
- STAGING AREAS - PROPER EROSION AND SEDIMENT CONTROL MEASURES AS DETERMINED BY THE ENGINEER SHALL BE INSTALLED IN ALL STAGING AREAS. ALL AREAS USED BY THE CONTRACTOR FOR STAGING OPERATIONS SHALL BE FULLY RESTORED BY THE CONTRACTOR UPON COMPLETION OF THE CONTRACT. IF THE STAGING AREA IS PAVED, IT SHALL BE RESTORED TO ITS ORIGINAL CONDITION. IF THE AREA IS UNPAVED, IT SHALL BE RE-GRADED, TOPSOILED, SEEDED AND MULCHED IN ACCORDANCE WITH DELAWARE STANDARD SPECIFICATIONS 732, 734 AND 735, FOR TOPSOIL, SEED AND MULCH RESPECTIVELY, TO THE SATISFACTION OF THE ENGINEER. THE SEED SHALL ADHERE TO THE SPECIFICATIONS OF SECTION 734 FOR PERMANENT GRASS SEEDING - DRY GROUND. ALL COSTS ASSOCIATED WITH RESTORATION OF THE STAGING AREA SHALL BE AT THE CONTRACTOR'S EXPENSE. IF THE ENGINEER DETERMINES THAT A SATISFACTORY STAND OF GRASS DOES NOT EXIST AT THE TIME OF FINAL INSPECTION, ALL COSTS ASSOCIATED WITH REESTABLISHING A SATISFACTORY STAND OF GRASS SHALL BE AT THE CONTRACTOR'S EXPENSE.
- SITE REVIEWER - AN EROSION CONTROL SITE REVIEWER SHALL BE A PERSON FROM THE CONTRACTOR'S STAFF ASSIGNED TO EROSION AND SEDIMENT CONTROL IMPLEMENTATION AND MAINTENANCE AND SHALL BE REQUIRED ON SPECIFIC PROJECTS. THE NAME AND DNR/CERTIFICATION NUMBER OF EACH SITE REVIEWER SO REQUIRED SHALL BE SUBMITTED TO THE DEPARTMENT. THE NAME OF THE DELAWARE REGISTERED PROFESSIONAL ENGINEER PROVIDING DIRECTION AND SUPERVISION OF THE SITE REVIEWER, AS REQUIRED IN SECTION 12.3 OF THE DELAWARE SEDIMENT AND STORMWATER REGULATIONS, SHALL ALSO BE SUBMITTED TO THE DEPARTMENT. THE SITE REVIEWER REQUIREMENTS IN EFFECT ON THIS PROJECT SHALL BE MARKED WITH AN "X" BELOW:

EROSION POTENTIAL FOR THIS PROJECT	SITE REVIEWER REQUIREMENT
( ) INSIGNIFICANT	NONE
( ) MINOR	CONTRACTOR CERTIFICATION COURSE TRAINING ONLY, AS DEFINED IN SECTION 13 OF THE DELAWARE SEDIMENT AND STORMWATER REGULATIONS.
(X) MEDIUM	AT THE TIME OF BID OF THE CONTRACT, EITHER THE SUPERINTENDENT OR A SEPARATE INDIVIDUAL FROM THE CONTRACTOR'S STAFF SHALL BE A CERTIFIED CONSTRUCTION REVIEWER (CCR), AS DEFINED IN SECTION 12 OF THE DELAWARE SEDIMENT AND STORMWATER REGULATIONS.
( ) MAJOR	SUPERINTENDENT AND AN INDIVIDUAL FROM CONTRACTOR'S STAFF SHALL BE CCR. ONE INDIVIDUAL FROM THE CONTRACTOR'S STAFF MUST BE A CCR AT THE TIME OF BID OF THE CONTRACT. THE SUPERINTENDENT MUST BECOME A CCR WITHIN ONE YEAR AFTER THE AWARD OF CONTRACT.

- ELECTRONIC PROJECT FILES THAT WILL BE MADE AVAILABLE TO THE CONTRACTOR INCLUDE:

( )	NONE
( )	ASCII DATA FILES WITH COORDINATES AND ELEVATIONS FOR PROPOSED POINTS AS SELECTED BY THE ENGINEER.
(X)	RASTER FILES, IN .CAL FILE FORMAT, FOR ALL PLAN SHEETS.
( )	EXISTING DIGITAL TERRAIN MODEL, IN .DTM FILE FORMAT, COMPATIBLE WITH SOFTWARE CURRENTLY USED BY DELDOT.
( )	PROPOSED DIGITAL TERRAIN MODEL, IN .DTM FILE FORMAT, COMPATIBLE WITH SOFTWARE CURRENTLY USED BY DELDOT.
( )	DESIGN FILE, IN .DGN FILE FORMAT, CONTAINING ONLY THE PROPOSED 3D TRIANGLES OF THE PROPOSED DIGITAL TERRAIN MODEL (DTM).

NOTE: THE DOCUMENT ENTITLED "RELEASE FOR DELIVERY OF DOCUMENTS IN ELECTRONIC FORM TO A CONTRACTOR" MUST BE SIGNED BY ALL PARTIES PRIOR TO THE DELIVERY OF ANY ELECTRONIC PROJECT FILES.

- AMERICAN TRAFFIC SAFETY SERVICES ASSOCIATION (ATSSA) CERTIFIED TRAFFIC CONTROL SUPERVISOR REQUIREMENT FOR THIS PROJECT.

( )	THE CONTRACTOR SHALL NOT BE REQUIRED TO HAVE AN ATSSA SUPERVISOR ASSIGNED TO THIS PROJECT.
(X)	THE CONTRACTOR SHALL HAVE AN ATSSA SUPERVISOR ASSIGNED TO THIS PROJECT. THE CONTRACTOR'S GENERAL SUPERINTENDENT FOR THIS PROJECT OR ANOTHER ATSSA CERTIFIED MEMBER OF THE CONTRACTOR'S PROJECT STAFF MAY BE THE ATSSA SUPERVISOR. PAYMENT FOR ATSSA SUPERVISOR IS INCIDENTAL TO ITEM 743000.
( )	THE CONTRACTOR SHALL HAVE AN ATSSA SUPERVISOR ASSIGNED TO THIS PROJECT. THE ATSSA SUPERVISOR'S SOLE JOB SHALL BE SUPERVISION OF THE INSTALLATION, OPERATION AND MAINTENANCE OF TRAFFIC CONTROL DEVICES FOR THIS PROJECT. THE CONTRACTOR'S GENERAL SUPERINTENDENT FOR THIS PROJECT SHALL NOT BE THE ATSSA SUPERVISOR. PAYMENT FOR ATSSA SUPERVISOR SHALL BE PAID UNDER ITEM 743031.

- THE DISTURBED AREA FOR THIS PROJECT IS 39.45 ACRES FOR THE BASE BID AND 6.07 ACRES FOR THE ADD ALTERNATES.
- THE CONTRACTOR SHALL BE RESPONSIBLE FOR ADHERING TO THE CONSTRUCTION SITE POLLUTION PREVENTION SPECIFICATIONS AS DETAILED IN SECTION 3.6 OF THE "DELAWARE EROSION AND SEDIMENT CONTROL HANDBOOK". ALL COSTS ASSOCIATED WITH ADHERING TO THE STANDARDS SHALL BE INCIDENTAL TO THE OVERALL CONTRACT COSTS.
- THE EROSION AND SEDIMENT CONTROL PLANS HAVE BEEN APPROVED BY DELDOT'S STORMWATER ENGINEER UNDER DELDOT'S DELEGATED AUTHORITY. THE EROSION AND SEDIMENT CONTROL PLANS ARE VALID FOR A THREE YEAR PERIOD, BEGINNING ON THE DATE THE STORMWATER ENGINEER SIGNED THE CONSTRUCTION TITLE SHEET. IF THE FINAL ACCEPTANCE OF THE PROJECT IS ANTICIPATED TO EXTEND BEYOND THE THREE YEARS, THE CONTRACTOR SHALL INFORM THE ENGINEER THREE MONTHS PRIOR TO THE EXPIRATION OF THE EROSION AND SEDIMENT CONTROL PLAN APPROVAL. DELDOT WILL REVIEW THE CURRENT EROSION AND SEDIMENT CONTROL PLAN AND ISSUE AN EXTENSION WITH ANY APPROPRIATE MODIFICATIONS.

# PROJECT NOTES

## SECTION 100

- ANY DAMAGE TO ITEMS NOTED TO BE RELOCATED OR RESET BY THE CONTRACTOR, AT THE DISCRETION OF THE ENGINEER, SHALL BE REPAIRED AND/OR REPLACED IN KIND AT THE CONTRACTOR'S EXPENSE.

## SECTION 200

- THE ENGINEER MAY REQUIRE THE CONTRACTOR TO EXCAVATE TEST PITS ALONG PROPOSED DRAINAGE RUNS, AT POINTS OF POSSIBLE UTILITY CONFLICTS, TO DETERMINE IF A CONFLICT EXISTS. ANY CONFLICTS SHALL BE COORDINATED BY THE CONTRACTOR, WITH THE ENGINEER AND THE UTILITY COMPANY INVOLVED. THE ENGINEER SHALL ULTIMATELY DETERMINE THE SOLUTION TO THE UTILITY CONFLICT. TEST HOLES SHALL BE MEASURED AND PAID FOR IN ACCORDANCE WITH ITEM 208000 - EXCAVATION AND BACKFILL FOR PIPE TRENCHES, BUT ONLY TO THE ACTUAL DEPTH EXCAVATED.
- ITEMS TO BE REMOVED UNDER ITEM 21000 - REMOVAL OF STRUCTURES AND OBSTRUCTIONS SHALL INCLUDE, BUT NOT BE LIMITED TO THE FOLLOWING:
  - CONCRETE HEADWALLS
  - DRAINAGE MANHOLES
  - LIGHT POLES
  - CHAIN LINK FENCE
  - CHAIN LINK FENCE GATES
  - CONTACT STATIONS
  - BOLLARDS
 ITEMS REMOVED UNDER 21000 SHALL BE REMOVED TO THE LIMITS DESCRIBED IN STANDARD SPECIFICATION 21000 OR TO A DEPTH OF 3' BELOW PROPOSED GRADE, WHICHEVER IS GREATER.
- THIS PROJECT IS COVERED UNDER AN NPDES GENERAL PERMIT FOR CONSTRUCTION. UNDER THE GENERAL PERMIT, COMPLIANCE WITH DELDOT'S APPROVED SEDIMENT AND STORMWATER MANAGEMENT PLANS WILL CONSTITUTE COMPLIANCE WITH THE NPDES INDUSTRIAL PERMITTING REQUIREMENTS FOR THIS CONSTRUCTION PROJECT. A COPY OF THE NPDES GENERAL PERMIT AND NOI IS KEPT ON FILE IN EACH OF THE CONSTRUCTION OFFICES AND THE DEPARTMENT'S TEAM SUPPORT SECTION. A COPY OF THE GENERAL PERMIT OR THE NOI CAN BE OBTAINED UPON REQUEST FROM EITHER THE DEPARTMENT'S STORMWATER ENGINEER OR THE APPROPRIATE CONSTRUCTION ENGINEER.
- WHEN PERFORMING ANY EXCAVATION OR BACKFILLING OF ANY EXCAVATION, THE CONTRACTOR SHALL PROVIDE GROUNDWATER LEVEL AT LEAST ONE FOOT BELOW THE EXCAVATION ELEVATION. THE CONTRACTOR SHALL ALSO PROVIDE NECESSARY DEWATERING TO STABILIZE EXCAVATED SLOPES DURING CONSTRUCTION AND UNTIL THE SLOPES ARE STABILIZED AS DETERMINED BY THE ENGINEER. THE CONTRACTOR IS NOTIFIED THAT REMOVAL OF WATER FROM BELOW THE GROUNDWATER TABLE WILL REQUIRE PERMITS FROM DNR/CERT AND IT SHALL BE THE CONTRACTOR'S RESPONSIBILITY TO OBTAIN ALL NECESSARY PERMITS TO SUPPORT HIS MEANS AND METHODS OF CONSTRUCTION. ALL COSTS SHALL BE INCIDENTAL TO THE APPLICABLE EXCAVATION ITEM.

## SECTION 300

- A. THE CONTRACTOR MAY ELECT TO USE ANY OF THE FOLLOWING MATERIALS TO MEET THE REQUIREMENTS OF ITEM 302007 - GRADED AGGREGATE BASE COURSE, TYPE 'B':
  - CRUSHED STONE (PER STANDARD SPECIFICATION 821)
  - CRUSHED CONCRETE (PER STANDARD SPECIFICATION 821)
  - HOT-MIX MILLINGS (PER SPECIAL PROVISION 302514 MILLED HOT-MIX BASE COURSE)

THE CONTRACTOR WILL NOT BE ALLOWED TO MIX DIFFERENT MATERIALS (OR SIMILAR MATERIALS FROM DIFFERENT SOURCES) TO MEET THE REQUIREMENTS OF ITEM 302007 - GRADED AGGREGATE BASE COURSE, TYPE 'B'.

ALL OF THE ABOVE LISTED MATERIALS ARE PERMITTED FOR USE ON THE JOB, PROVIDED THEY ARE SEPARATED INTO APPROVED AREAS. EACH AREA OF BASE COURSE MUST BE CONSTRUCTED USING MATERIALS FROM A SINGULAR SOURCE, FULL DEPTH, IN ORDER THAT PROPER TESTING MAY BE ACCOMPLISHED. THE CONTRACTOR AND ENGINEER SHALL AGREE ON THE LIMITS OF EACH SOURCE OF MATERIAL PRIOR TO PLACEMENT.

- THE QUANTITY USED FOR BASE OF EACH OF THE ABOVE LISTED MATERIALS WILL BE THE CONTRACTOR'S CHOICE, WITH THE TOTAL BEING EQUAL TO THE ACTUAL QUANTITY USED UNDER ITEM 302007 - GRADED AGGREGATE BASE COURSE, TYPE 'B'.

- THE CONTRACTOR MAY ALSO ELECT TO RECYCLE MILLINGS FOR USE IN HOT-MIX AS PERMITTED BY THE STANDARD SPECIFICATIONS. THE CHOICE OF THE QUANTITY OF MILLINGS USED FOR THIS PURPOSE, OR FOR BASE COURSE, LIES WITH THE CONTRACTOR. ALL EXCESS MILLING MATERIAL SHALL BECOME PROPERTY OF THE CONTRACTOR.

- HOT-MIX MILLINGS MAY BE GENERATED FROM THE FOLLOWING SOURCES:

- MATERIAL MADE AVAILABLE WHEN MILLED ON THIS CONTRACT UNDER ITEM 760507.
- MATERIAL MILLED ON THIS CONTRACT AT THE CONTRACTOR'S CHOICE UNDER ITEM 202000.
- MILLED MATERIAL FURNISHED ON THE JOB FROM THE CONTRACTOR'S YARD OR OTHER OUTSIDE SOURCE.
- ALL MILLED MATERIALS SHALL MEET THE MATERIAL REQUIREMENTS OF ITEM 302514 - MILLED HOT-MIX BASE COURSE.

- PAYMENT CLARIFICATION:

- SHOULD THE CONTRACTOR ELECT TO MILL PORTIONS OF HOT-MIX SHOWN ON THE PLANS TO BE REMOVED UNDER ITEM 202000 - EXCAVATION AND EMBANKMENT THE COST OF MILLING THIS HOT-MIX WILL BE PAID AS ITEM 202000 - EXCAVATION AND EMBANKMENT. THE MILLINGS GENERATED MAY BE RECYCLED INTO HOT-MIX, UTILIZED FOR BASE COURSE, OR DISPOSED OF TO AN APPROVED SITE. HAULING COSTS FOR DISPOSAL AND/OR RECYCLING ARE INCIDENTAL TO ITEM 202000 - EXCAVATION AND EMBANKMENT.
- MILLINGS GENERATED UNDER ITEM 760502 - PAVEMENT MILLINGS, TAPER CUT MAY BE RECYCLED INTO HOT-MIX, UTILIZED FOR BASE COURSE OR DISPOSED OF BY THE CONTRACTOR TO AN APPROVED SITE. NO SEPARATE PAYMENT WILL BE MADE FOR TRANSPORTING MILLINGS ON SITE OR TO AN APPROVED DISPOSAL SITE.
- SHOULD THE CONTRACTOR ELECT TO TEMPORARILY STOCKPILE MILLINGS ON THE JOB SITE FOR LATER USE, ALL COSTS FOR STOCKPILING AND SUBSEQUENT REHANDLING SHALL BE INCIDENTAL TO ITEM 202000 - EXCAVATION AND EMBANKMENT.
- MILLINGS USED FOR BASE COURSE SHALL BE PLACED IN ACCORDANCE WITH THE REQUIREMENTS OF SPECIAL PROVISION 302514 - MILLED HOT-MIX BASE COURSE. NO SEPARATE PAYMENT WILL BE MADE TO FURNISH MILLINGS FROM AN OUTSIDE SOURCE OR TRANSPORT MILLINGS WITHIN THE PROJECT LIMITS. MILLINGS USED FOR BASE COURSE WILL BE PAID FOR AT THE UNIT BID PRICE FOR ITEM 302007 - GRADED AGGREGATE BASE COURSE, TYPE 'B'.
- ALL COSTS TO UTILIZE MILLINGS IN RECYCLED HOT-MIX WILL BE INCIDENTAL TO THE UNIT PRICE BID FOR THE HOT-MIX ITEM USING THE RECYCLED MATERIAL.

- SPECIAL PROVISION 302514 - MILLED HOT-MIX BASE COURSE IS PROVIDED TO SPECIFY THE MEANS OF LAY DOWN AND COMPACTION AS WELL AS THE MATERIAL REQUIREMENTS FOR MILLINGS USED AS BASE COURSE. ALL COSTS TO BRING THE MILLINGS INTO COMPLIANCE WITH THE REQUIREMENTS OF ITEM - 302514 MILLED HOT-MIX BASE COURSE ARE INCIDENTAL TO ITEM 302007 - GRADED AGGREGATE BASE COURSE, TYPE 'B'. NO PAYMENT WILL BE MADE FOR ITEM 302514 - MILLED HOT-MIX BASE COURSE. THE QUANTITY OF MILLINGS USED FOR BASE COURSE WILL BE PAID FOR UNDER ITEM 302007 - GRADED AGGREGATE BASE COURSE.

## SECTION 600

- THE DEPARTMENT AND THE CONTRACTOR SHALL INSPECT ALL EXISTING PIPES AND DRAINAGE STRUCTURES TO BE USED IN THE FINAL DRAINAGE SYSTEM AND AGREE ON THE CONDITION PRIOR TO THE START OF CONSTRUCTION. EXISTING PIPES AND DRAINAGE STRUCTURES DAMAGED DUE TO CONTRACTOR OPERATIONS SHALL BE REPAIRED OR REPLACED IN-KIND AT THE CONTRACTOR'S EXPENSE. THE DEPARTMENT WILL VIDEO INSPECT NEW PIPE RUNS TO CONFIRM CONDITION PRIOR TO ACCEPTANCE. PIPE CLEANING PRIOR TO VIDEO INSPECTION AND MAINTENANCE OF TRAFFIC DURING THE VIDEO INSPECTION ARE THE RESPONSIBILITY OF THE CONTRACTOR AND INCIDENTAL TO THE PIPE ITEM THAT IS BEING VIDEO INSPECTED.


## SECTION 700

- IN AREAS WHERE PROPOSED CURB MEETS EXISTING CURB AND THE TWO CURB TYPES ARE NOT SIMILAR, THE PROPOSED CURB SHALL BE TRANSITIONED IN 10 LINEAR FEET, UNLESS OTHERWISE DIRECTED BY THE ENGINEER. PAYMENT FOR THIS WORK, INCLUDING SAW CUTTING EXISTING CURB SHALL BE INCIDENTAL TO THE PROPOSED CURB ITEM.
- WHERE PROPOSED CONCRETE SIDEWALK IS CONSTRUCTED TO MEET EXISTING SIDEWALK, THE EXISTING SIDEWALK SHALL BE SAWCUT AT THE TIE-IN POINT OR MEET THE NEAREST EXISTING SIDEWALK JOINT. ALL SAW CUTTING SHALL BE FULL DEPTH, UNLESS OTHERWISE NOTED ON THE PLANS OR DIRECTED BY THE ENGINEER AND SHALL BE PAID FOR UNDER ITEM 762002 - SAWCUTTING, CONCRETE, FULL DEPTH.
- PORTLAND CEMENT CONCRETE CHANNELIZING ISLANDS THAT ARE LESS THAN 75 SQ FT MAY BE POURED MONOLITHICALLY, OR AS DIRECTED BY THE ENGINEER.
- STATION AND ELEVATION DATA GIVEN FOR DRAINAGE STRUCTURES ARE TO BE APPLIED TO THE CENTER OF THE GRATE FOR INLETS, AND TO THE CENTER OF THE STRUCTURE FOR JUNCTION BOXES AND MANHOLES.
- ALL PAVED AREAS TO BE RECONSTRUCTED OR WIDENED SHALL BE SAWCUT AT THE POINT WHERE THE NEW PAVEMENT IS TO TIE INTO THE EXISTING PAVEMENT.

## MISCELLANEOUS


- THE CONTRACTOR SHALL CONTACT MICHAEL ELLER, THE CHIEF OF SCHEDULING FOR DART FIRST STATE, 14 DAYS PRIOR TO THE START OF CONSTRUCTION AT 302-576-6061.
- IT IS THE INTENT OF THE CONTRACT TO BALANCE THE MATERIAL (EARTHMOVING AND GRADED AGGREGATE BASE COURSE) WITHIN THE NORTH RV LOT AND NORTH DAY USE PARKING LOT. THE CONTRACTOR SHALL ROUGH GRADE THE PHASE 1 AREA PLACING MATERIAL IN SEPARATE STOCKPILES FOR FUTURE USE IN PHASE 3A (NORTH RV CAMPGROUND CONSTRUCTION), AFTER THE NORTH DAY USE LOT IS COMPLETE AND OPEN. THE CONTRACTOR SHALL BE PAID FOR THE EXCAVATED MEASURED QUANTITIES OF EMBANKMENT PER STANDARD SPECIFICATION SECTION 202. GRADED AGGREGATE BASE COURSE SHALL BE MEASURED AND PAID PER STANDARD SPECIFICATION 302. NO ADDITIONAL PAYMENT SHALL BE MADE FOR STOCKPILING OR RELOCATING STOCKPILES OF EXCAVATED SOIL OR AGGREGATE FOR FUTURE USE. SHOULD EXCESS MATERIAL IN THE STOCKPILES REMAIN AT END OF PHASE 3A, THE CONTRACTOR SHALL BE REQUIRED TO DISPOSE OF THE MATERIALS OFFSITE AT NO ADDITIONAL COST TO DELDOT.
- THE CONTRACTOR SHALL PLACE THE EXISTING RECYCLED CRUSHED CONCRETE, CURRENTLY STOCKPILED UNDER THE BRIDGE ON THE SOUTH SIDE OF THE INLET, IN THE BASE OF THE SOUTHEAST DAY USE LOT - NORTH PARKING LOT PAVING. THE RECYCLED CRUSHED CONCRETE SHALL BE PLACED IN A CONTINUOUS LAYER TOPPED WITH A LAYER OF GRADED AGGREGATE BASE COURSE. THE COST OF THIS WORK SHALL BE PAID FOR UNDER ITEM 302513, CRUSHED P.C. CONCRETE BASE COURSE. THE CONTRACTOR SHALL NOT BE ALLOWED TO MIX DIFFERENT MATERIALS (OR SIMILAR MATERIALS FROM DIFFERENT SOURCES) TO MEET THE REQUIREMENTS OF 302513 CRUSHED P.C. CONCRETE BASE COURSE. ANY RELOCATION OF THIS MATERIAL SHALL BE INCIDENTAL TO 302513 CRUSHED P.C. CONCRETE BASE COURSE.
- INTERIM MILESTONE: THE CONTRACTOR SHALL COMPLETE ALL WORK LISTED IN PHASES ONE AND TWO, INCLUDING RECEIPT OF ALL CERTIFICATES OF OCCUPANCY FOR THE FOLLOWING BUILDINGS NO LATER THAN 12 MAY 2014:
  - BLDG #2 ADMIN CONTACT STATION- NORTH DAY USE PARKING LOT
  - BLDG #9 SOUTHWEST BATH HOUSE-SOUTH TENT CAMPGROUND
  - BLDG #8 SOUTHEAST BATH HOUSE-SOUTH TENT CAMPGROUND
  - BLDG #1E SOUTHEAST CONTACT STATION-DAY USE PARKING LOT
  - BLDG #1W SOUTH WEST CONTACT STATION-SOUTH RV CAMPGROUND
 FAILURE TO COMPLETE ALL WORK REQUIREMENTS FOR THE INTERIM MILESTONE BY 12 MAY 2014 SHALL RESULT IN THE ASSESSMENT OF A PARK USER COST IN THE AMOUNT OF \$2,460.00 PER DAY.
- THE CONTRACTOR SHALL COMPLETE ALL WORK LISTED IN PHASE THREE INCLUDING RECEIPT OF ALL CERTIFICATES OF OCCUPANCY FOR THE FOLLOWING BUILDINGS NO LATER THAN 29 AUGUST 2014:
  - BLDG #3 RV LAUNDRY FACILITY-NORTH RV PARK
  - BLDG #4 RV SHOWER FACILITY-NORTH RV PARK
  - BLDG #5 BATH HOUSE-NORTH DAY USE PARKING LOT
 FAILURE TO COMPLETE ALL WORK IN PHASE THREE INCLUDING RECEIPT OF ALL CERTIFICATES OF OCCUPANCY FOR THE PREVIOUSLY MENTIONED BUILDINGS NO LATER THAN 29 AUGUST 2014 WILL RESULT IN THE ASSESSMENT OF A PARK USER COST IN THE AMOUNT OF \$1,230.00 PER DAY IN ADDITION TO LIQUIDATED DAMAGES.

MATCHLINE - SEE SHEET GG07-BB

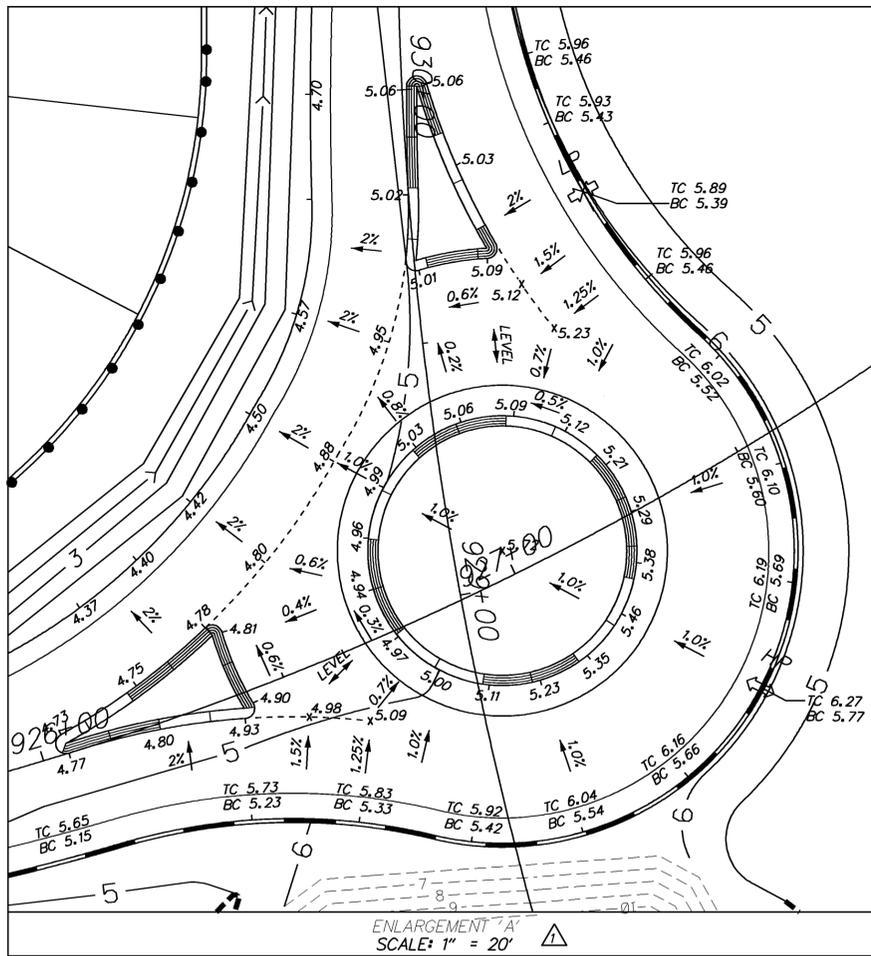

ENLARGEMENT 'A'  
SCALE: 1" = 20'

- NOTES:**
1. UNLESS OTHERWISE NOTED, POINT GEOMETRY IS GIVEN TO EDGE OF PAVEMENT.
  2. UNLESS OTHERWISE NOTED, RADII ARE GIVEN TO EDGE OF PAVEMENT.
  3. ALL PROPOSED CONTOURS ALL SHOWN AT 1' INTERVALS.
  4. PROPOSED CURB OR PAVEMENT THAT TIES INTO EXISTING PAVEMENT OR EXISTING CURB SHALL MATCH THE EXISTING PAVEMENT OR CURB ELEVATIONS. POSITIVE DRAINAGE SHALL BE MAINTAINED.
  5. EXISTING CONTOURS SHOWN AROUND AND UNDER BRIDGE ARE FROM DELDOT CONTRACTS 26-073-01 AND 29-073-01

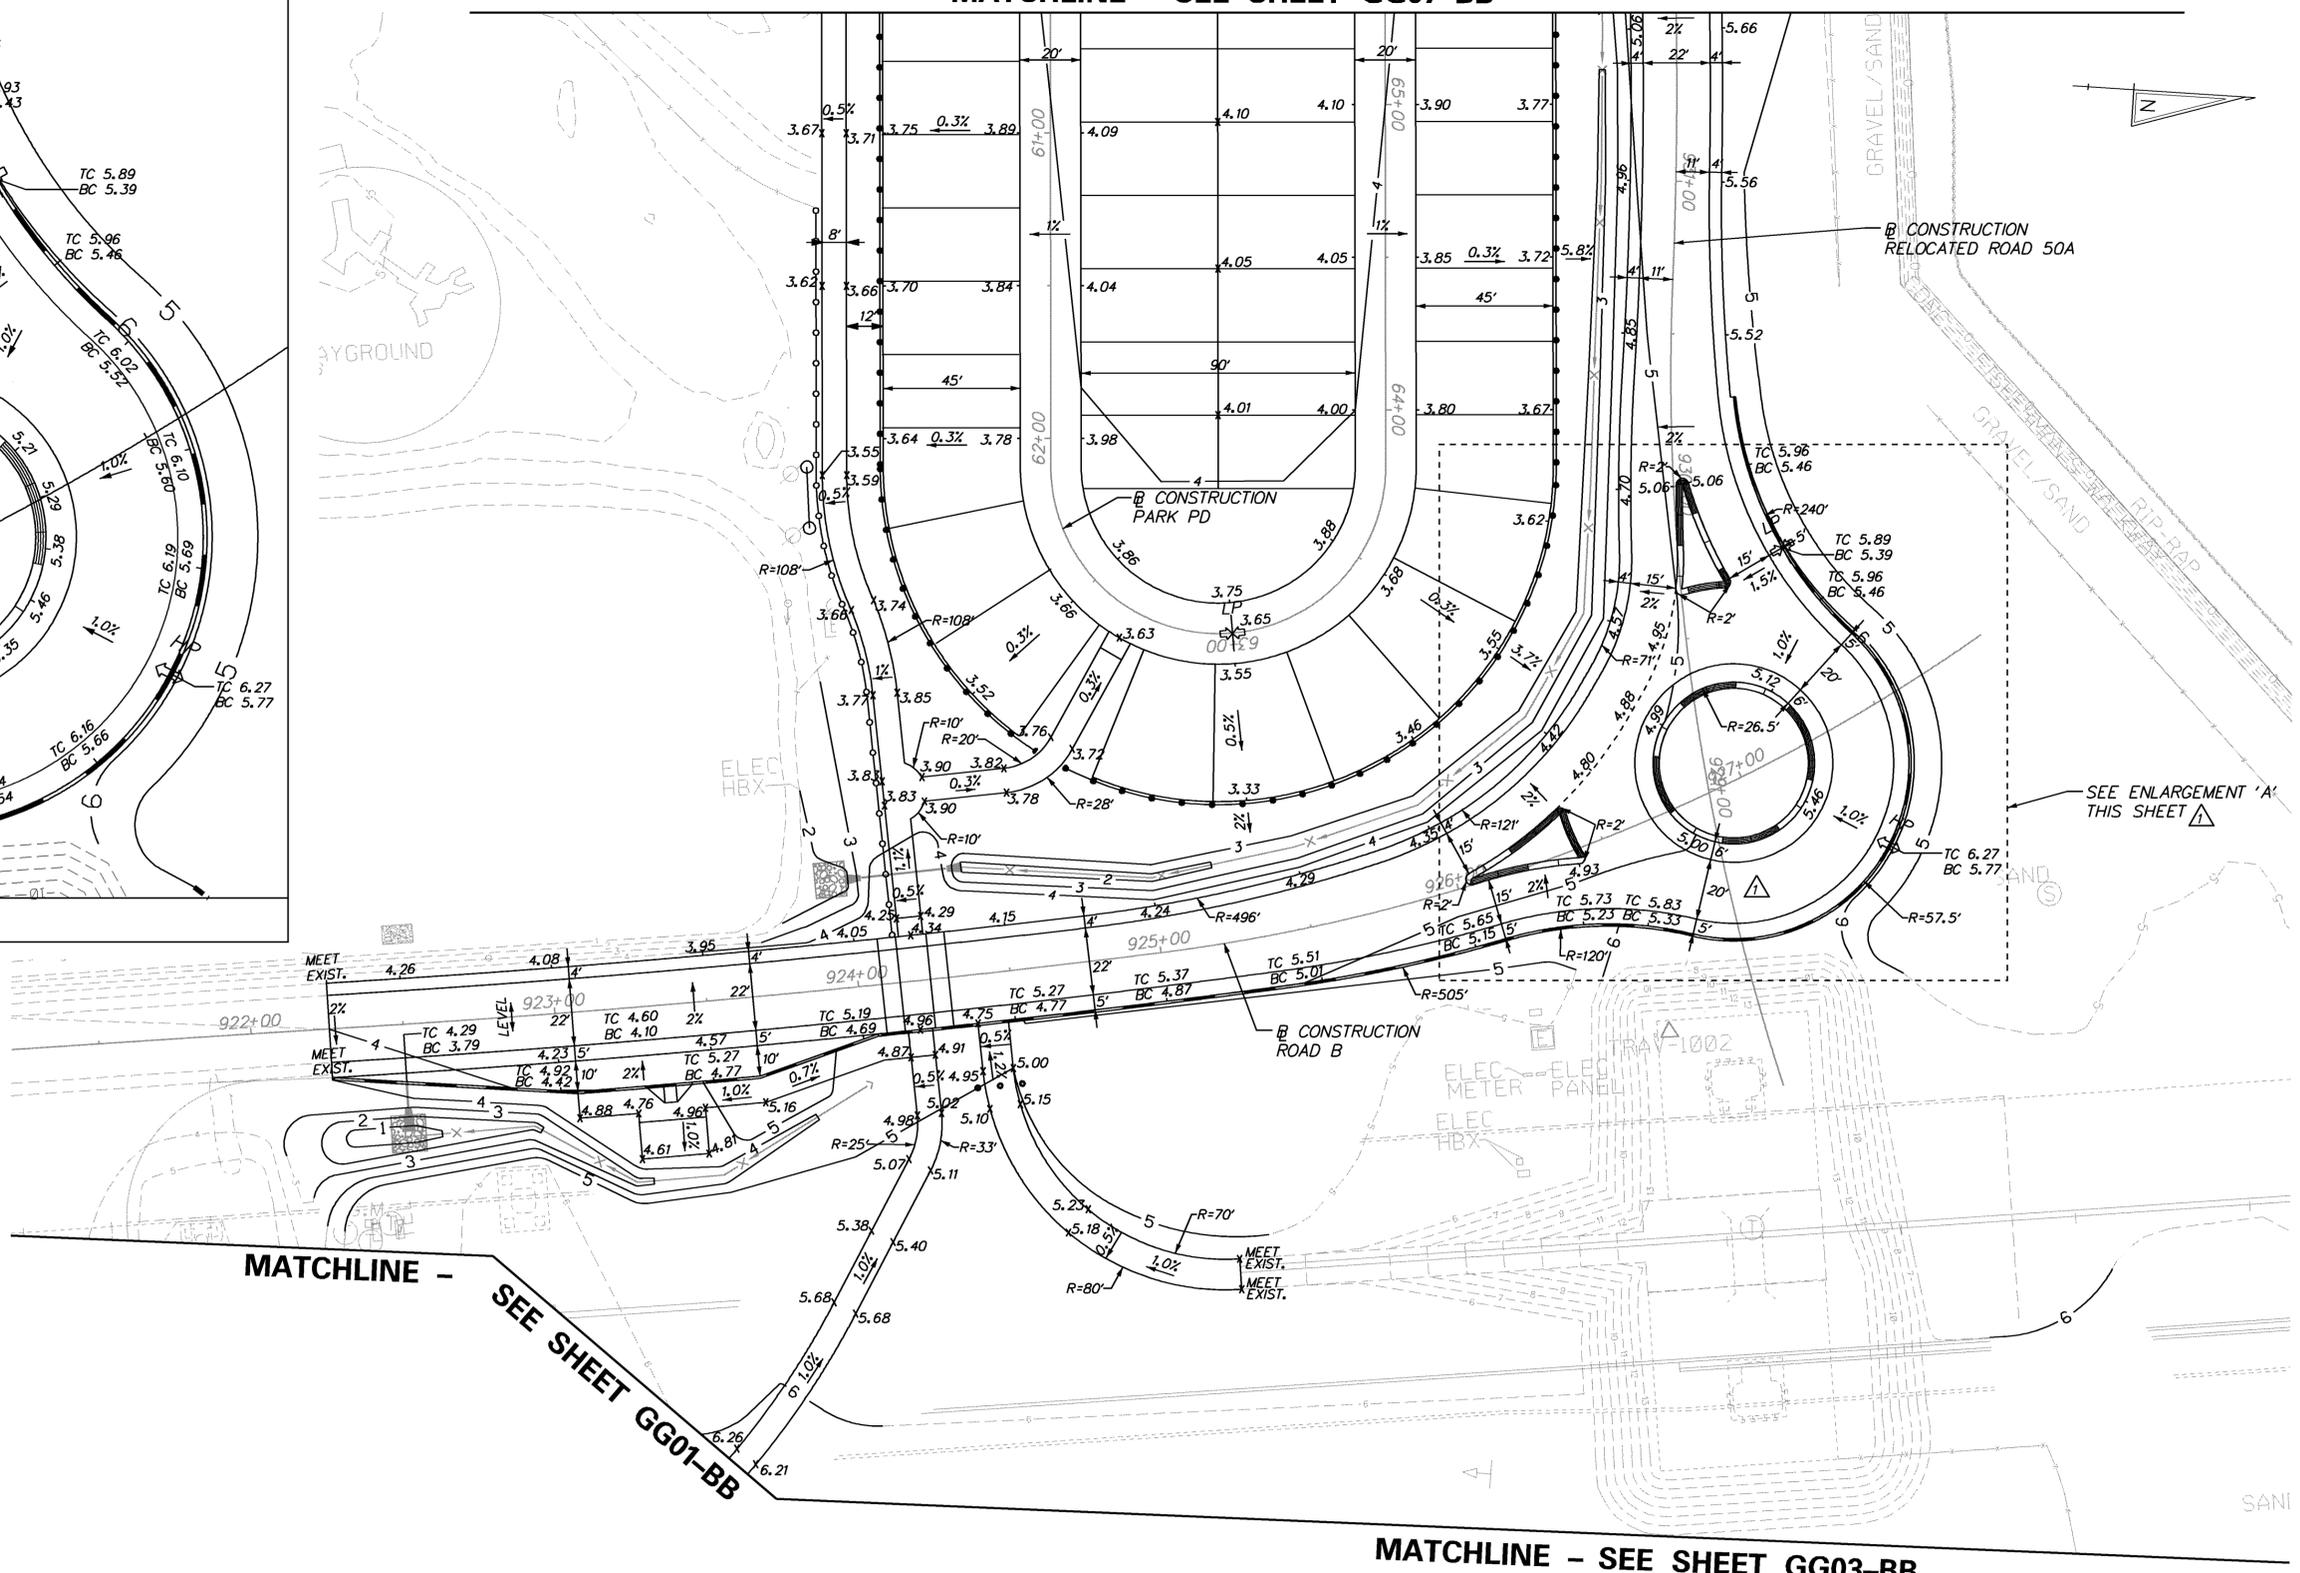


MATCHLINE - SEE SHEET GG01-BB

MATCHLINE - SEE SHEET GG03-BB

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ADDENDUMS / REVISIONS	
ADDENDUM NO. $\Delta$	REVISED GRADING
5/17/2013, RLS	

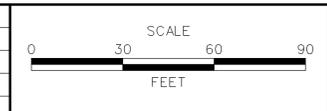


**INDIAN RIVER INLET  
PARK ENHANCEMENTS**

CONTRACT	BRIDGE NO.	<b>X</b>
T200507303	DESIGNED BY: RK&K	
COUNTY	CHECKED BY: RK&K	
SUSSEX		



**GRADES AND GEOMETRICS  
GRADING PLAN  
(BASE BID)**

<b>GG05-BB</b>
SHEET NO.
48
TOTAL SHTS.
282

MATCHLINE - SEE SHEET GG24-AA

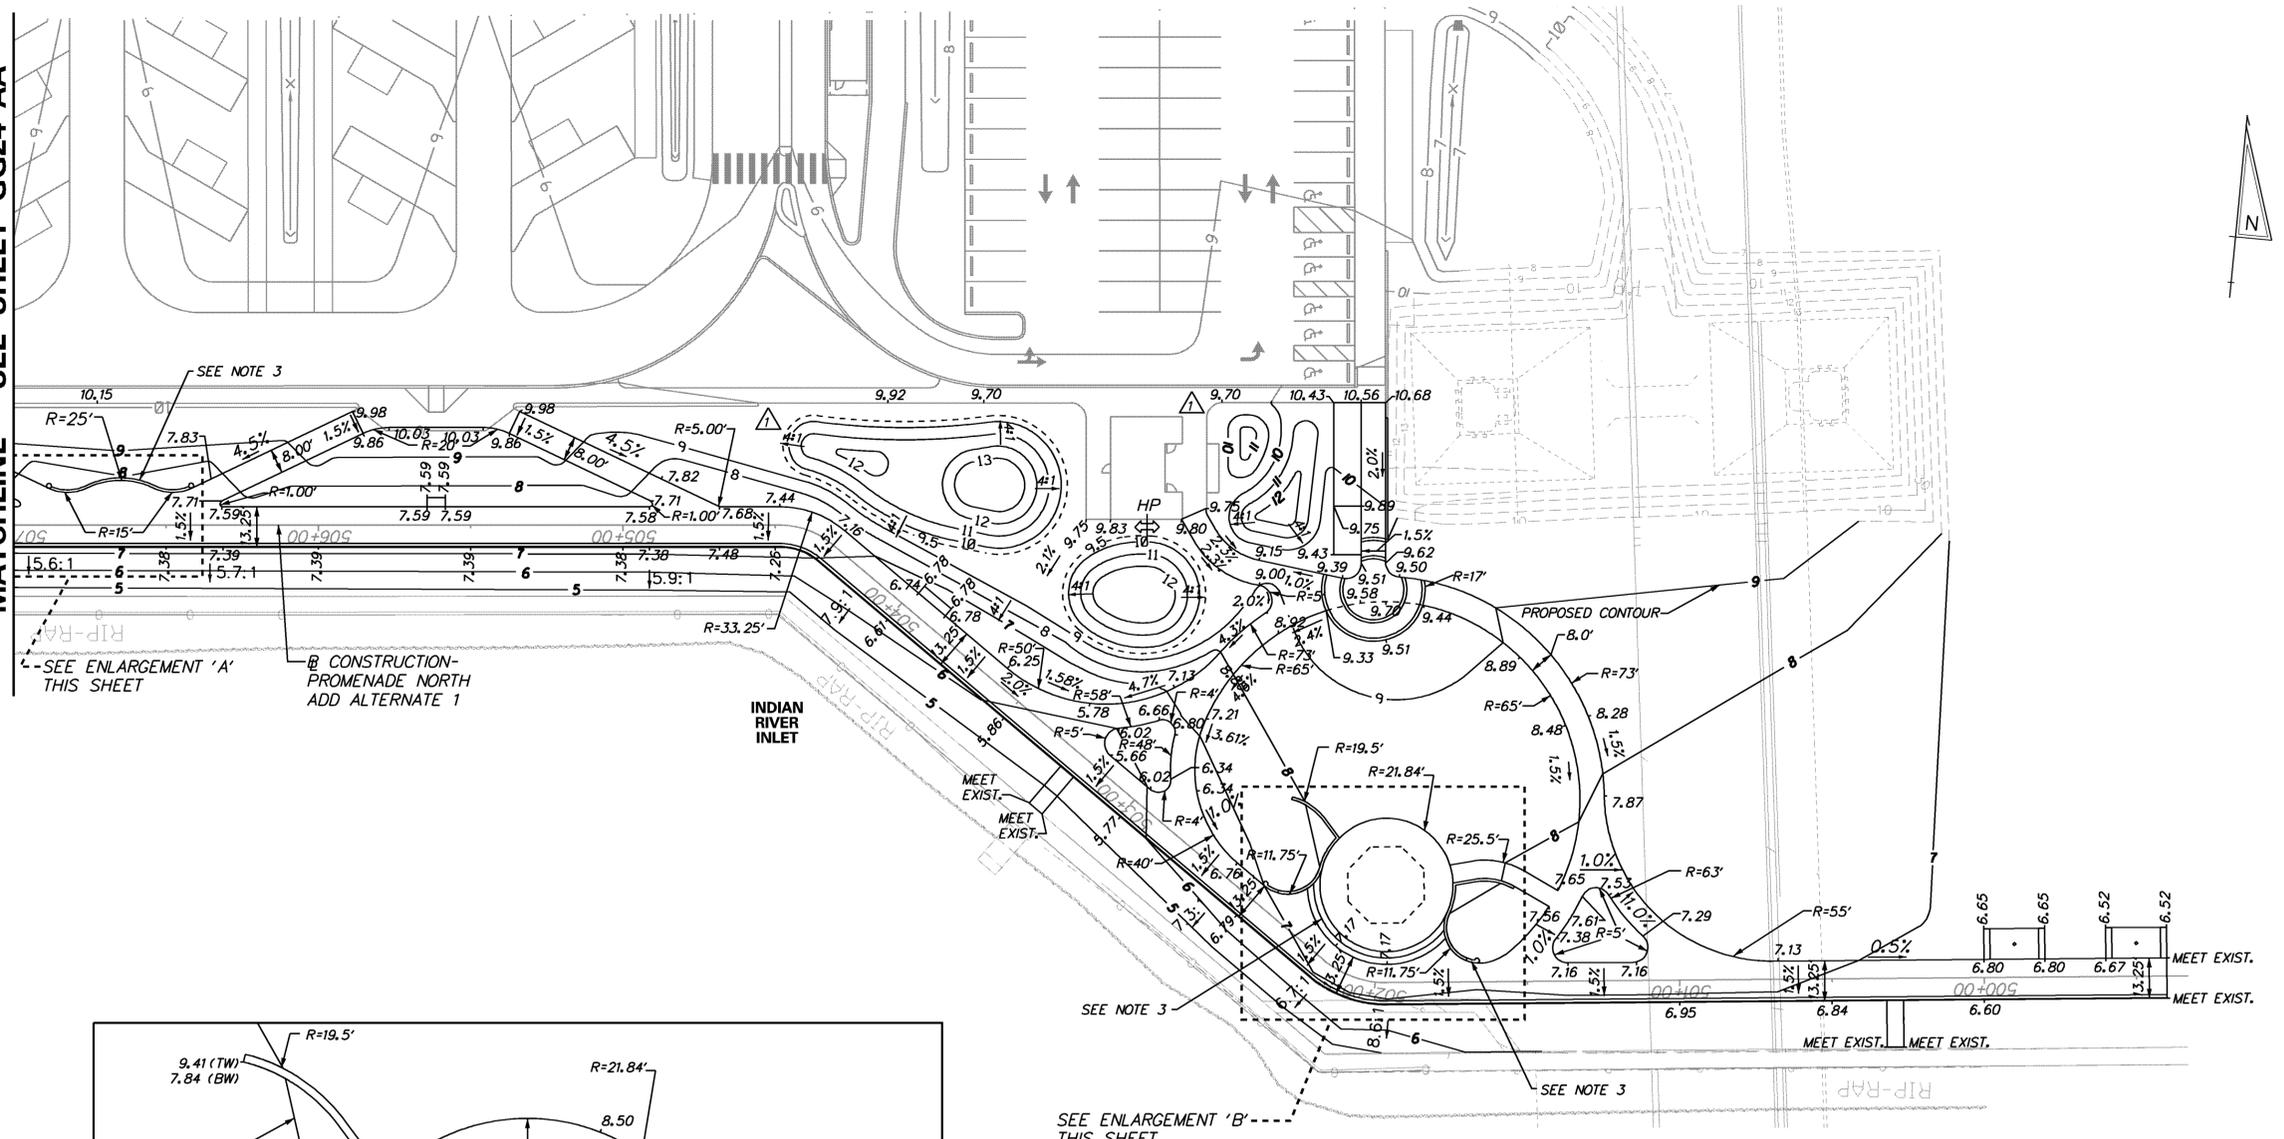


- NOTES:**
- UNLESS OTHERWISE NOTED, POINT GEOMETRY IS GIVEN TO EDGE OF PAVEMENT.
  - UNLESS OTHERWISE NOTED, RADI ARE GIVEN TO EDGE OF PAVEMENT.
  - ALL PROPOSED CONTOURS ARE SHOWN AT 1' INTERVALS.
  - PROPOSED CURB OR PAVEMENTS THAT TIE INTO EXISTING PAVEMENT OR EXISTING CURB SHALL MATCH THE EXISTING PAVEMENT OR CURB ELEVATIONS. POSITIVE DRAINAGE SHALL BE MAINTAINED.
  - EXISTING CONTOURS SHOWN AROUND AND UNDER BRIDGE ARE FROM CONTRACTS 26-073-01 AND 29-073-01.
  - SEE LANDSCAPE PLAN FOR STEP AND SEATWALL DETAILS.

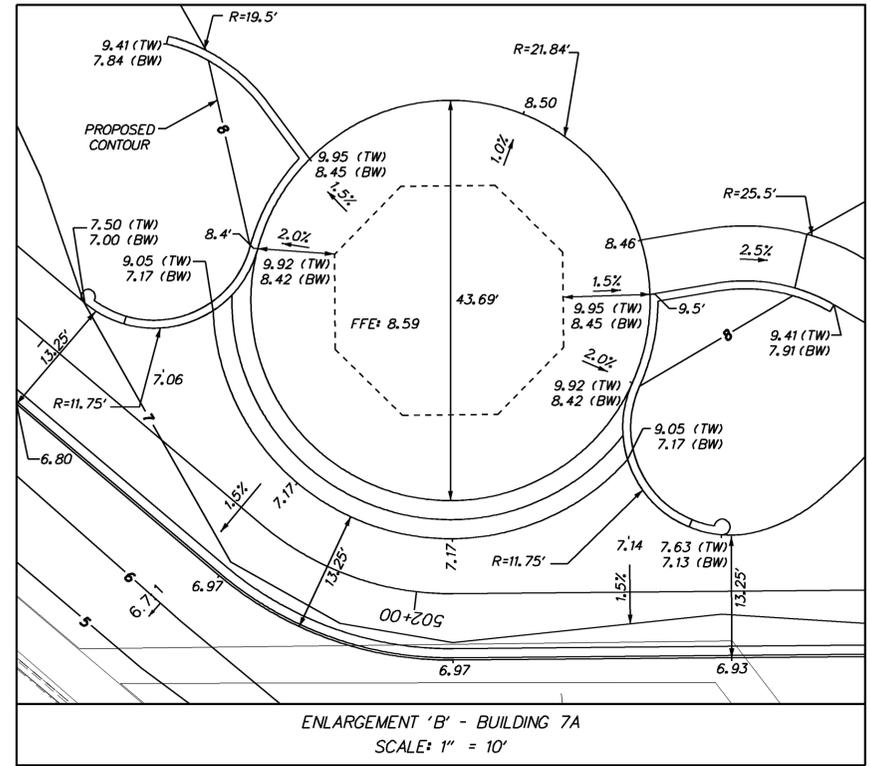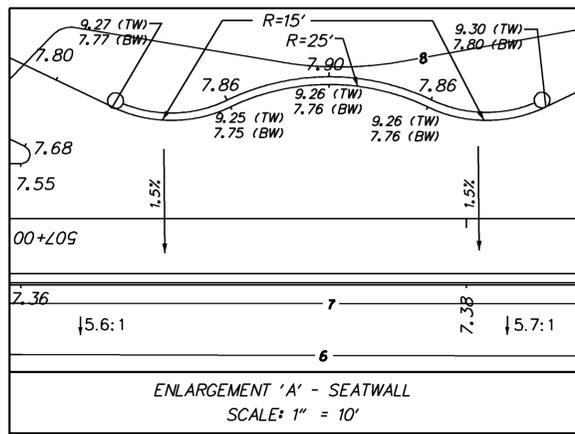

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ADDENDUMS / REVISIONS	
ADDENDUM NO. $\Delta$	REVISED GRADING
5/17/2013, RLS	



**INDIAN RIVER INLET  
PARK ENHANCEMENTS**

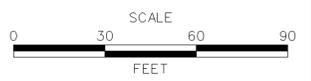
CONTRACT	BRIDGE NO.	<b>X</b>
T200507303	DESIGNED BY: RK&K	
COUNTY	CHECKED BY: RK&K	
SUSSEX		

**GRADES AND GEOMETRICS  
GRADING PLAN  
(ADD ALTERNATE 1)**

<b>GG22-AA</b>
SHEET NO.
65
TOTAL SHTS.
282

COORDINATE LIST			
POINT NO.	NORTHING	EASTING	ELEVATION
20750	222038.10	756459.41	7.76
20751	222039.38	756472.28	7.75
20752	222041.48	756493.75	7.76
20753	222042.74	756506.61	7.80
20754	222039.42	756516.59	7.71
20755	222037.56	756517.21	7.59
20757	222065.96	756560.60	9.86
20758	222068.73	756568.96	10.03
20759	222071.77	756599.63	10.03
20760	222070.67	756608.40	9.86
20763	222044.12	756583.90	7.59
20764	222044.70	756589.87	7.59
20766	222051.25	756656.54	7.58
20767	222053.19	756656.78	7.71
20768	222053.89	756678.39	7.68
20769	222053.61	756680.58	7.68
20770	222055.43	756699.12	7.44
20771	222049.73	756721.22	7.16
20774	222031.84	756747.27	6.78
20777	222025.29	756756.73	6.78
20778	222010.16	756778.70	6.25
20779	222022.14	756847.63	7.94
20780	222036.38	756861.13	8.80
20781	222045.27	756858.27	9.00
20782	222064.27	756830.86	9.63 9.80
20783	222068.52	756838.48	9.75
20784	222050.19	756885.39	9.39
20786	222055.65	756890.93	9.51
20787	222063.65	756890.14	9.67
20788	222074.32	756889.08	9.89
20793	222058.45	756890.65	9.57
20794	222064.43	756898.10	9.78
20795	222056.54	756898.88	9.51
20796	222052.41	756903.91	9.50
20798	222044.03	756912.37	9.44
20799	222039.12	756881.01	9.33
20800	221983.44	756978.47	7.81
20801	221939.44	757039.77	7.13
20802	221946.63	757107.16	6.80
20804	221930.64	757082.19	6.72
20805	221915.48	757083.79	MEET EXIST.
20806	221914.89	757078.28	MEET EXIST.
20807	221930.05	757076.67	6.75
20808	221954.28	756973.82	7.61
20809	221955.61	756982.48	7.53
20810	221943.37	756994.92	7.29
20811	221934.38	756992.47	7.16
20812	221932.13	756971.34	7.16
20813	221939.81	756966.61	7.38
20814	221955.32	756951.31	7.91
20815	221954.47	756931.16	8.45
20816	221960.79	756953.78	7.93
20817	221955.38	756965.75	7.65
20818	221962.16	756936.59	8.31
20819	221960.26	756929.59	8.46
20820	221965.57	756892.65	8.45
20821	221976.51	756875.82	7.84
20823	221947.51	756869.70	7.00
20824	221948.05	756883.75	7.17
20825	221936.32	756930.48	7.17
20826	221929.13	756941.52	7.13
20829	221976.85	756803.72	5.37
20830	221963.82	756794.68	MEET EXIST.
20831	221966.97	756790.11	MEET EXIST.
20832	221980.00	756799.15	5.37
20833	221975.25	756829.41	6.02
20834	221979.19	756835.63	6.34
20835	221993.81	756835.50	6.80
20836	221998.06	756829.96	6.66



MATCHLINE - SEE SHEET GG25-AA

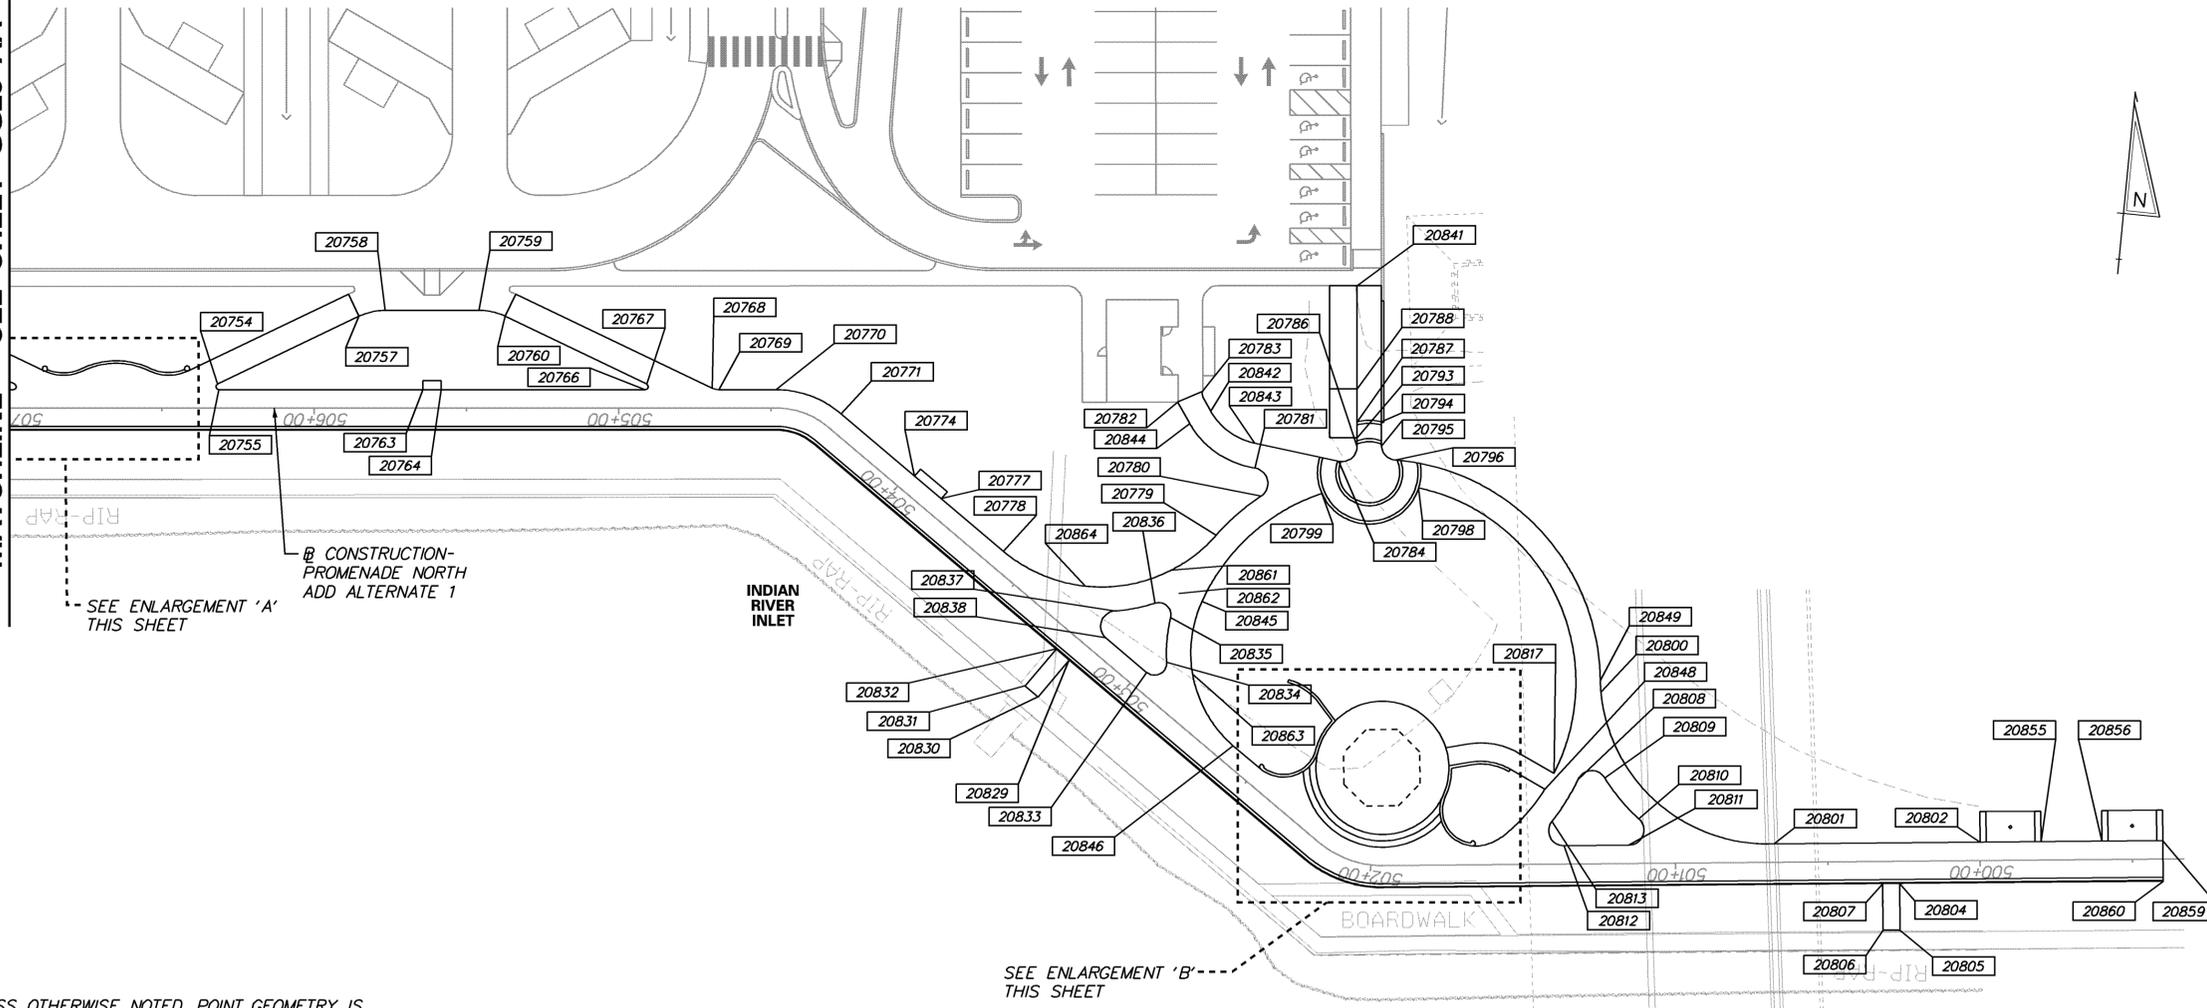

**NOTE:**

1. UNLESS OTHERWISE NOTED, POINT GEOMETRY IS GIVEN TO EDGE OF PAVEMENT.


COORDINATE LIST			
POINT NO.	NORTHING	EASTING	ELEVATION
20837	221994.20	756816.99	6.02
20838	221985.16	756815.01	5.66
20839	222032.90	756450.27	7.68
20840	222030.96	756450.03	7.55
20841	222108.03	756885.75	10.56
20842	222062.40	756842.05	9.57
20843	222053.36	756857.44	9.15
20844	222057.74	756835.55	9.48 9.62
20845	222000.09	756845.23	7.21
20846	221954.18	756860.01	6.76
20847	221971.16	756887.58	8.10
20848	221949.94	756963.22	7.56
20849	221987.15	756977.89	7.87
20850	221933.94	756951.73	7.26
20851	221956.37	756938.17	8.27
20852	221929.79	756945.19	7.14
20855	221948.75	757127.04	6.80
20856	221950.88	757146.93	6.67
20859	221953.00	757166.82	MEET EXIST.
20860	221939.83	757168.22	MEET EXIST.
20861	222009.23	756833.89	7.13
20862	222001.92	756837.41	7.05
20863	221976.23	756844.45	6.34
20864	222001.35	756806.73	5.78

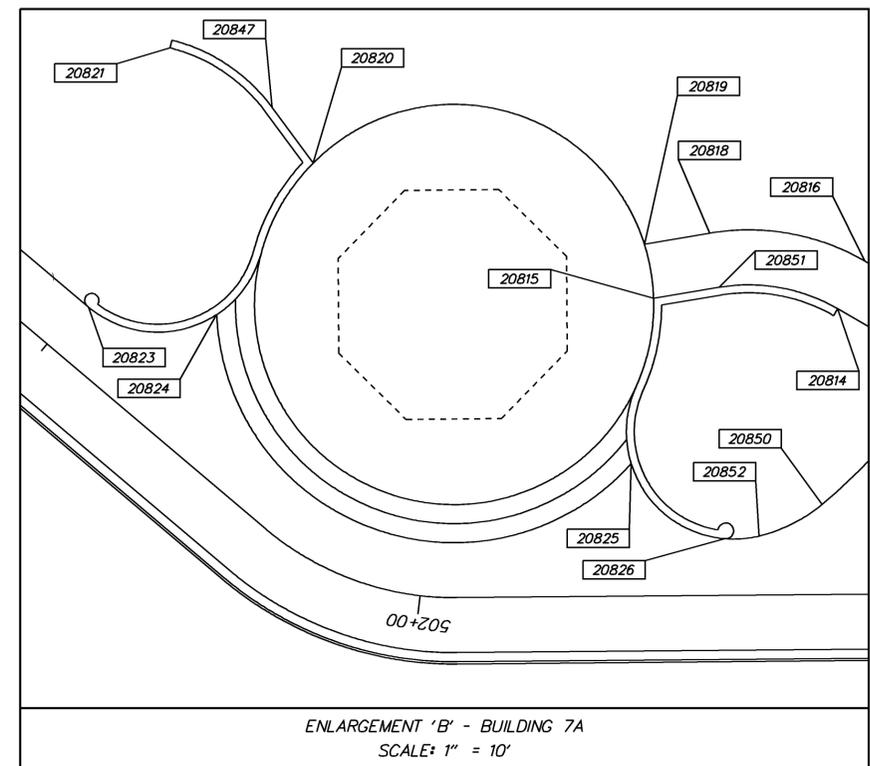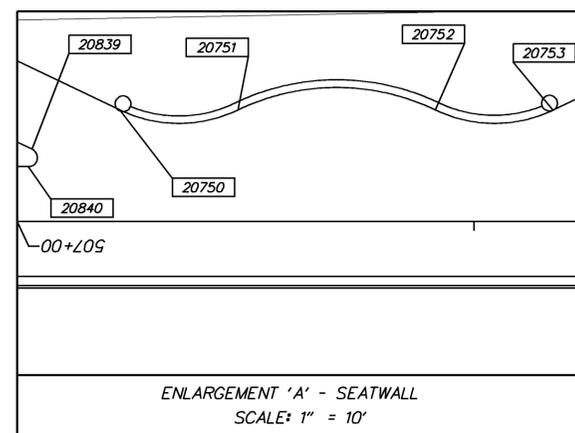

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ADDENDUMS / REVISIONS	
ADDENDUM NO. $\Delta$	REVISED ELEVATIONS
5/17/2013, RLS	





**INDIAN RIVER INLET  
PARK ENHANCEMENTS**

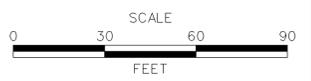
CONTRACT	BRIDGE NO.	<b>X</b>
T200507303	DESIGNED BY: RK&K	
COUNTY	CHECKED BY: RK&K	
SUSSEX		

**GRADES AND GEOMETRICS  
STAKEOUT PLAN  
(ADD ALTERNATE 1)**


<b>GG23-AA</b>
SHEET NO.
66
TOTAL SHTS.
282

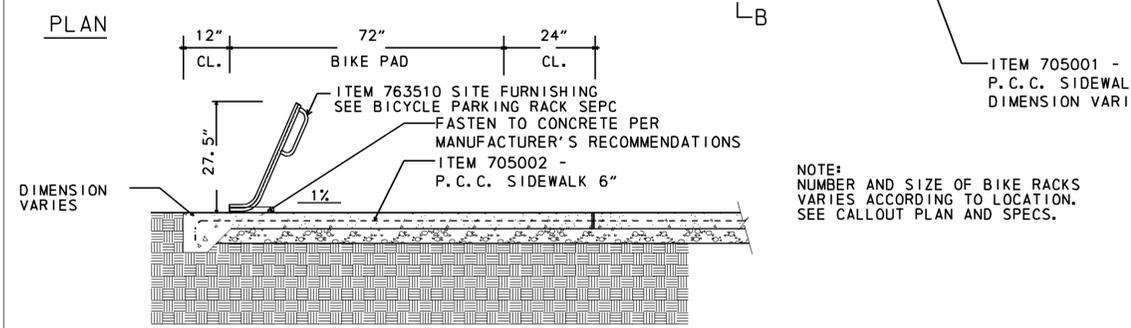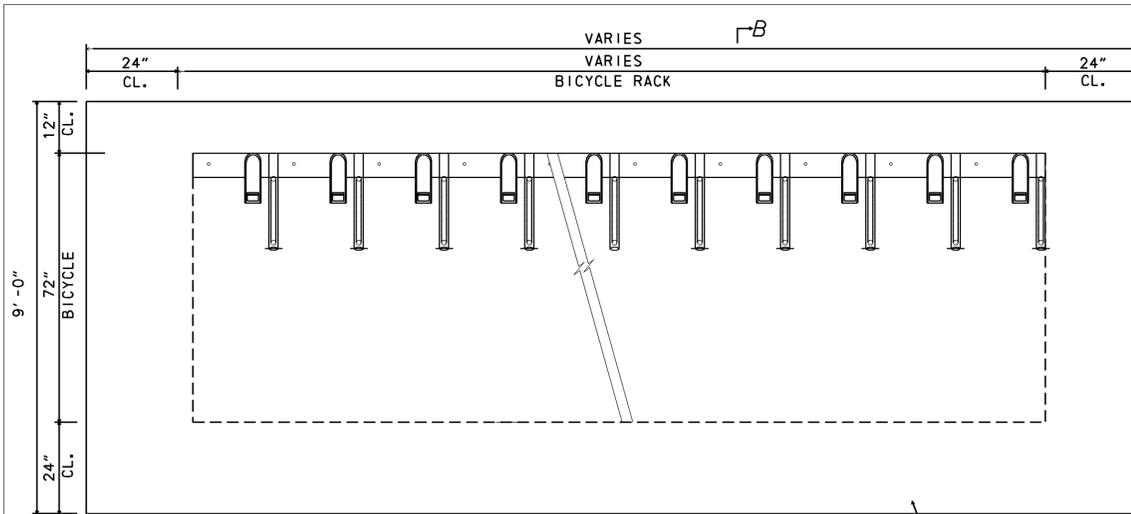


1 BIKE RACK  
LSD03 SCALE 1/2" = 1'

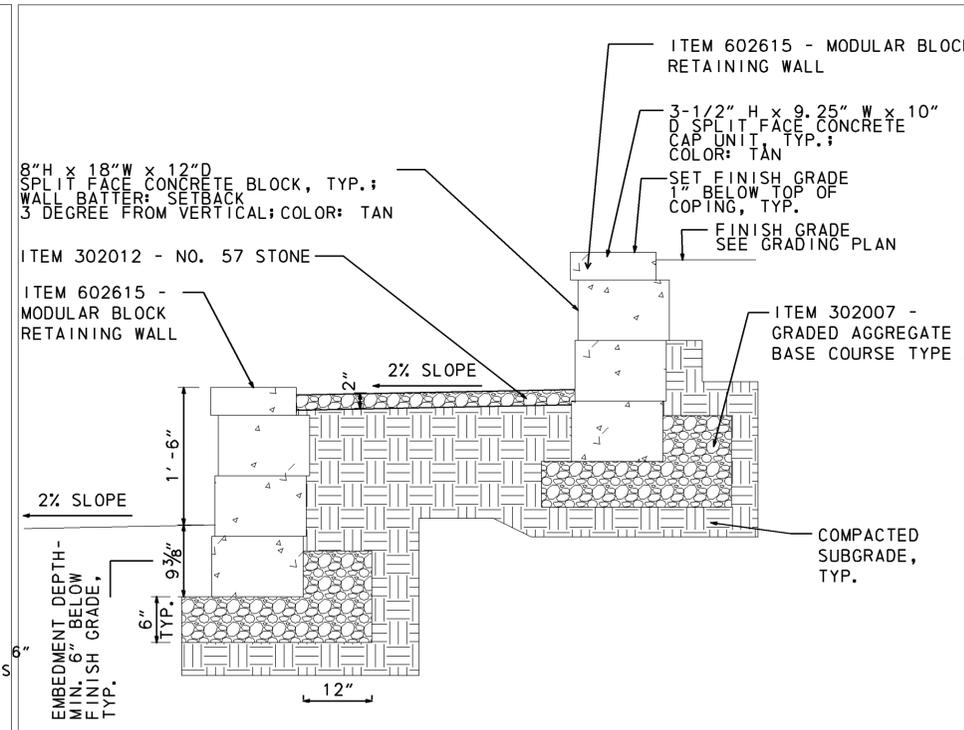


2 AMPHITHEATER SEATING  
LSD03 SCALE 1" = 1'

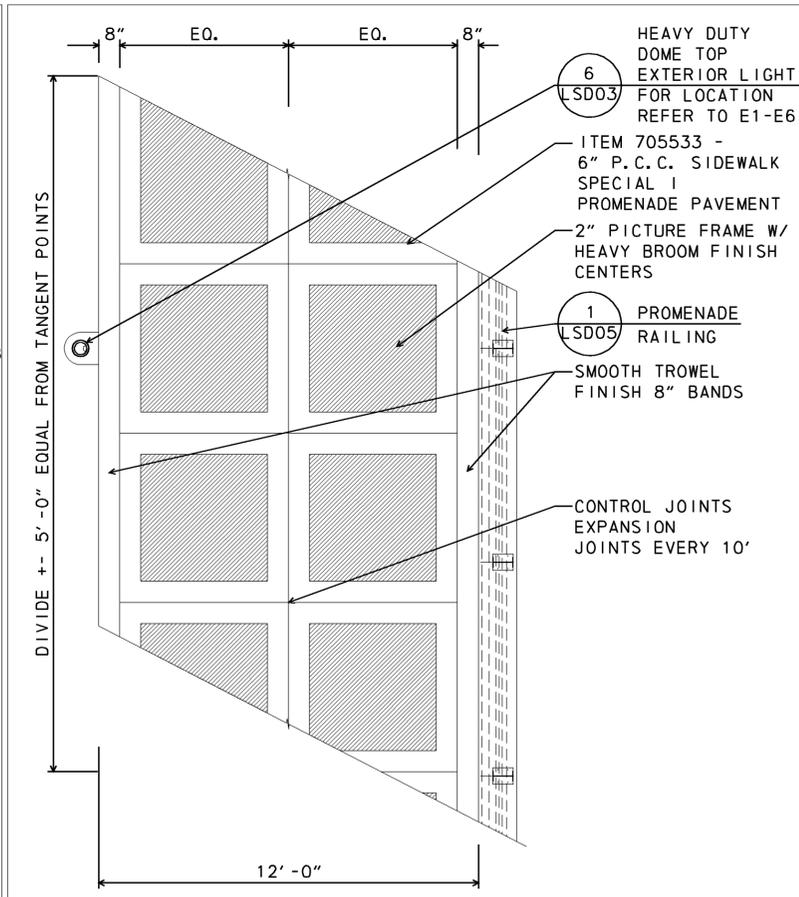


3 TYP. PROMENADE PAVEMENT PATTERN  
LSD03 SCALE 3" = 1'

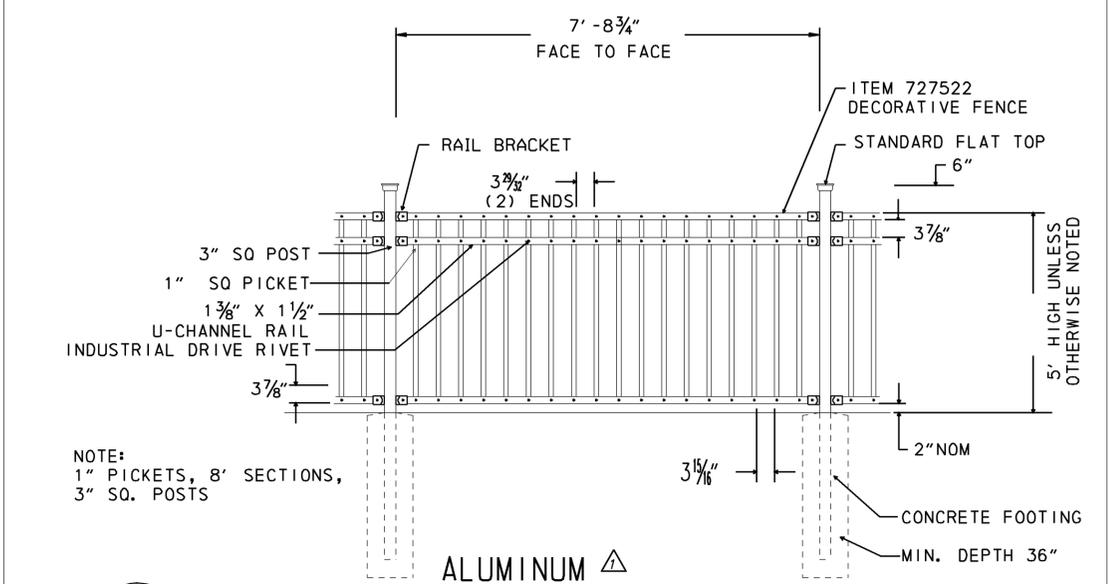

4 3 RAIL TUBULAR STEEL 5' FENCE  
LSD03 SCALE 1/2" = 1'

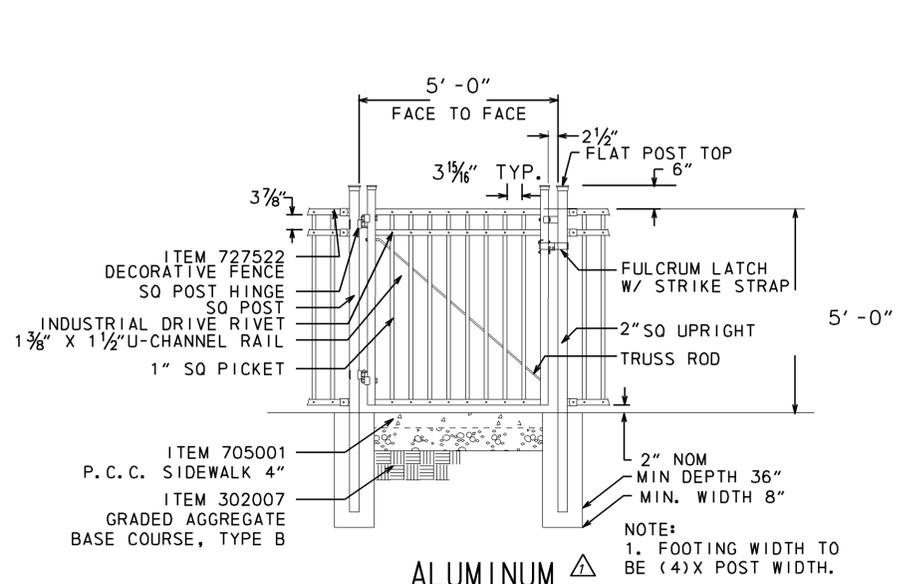


5 3 RAIL TUBULAR STEEL 5'-0" WIDE GATE  
LSD03 SCALE 1/2" = 1'

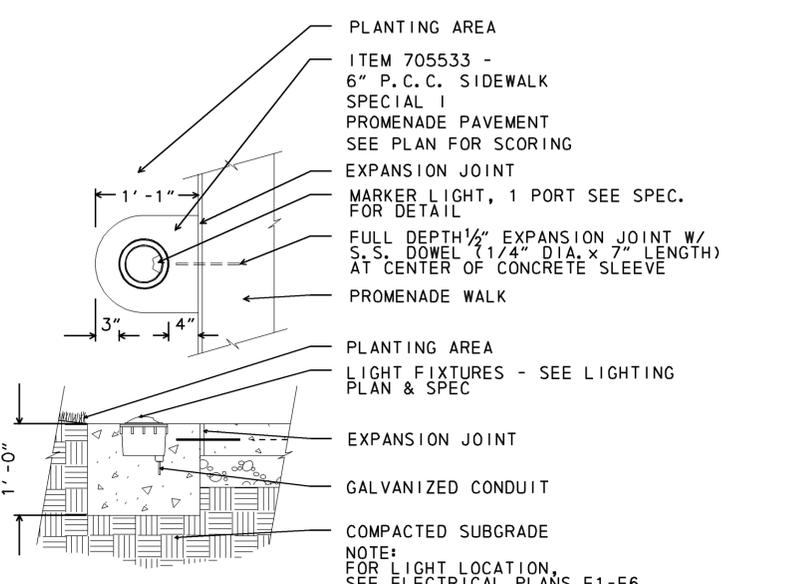


6 HEAVY DUTY DOME TOP EXTERIOR LIGHT  
LSD03 SCALE 1" = 1'

W:\MSVB\CELLS\PROVIDE\VB.CEL

5/17/2013 1:35:04 PM \\BALSRA02\2009\2009\09020\_IRP\CADD\CONTRACT\NUMBER\PLANS\CP\_E7\_IRP.DGN

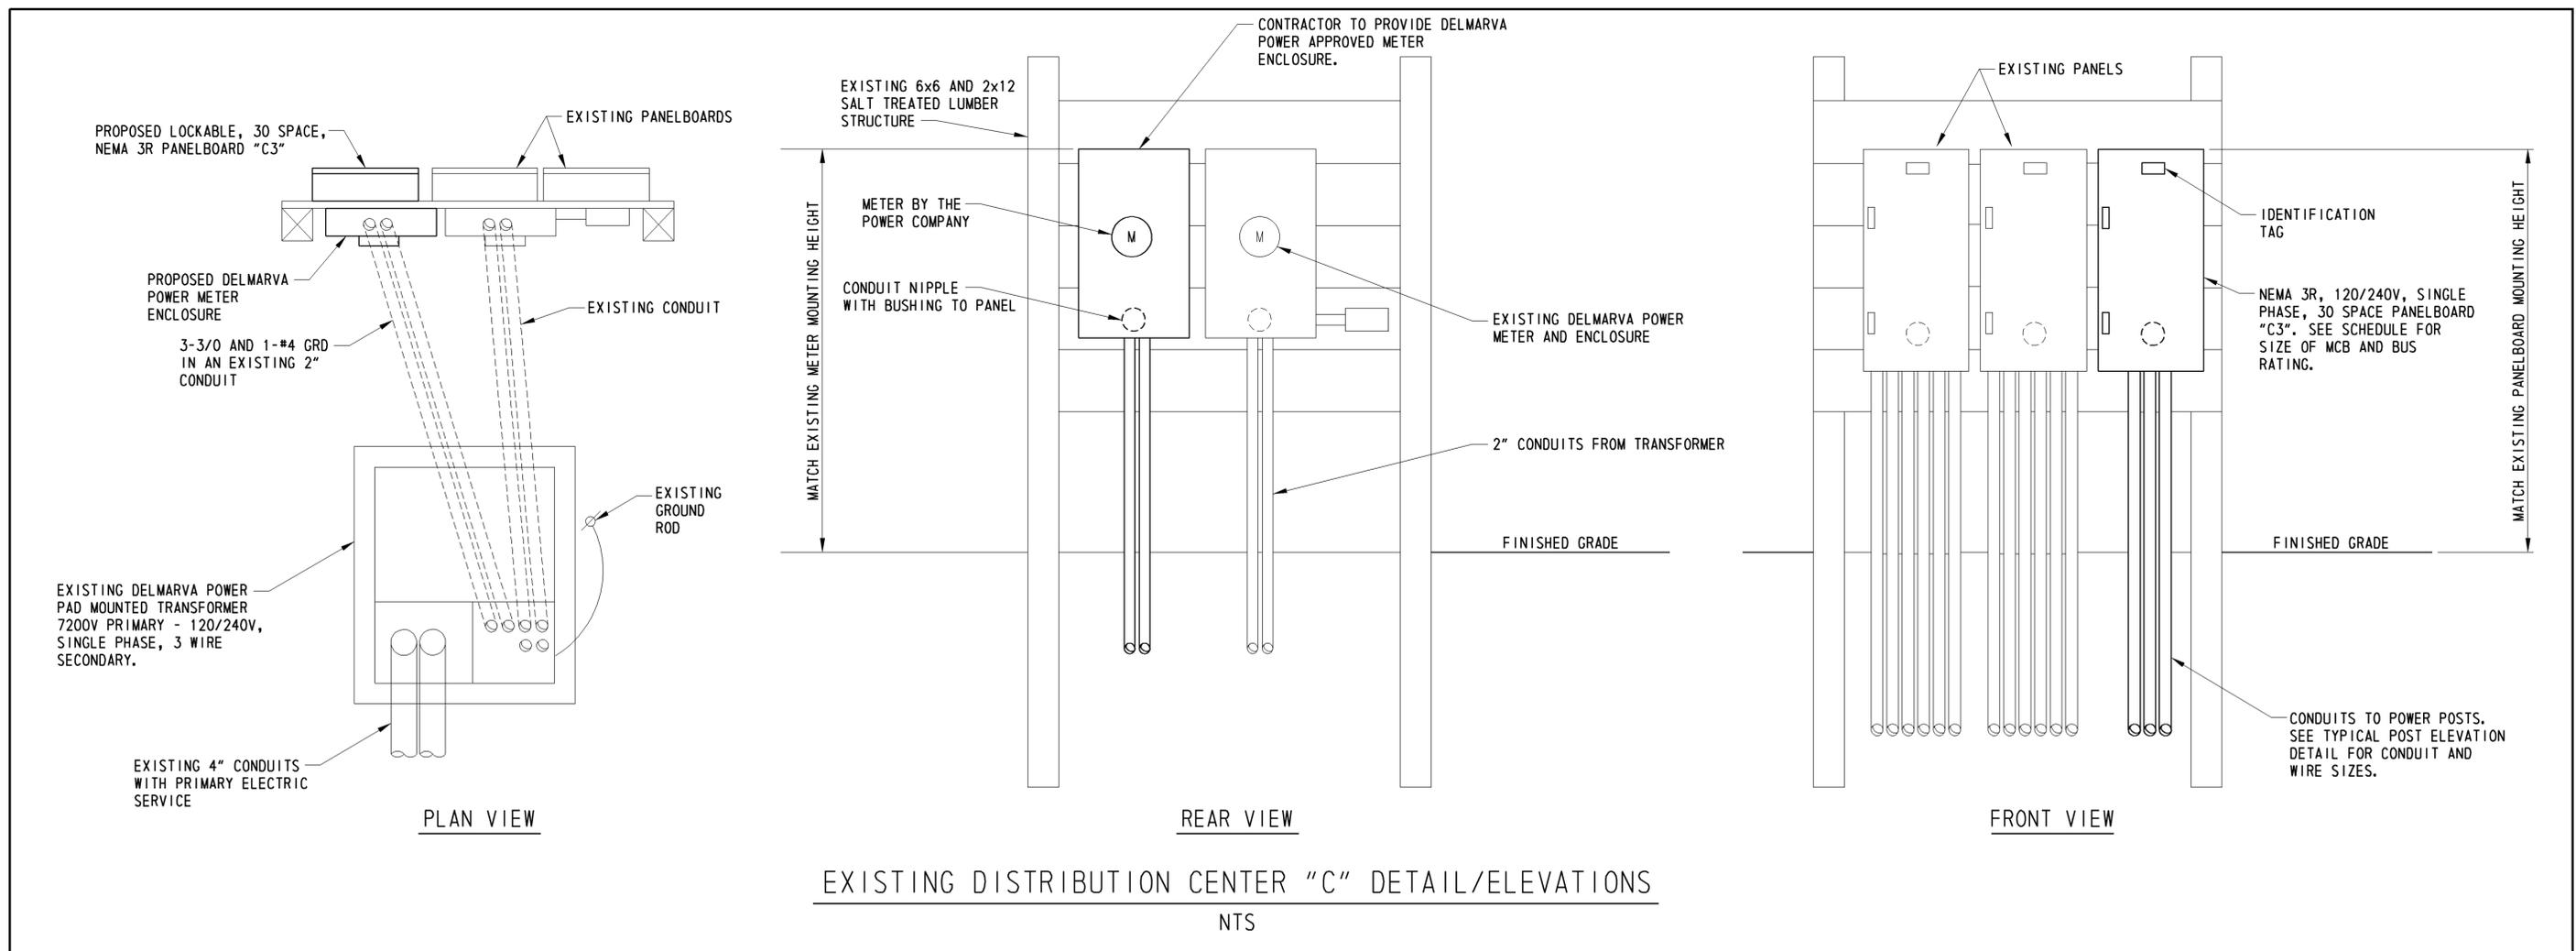


**EXISTING DISTRIBUTION CENTER "C" DETAIL/ELEVATIONS**  
NTS

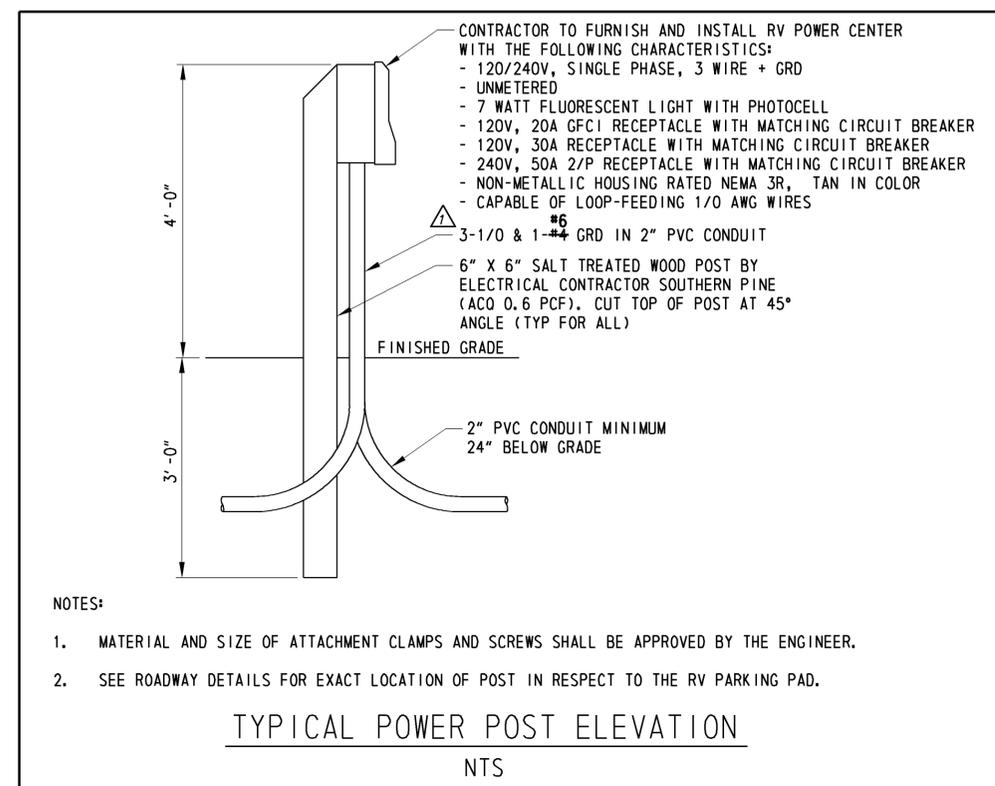

- NOTES:
- MATERIAL AND SIZE OF ATTACHMENT CLAMPS AND SCREWS SHALL BE APPROVED BY THE ENGINEER.
  - SEE ROADWAY DETAILS FOR EXACT LOCATION OF POST IN RESPECT TO THE RV PARKING PAD.

**TYPICAL POWER POST ELEVATION**  
NTS

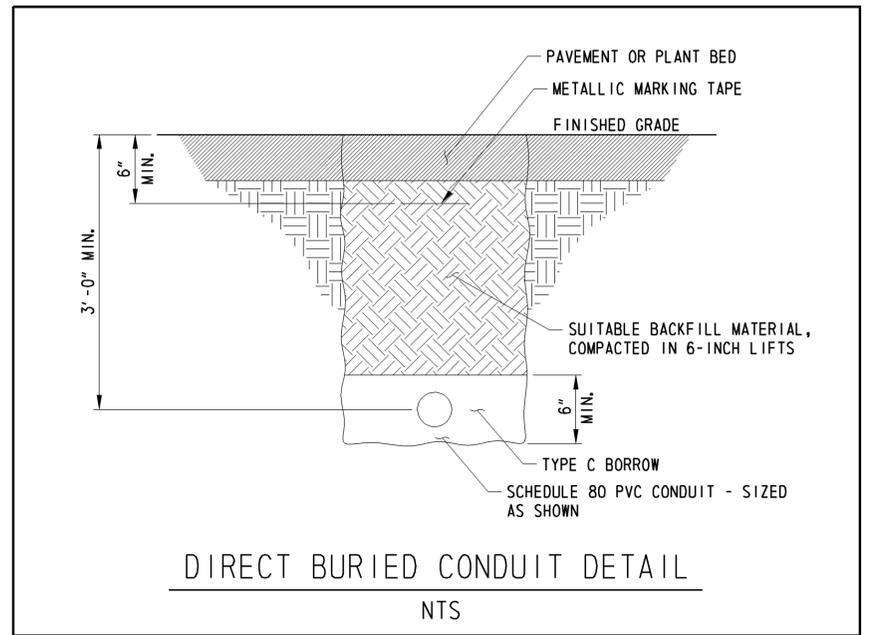

**DIRECT BURIED CONDUIT DETAIL**  
NTS

ADDENDUMS / REVISIONS	
ADDENDUM NO. $\Delta$	REVISED NOTE
5/17/2013, RLS	


**NOT TO SCALE**

**INDIAN RIVER INLET  
PARK ENHANCEMENTS**


CONTRACT	BRIDGE NO.	<b>X</b>
T200507303	DESIGNED BY: RK&K	
COUNTY	CHECKED BY: RK&K	
SUSSEX		

**ELECTRICAL DETAILS**

<b>E7</b>
SHEET NO.
159
TOTAL SHTS.
282

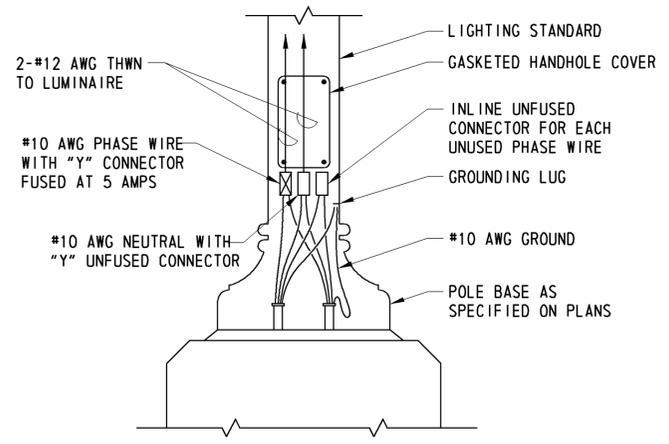


TYPICAL LUMINAIRE CONNECTION  
NTS

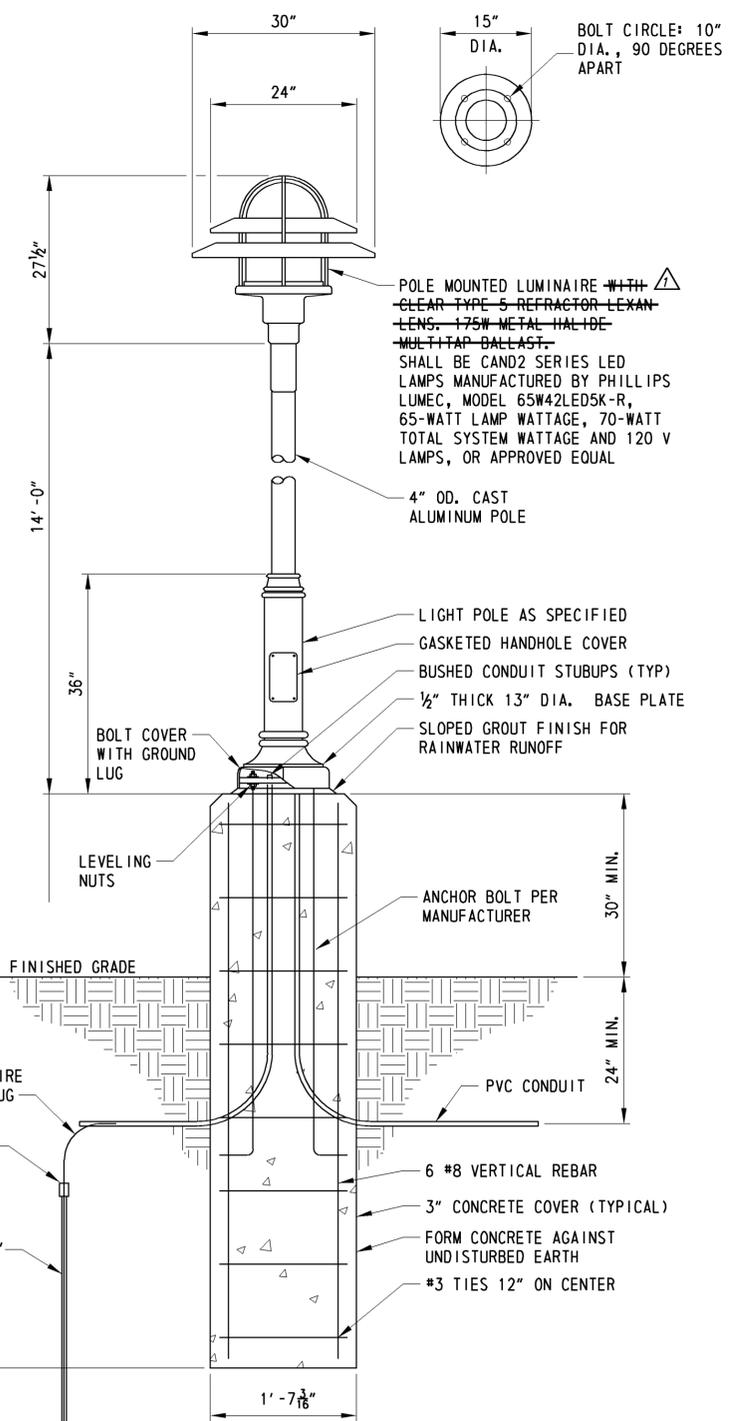


- NOTES:
1. ALL REINFORCING STEEL TO BE ASTM A615, GRADE 60.
  2. ALL CONCRETE SHALL BE CLASS A.
  3. GROUNDWATER MAY BE ENCOUNTERED DURING EXCAVATION. IT IS THE CONTRACTOR'S RESPONSIBILITY TO USE PROPER DEWATERING TECHNIQUES DURING CONSTRUCTION.
  4. TEMPORARY CASING WILL BE REQUIRED FOR THE DRILLED SHAFT FOUNDATION IF UNSTABLE MATERIAL IS ENCOUNTERED DURING EXCAVATION.

TYPICAL POST MOUNTED LIGHT FIXTURE DETAIL  
NTS

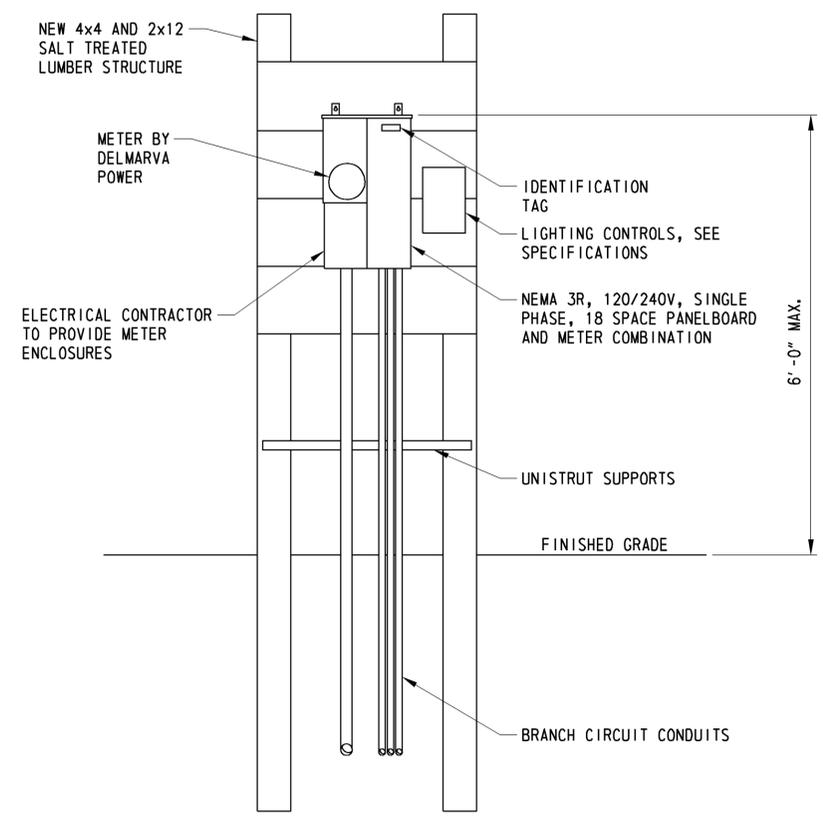

SOUTH SIDE PROMENADE PANELBOARD ELEVATION  
NTS

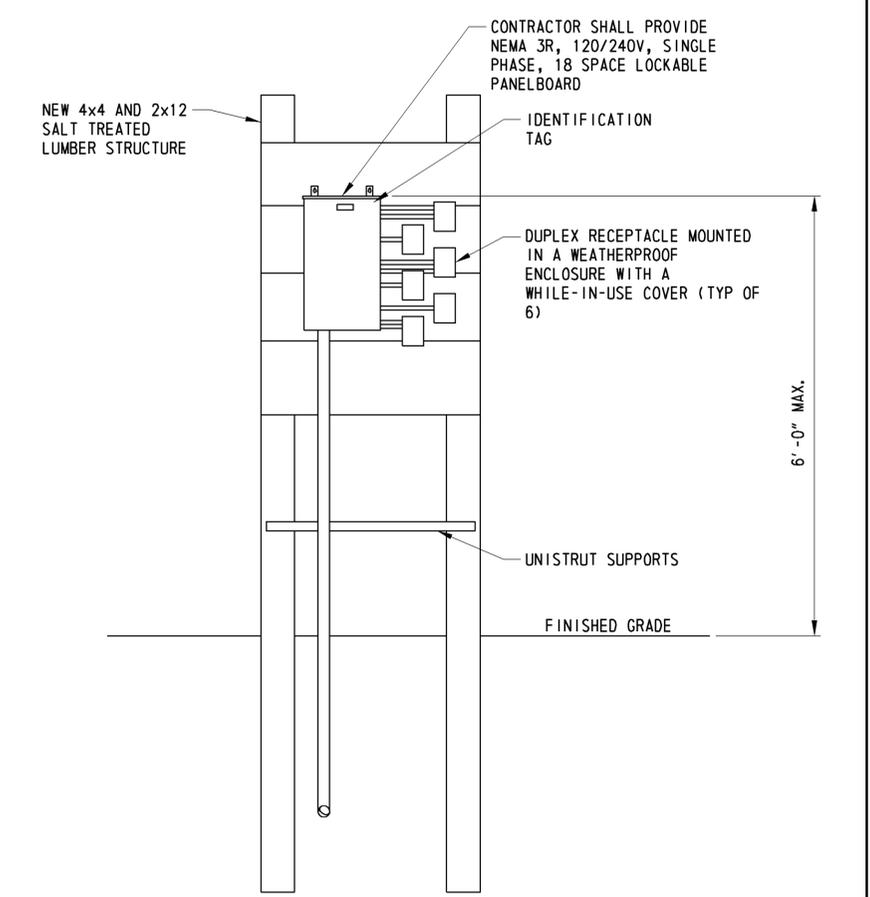


SOUTH SIDE AMPHITHEATER PANELBOARD ELEVATION  
NTS

5/17/2013 1:41:27 PM \\BALSRA02\2009\2009\09020\_IRP\CADD\CONTRACTNUMBER\PLANS\CP\_E9\_IRP.DGN


MATCHLINE - SEE SHEET UT02

MATCHLINE - SEE SHEET UT02

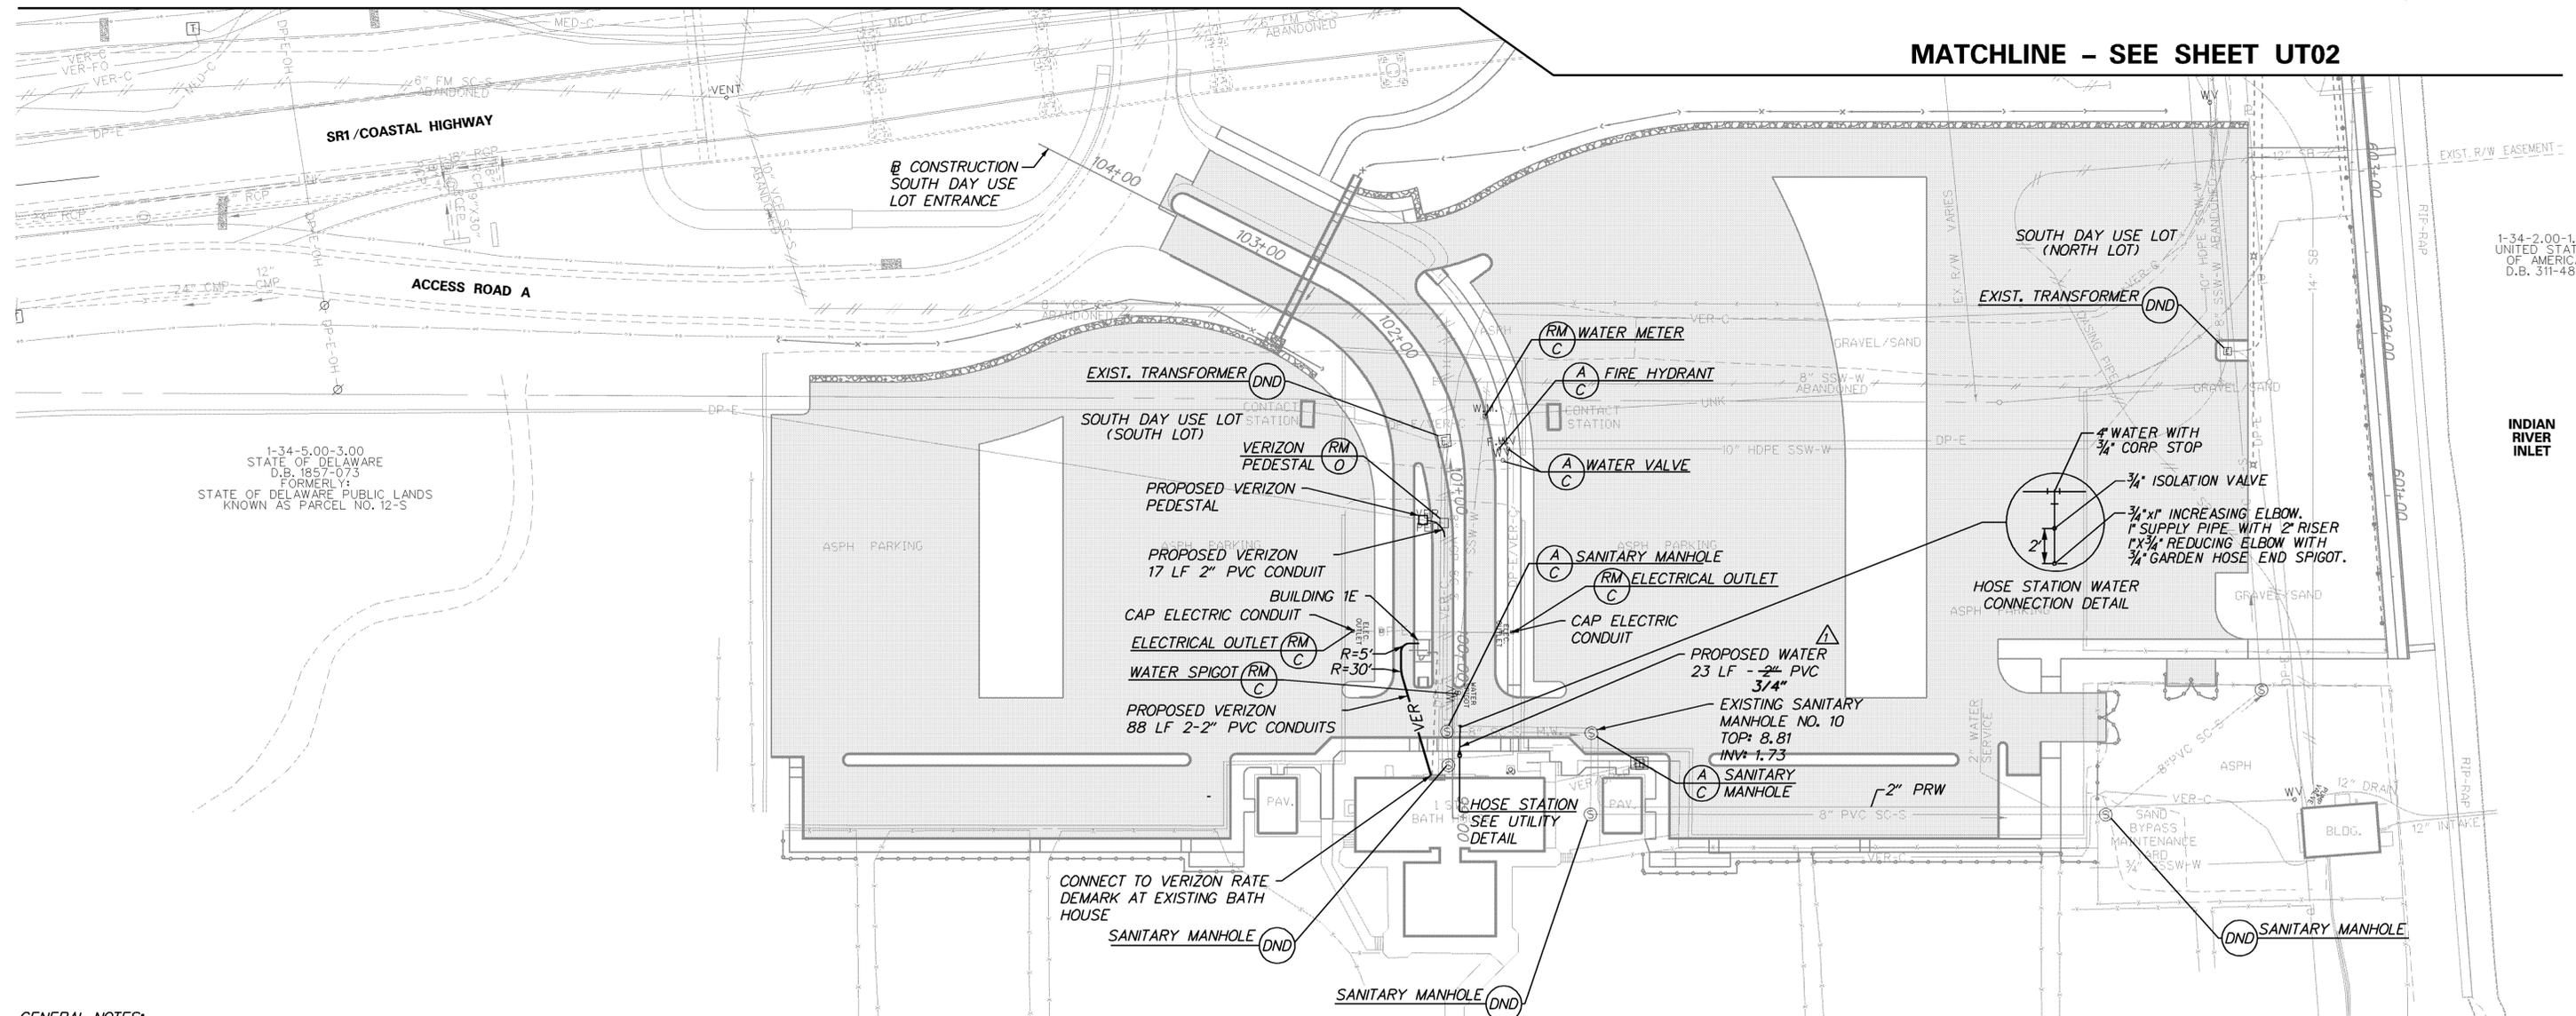


**GENERAL NOTES:**

1. ALL CONSTRUCTION SHALL BE IN ACCORDANCE WITH THE LATEST EDITIONS OF THE SUSSEX COUNTY STANDARD SPECIFICATIONS FOR DESIGN AND CONSTRUCTION OF ORDINANCE NO. 38 PROJECTS AND THE PROJECT TECHNICAL SPECIFICATIONS, IN CASE OF CONFLICT, THE PROJECT TECHNICAL SPECIFICATIONS SHALL GOVERN.
2. THE LOCATION OF ALL UNDERGROUND UTILITIES AND FEATURES SHOWN ARE APPROXIMATE ONLY AND NO GUARANTEE IS MADE THAT ALL EXISTING UTILITIES ARE SHOWN ON THE PLAN. THE CONTRACTOR SHALL FIELD VERIFY BOTH HORIZONTAL AND VERTICAL LOCATIONS OF ALL EXISTING UTILITIES PRIOR TO BEGINNING ANY CONSTRUCTION AT NO ADDITIONAL COST. THE CONTRACTOR SHALL CONTACT MISS UTILITY (1-800-282-8555) PRIOR TO THE BEGINNING OF ANY CONSTRUCTION ACTIVITY.
3. BUTTRESSES NOT SHOWN. ALL BUTTRESSES TO BE CONSTRUCTED IN ACCORDANCE WITH THE SUSSEX COUNTY STANDARD SPECIFICATION FOR DESIGN AND CONSTRUCTION OF ORDINANCE 38 PROJECTS.
4. FULL DEPTH PAVEMENT PATCHING SECTION SHALL MATCH THE PROJECT FULL DEPTH PAVEMENT SECTION.
5. SEE ARCHITECTURAL/MEP PLANS FOR BUILDING 1E UTILITIES AND PIPING
6. SEE ELECTRICAL PLANS FOR ELECTRICAL LAYOUT AND DETAILS.
7. ALL PROPOSED CIVIL/SITE UTILITIES TERMINATE 5' FROM FACE OF PROPOSED OR EXISTING BUILDING.
8. SEE UTILITY RELOCATION DETAILS FOR VERIZON DIRECT BURIED CONDUIT DETAIL.

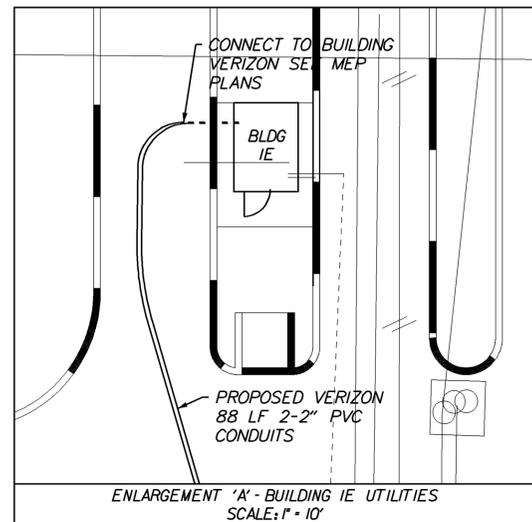

ADDENDUMS / REVISIONS	
ADDENDUM NO. $\Delta$	REVISED NOTE
5/17/2013, RLS	

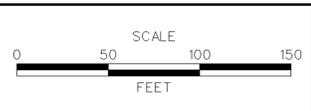

CONTRACT	BRIDGE NO.	<b>X</b>
T200507303	DESIGNED BY: RK&K	
COUNTY	CHECKED BY: RK&K	
SUSSEX		

<b>UTILITY RELOCATION PLAN</b> (WATER, SEWER, VERIZON)	
UT01	SHEET NO.
	168
	TOTAL SHTS.
	282


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MATCHLINE - SEE SHEET UT03



1-34-5.00-2.00  
STATE OF DELAWARE  
D.B. 1857-073  
FORMERLY:  
STATE OF DELAWARE PUBLIC LANDS  
KNOWN AS PARCEL NO. 11-5


\* CONTRACTOR TO FIELD VERIFY EXISTING SANITARY SYSTEM AND VERIFY THAT THE PROPOSED BUILDING SANITARY SYSTEM WILL PROVIDE POSITIVE OUTFLOW. CONTRACTOR TO SUBMIT VERIFICATION TO THE ENGINEER PRIOR TO BEGINNING CONSTRUCTION OR ORDERING ANY MATERIAL ASSOCIATED WITH THE PROPOSED SANITARY SYSTEM

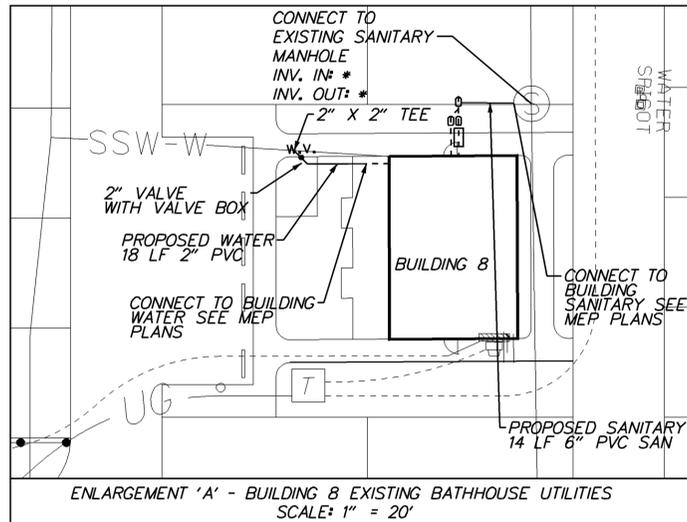

ENLARGEMENT 'A' - BUILDING 8 EXISTING BATHHOUSE UTILITIES  
SCALE: 1" = 20'

GENERAL NOTES:

1. ALL CONSTRUCTION SHALL BE IN ACCORDANCE WITH THE LATEST EDITIONS OF THE SUSSEX COUNTY STANDARD SPECIFICATIONS FOR DESIGN AND CONSTRUCTION OF ORDINANCE NO. 38 PROJECTS AND THE PROJECT TECHNICAL SPECIFICATIONS, IN CASE OF CONFLICT, THE PROJECT TECHNICAL SPECIFICATIONS SHALL GOVERN.
2. THE LOCATION OF ALL UNDERGROUND UTILITIES AND FEATURES SHOWN ARE APPROXIMATE ONLY AND NO GUARANTEE IS MADE THAT ALL EXISTING UTILITIES ARE SHOWN ON THE PLAN. THE CONTRACTOR SHALL FIELD VERIFY BOTH HORIZONTAL AND VERTICAL LOCATIONS OF ALL EXISTING UTILITIES PRIOR TO BEGINNING ANY CONSTRUCTION AT NO ADDITIONAL COST. THE CONTRACTOR SHALL CONTACT MISS UTILITY (1-800-282-8555) PRIOR TO THE BEGINNING OF ANY CONSTRUCTION ACTIVITY.
3. BUTTRESSES NOT SHOWN. ALL BUTTRESSES TO BE CONSTRUCTED IN ACCORDANCE WITH THE SUSSEX COUNTY STANDARD SPECIFICATION FOR DESIGN AND CONSTRUCTION OF ORDINANCE 38 PROJECTS.
4. FULL DEPTH PAVEMENT PATCHING SECTION SHALL MATCH THE PROJECT FULL DEPTH PAVEMENT SECTION.
5. SEE ARCHITECTURAL/MEP PLANS FOR BUILDING 8 UTILITIES AND PROPANE PIPING.
6. SEE ELECTRICAL PLANS FOR ELECTRICAL LAYOUT AND DETAILS.
7. ALL PROPOSED CIVIL/SITE UTILITIES TERMINATE 5' FROM FACE OF PROPOSED OR EXISTING BUILDING.

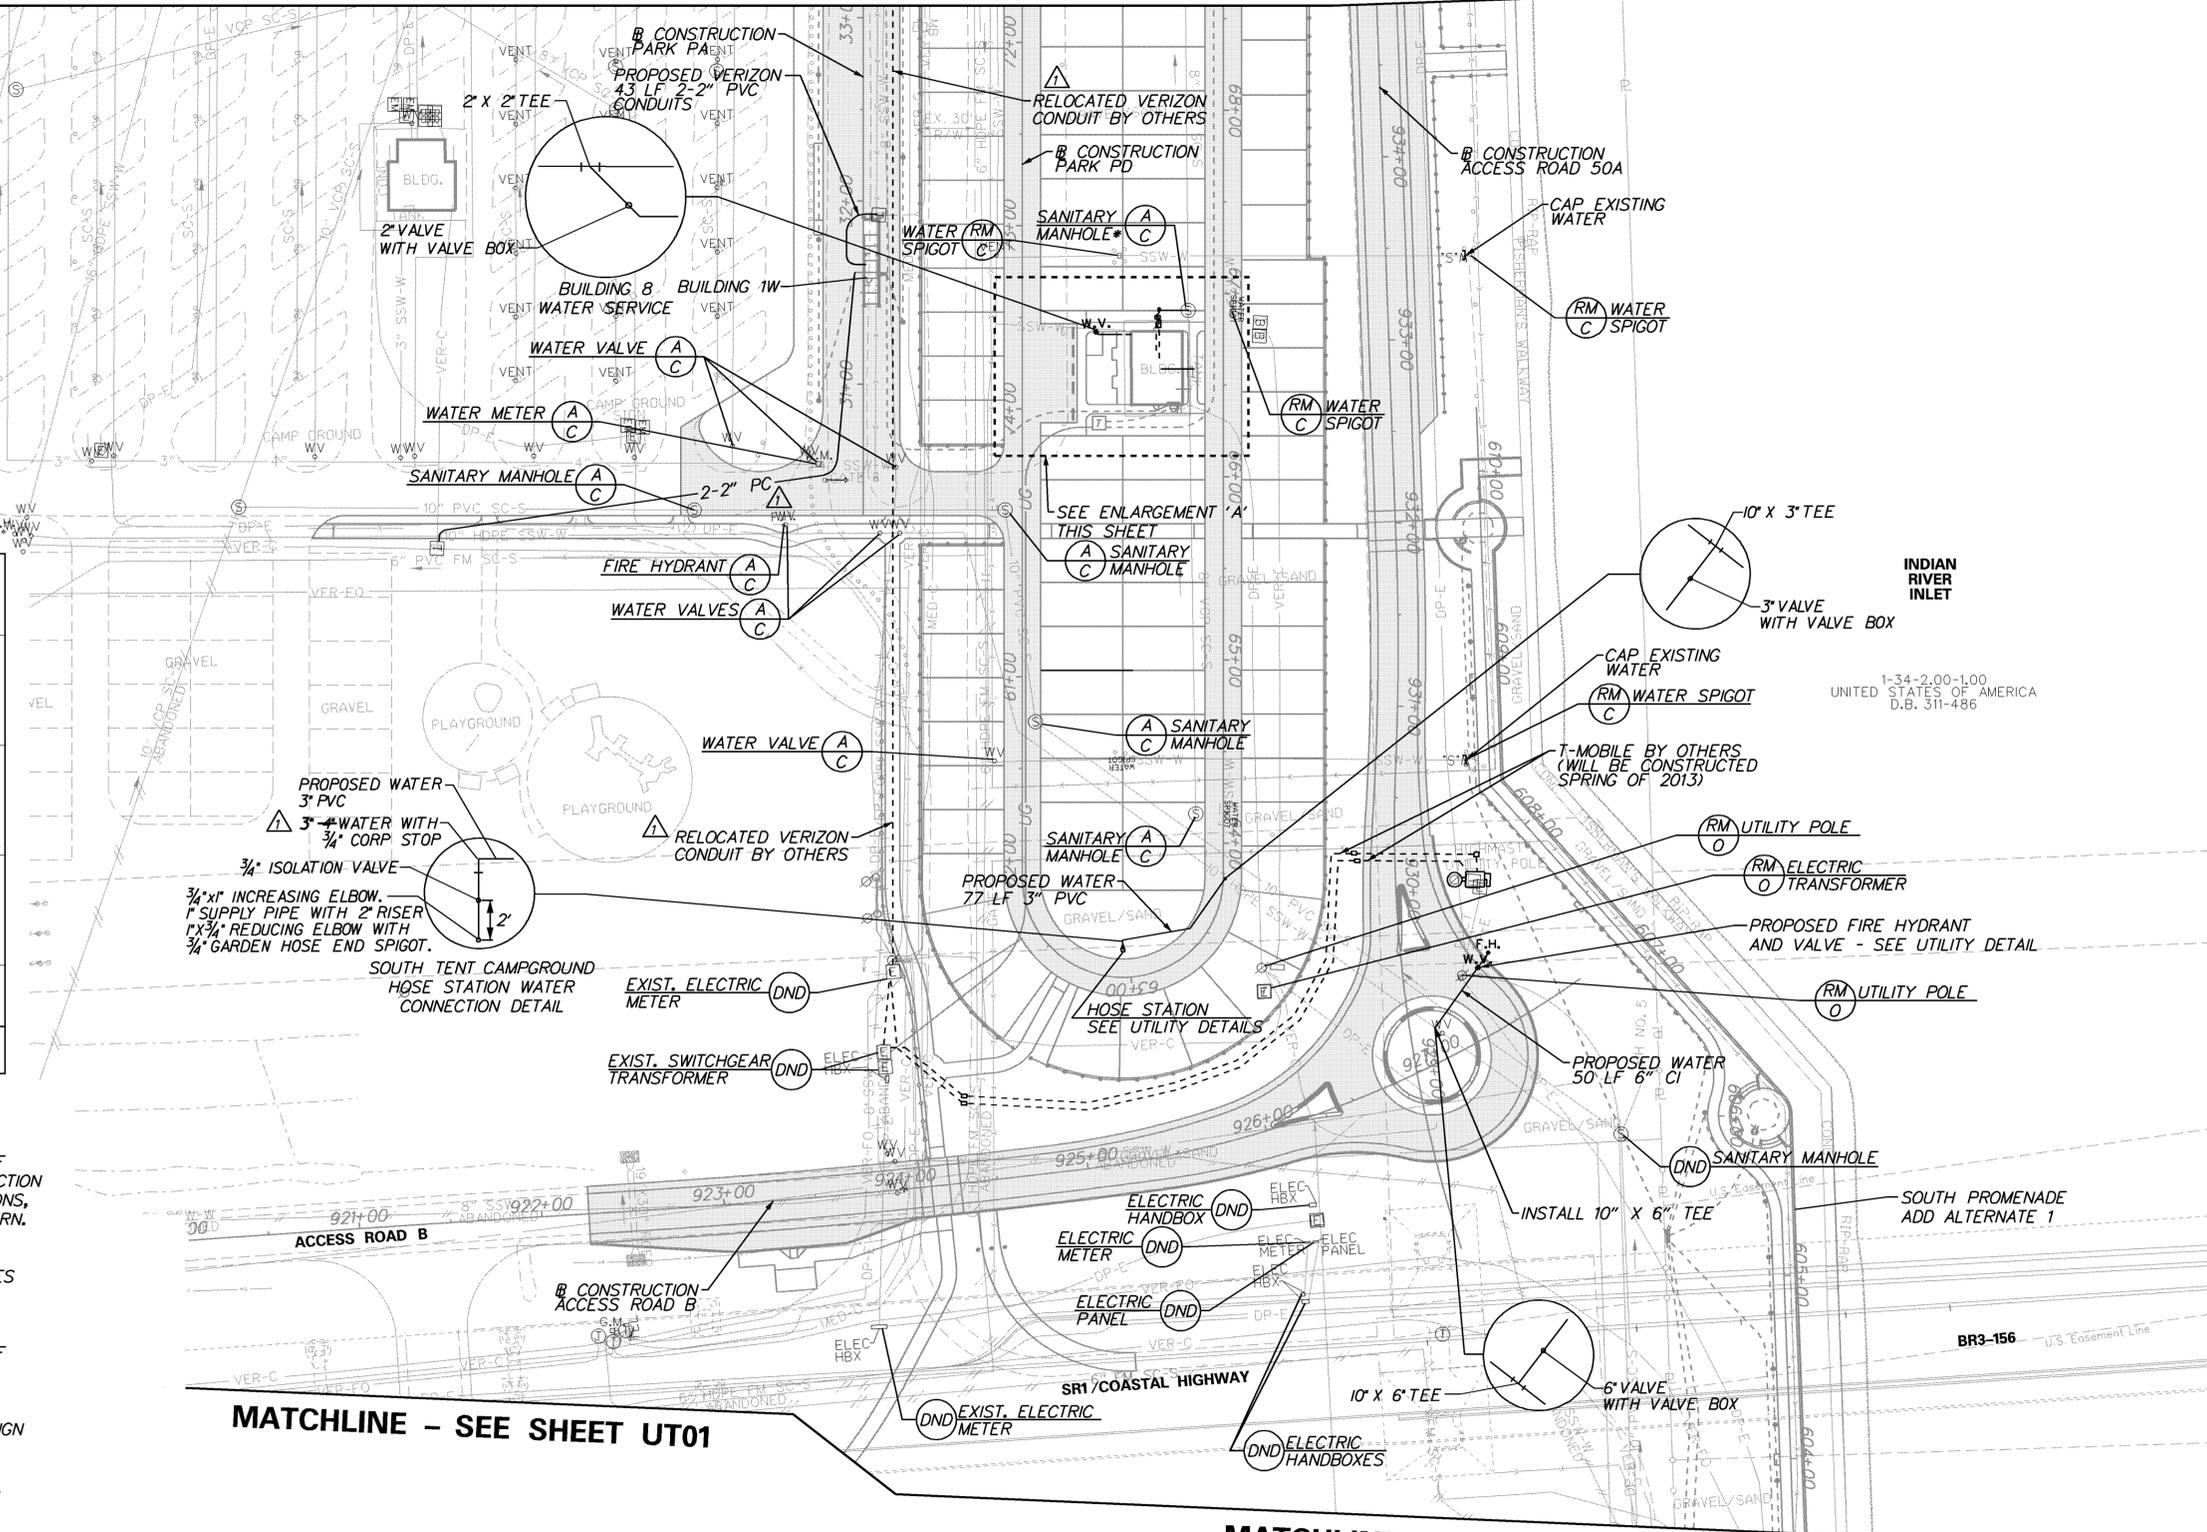


MATCHLINE - SEE SHEET UT01

MATCHLINE - SEE SHEET UT01



ADDENDUMS / REVISIONS	
ADDENDUM NO. $\Delta$	REVISED/ADDED NOTES
5/17/2013, RLS	

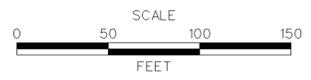


INDIAN RIVER INLET  
PARK ENHANCEMENTS

CONTRACT	BRIDGE NO.	X
T200507303	DESIGNED BY:	RK&K
COUNTY	CHECKED BY:	RK&K
SUSSEX		


UTILITY RELOCATION PLAN  
(WATER, SEWER, VERIZON)

UT02
SHEET NO.
169
TOTAL SHTS.
282


5/17/2013 1:56:58 PM \\BALSRV02\2005\2005\09020\IRP\CADD\CONTRACT\NUMBER\PLANS\CP\_UT02\_IRP.DGN

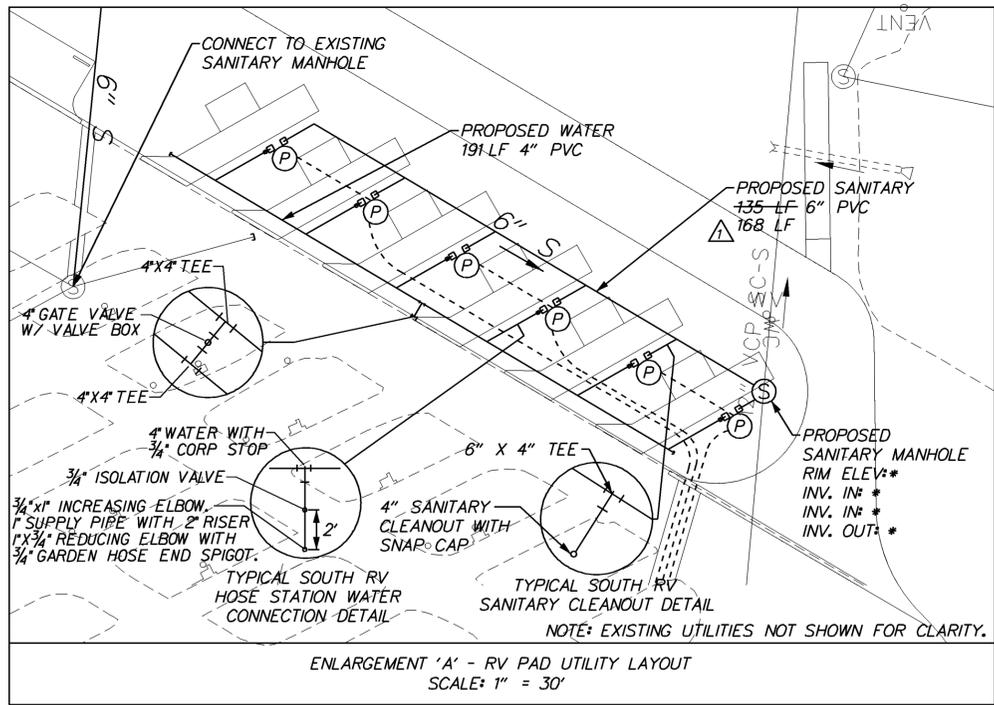

\* CONTRACTOR TO FIELD VERIFY EXISTING SANITARY SYSTEM AND VERIFY THE BUILDING PROPOSED SANITARY SYSTEM WILL PROVIDE POSITIVE OUTFLOW. CONTRACTOR TO SUBMIT VERIFICATION TO THE ENGINEER PRIOR TO BEGINNING CONSTRUCTION OR ORDERING ANY MATERIAL ASSOCIATED WITH PROPOSED SANITARY SYSTEM.

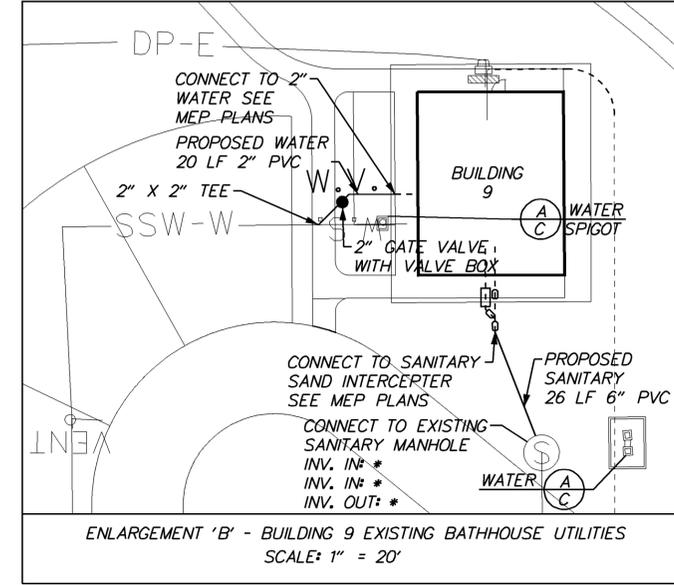

\* CONTRACTOR TO FIELD VERIFY EXISTING SANITARY SYSTEM AND VERIFY THE BUILDING PROPOSED SANITARY SYSTEM WILL PROVIDE POSITIVE OUTFLOW. CONTRACTOR TO SUBMIT VERIFICATION TO THE ENGINEER PRIOR TO BEGINNING CONSTRUCTION OR ORDERING ANY MATERIAL ASSOCIATED WITH PROPOSED SANITARY SYSTEM.

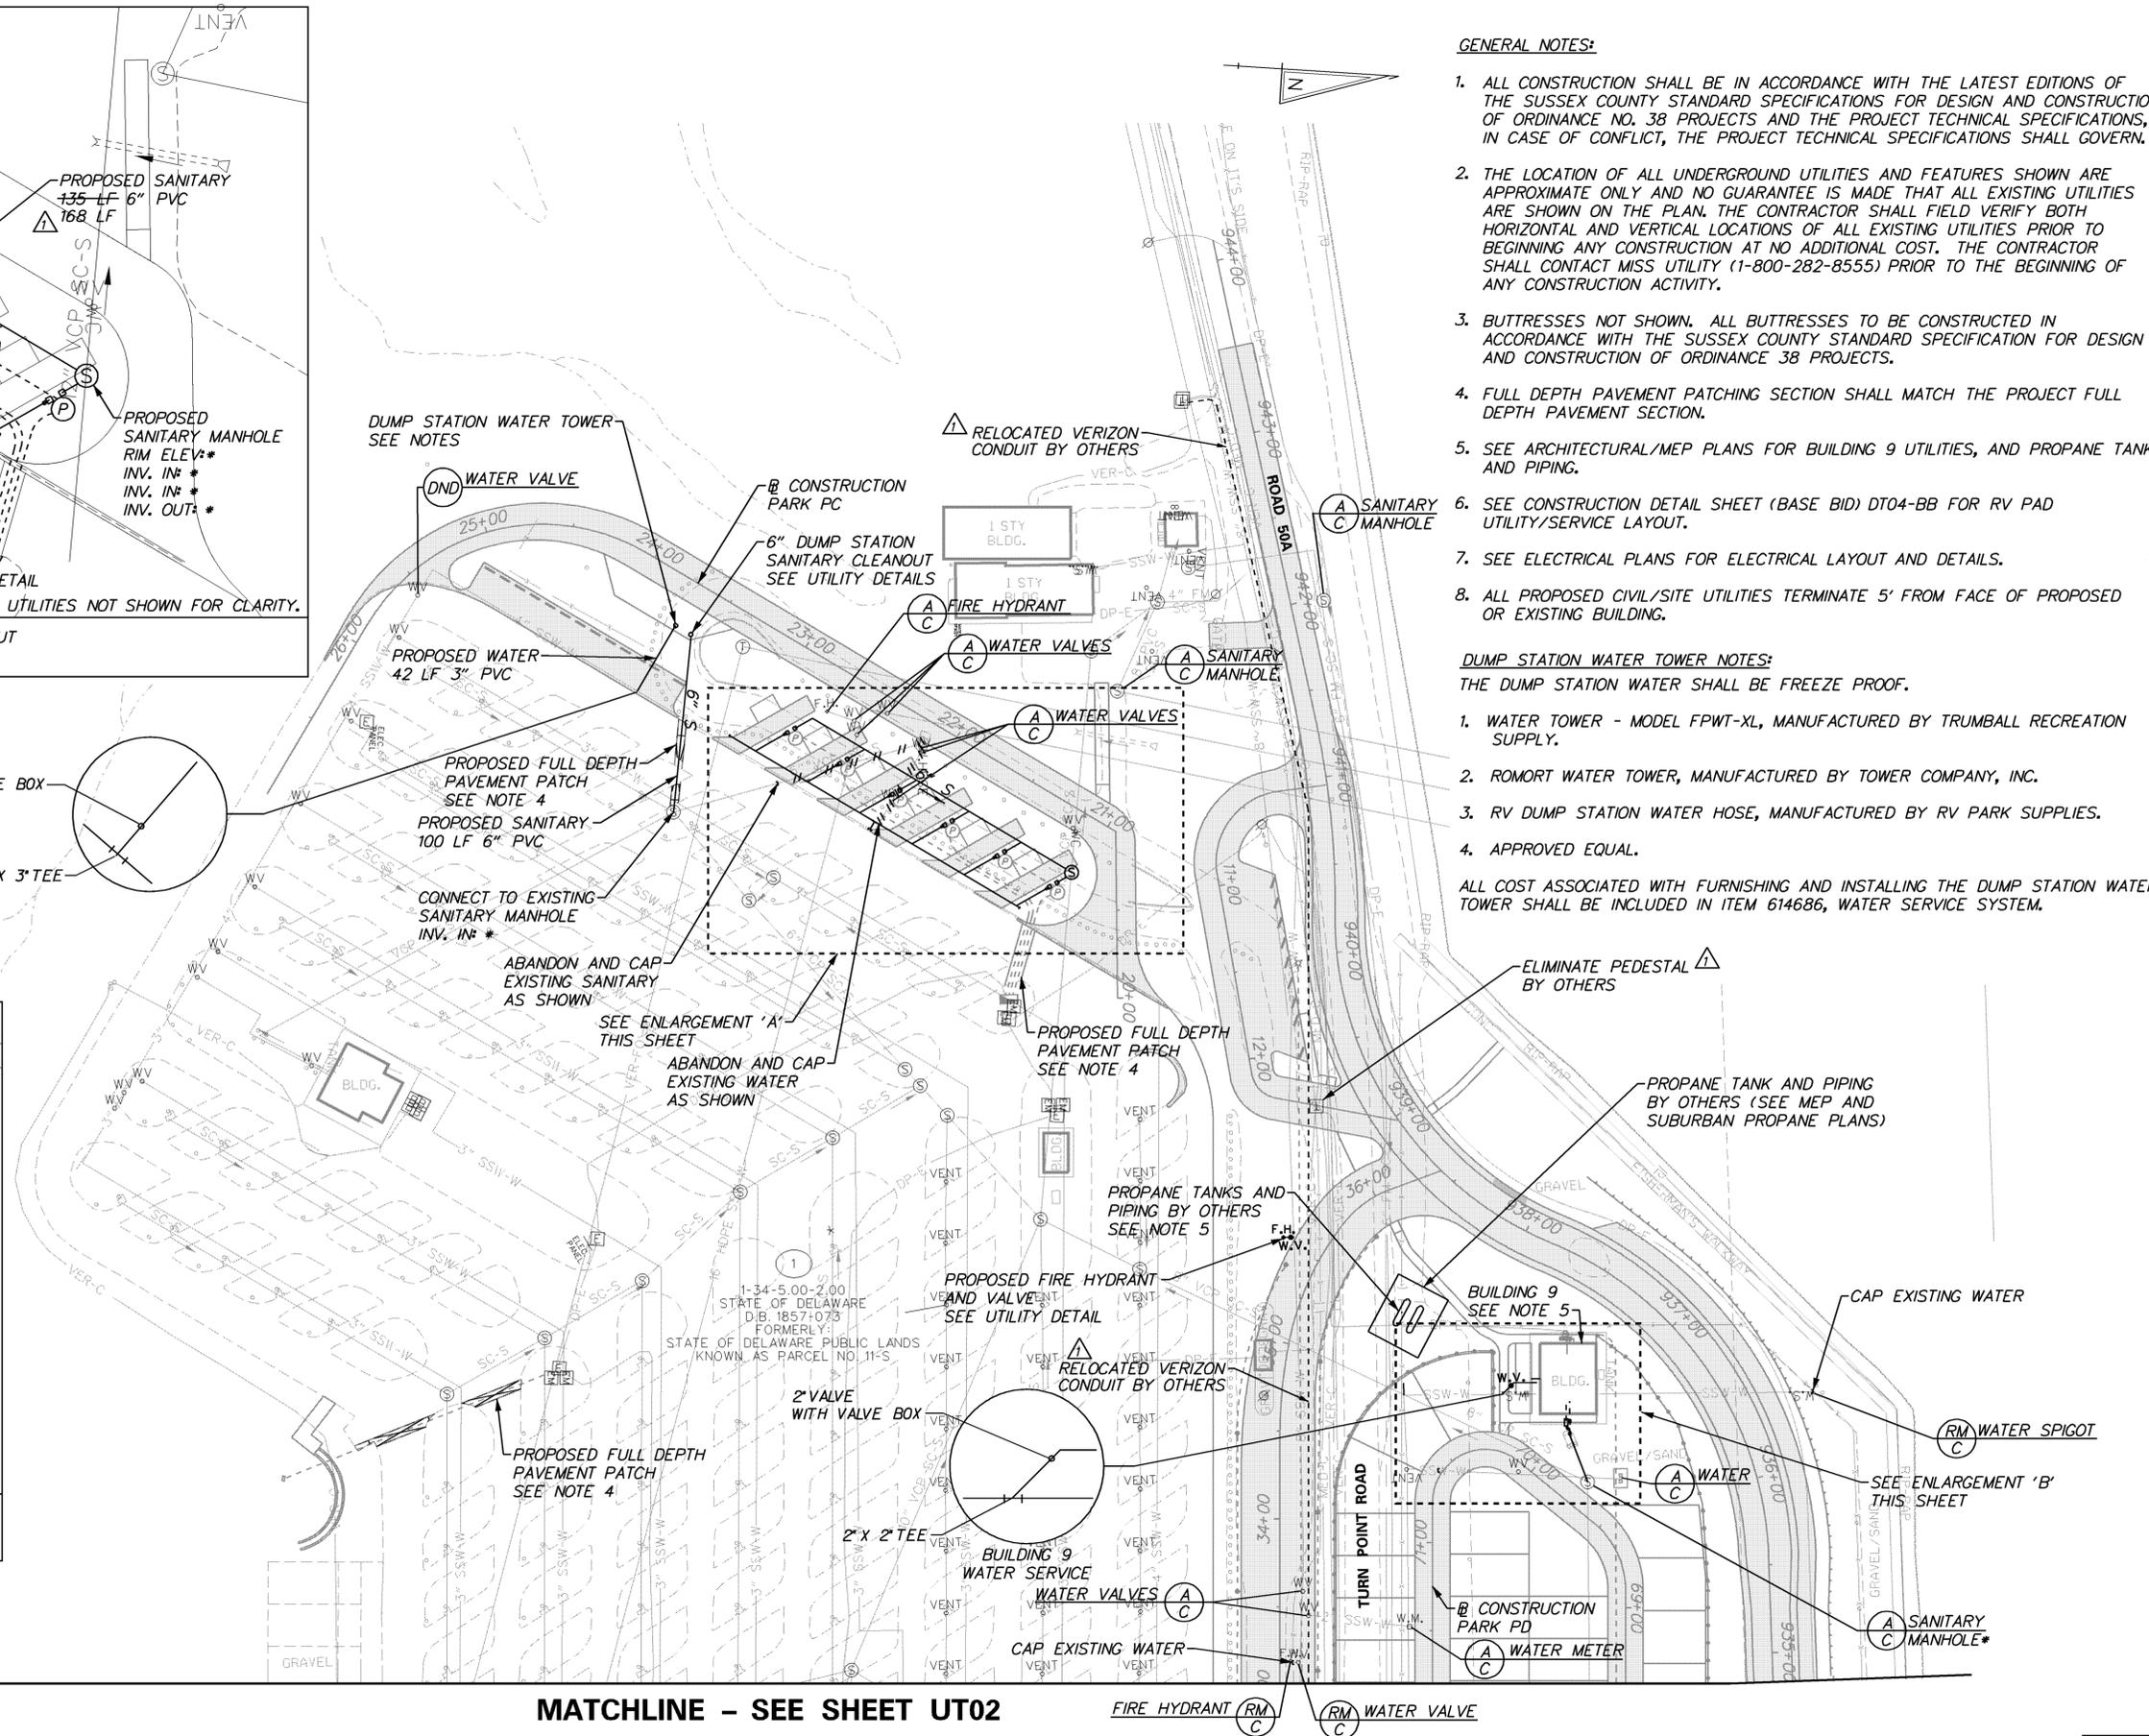


- GENERAL NOTES:**
1. ALL CONSTRUCTION SHALL BE IN ACCORDANCE WITH THE LATEST EDITIONS OF THE SUSSEX COUNTY STANDARD SPECIFICATIONS FOR DESIGN AND CONSTRUCTION OF ORDINANCE NO. 38 PROJECTS AND THE PROJECT TECHNICAL SPECIFICATIONS, IN CASE OF CONFLICT, THE PROJECT TECHNICAL SPECIFICATIONS SHALL GOVERN.
  2. THE LOCATION OF ALL UNDERGROUND UTILITIES AND FEATURES SHOWN ARE APPROXIMATE ONLY AND NO GUARANTEE IS MADE THAT ALL EXISTING UTILITIES ARE SHOWN ON THE PLAN. THE CONTRACTOR SHALL FIELD VERIFY BOTH HORIZONTAL AND VERTICAL LOCATIONS OF ALL EXISTING UTILITIES PRIOR TO BEGINNING ANY CONSTRUCTION AT NO ADDITIONAL COST. THE CONTRACTOR SHALL CONTACT MISS UTILITY (1-800-282-8555) PRIOR TO THE BEGINNING OF ANY CONSTRUCTION ACTIVITY.
  3. BUTTRESSES NOT SHOWN. ALL BUTTRESSES TO BE CONSTRUCTED IN ACCORDANCE WITH THE SUSSEX COUNTY STANDARD SPECIFICATION FOR DESIGN AND CONSTRUCTION OF ORDINANCE 38 PROJECTS.
  4. FULL DEPTH PAVEMENT PATCHING SECTION SHALL MATCH THE PROJECT FULL DEPTH PAVEMENT SECTION.
  5. SEE ARCHITECTURAL/MEP PLANS FOR BUILDING 9 UTILITIES, AND PROPANE TANK AND PIPING.
  6. SEE CONSTRUCTION DETAIL SHEET (BASE BID) DT04-BB FOR RV PAD UTILITY/SERVICE LAYOUT.
  7. SEE ELECTRICAL PLANS FOR ELECTRICAL LAYOUT AND DETAILS.
  8. ALL PROPOSED CIVIL/SITE UTILITIES TERMINATE 5' FROM FACE OF PROPOSED OR EXISTING BUILDING.

- DUMP STATION WATER TOWER NOTES:**  
THE DUMP STATION WATER SHALL BE FREEZE PROOF.
1. WATER TOWER - MODEL FPWT-XL, MANUFACTURED BY TRUMBALL RECREATION SUPPLY.
  2. ROMORT WATER TOWER, MANUFACTURED BY TOWER COMPANY, INC.
  3. RV DUMP STATION WATER HOSE, MANUFACTURED BY RV PARK SUPPLIES.
  4. APPROVED EQUAL.
- ALL COST ASSOCIATED WITH FURNISHING AND INSTALLING THE DUMP STATION WATER TOWER SHALL BE INCLUDED IN ITEM 614686, WATER SERVICE SYSTEM.

MATCHLINE - SEE SHEET UT02

ADDENDUMS / REVISIONS	
ADDENDUM NO. $\Delta$	REVISED/ADDED NOTES
5/17/2013, RLS	




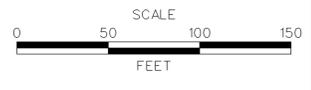


CONTRACT	BRIDGE NO.	<b>X</b>
T200507303	DESIGNED BY: RK&K	
COUNTY	CHECKED BY: RK&K	
SUSSEX		

<b>UT03</b>
SHEET NO.
170
TOTAL SHTS.
282

5/21/2013 4:06:21 PM \\BALSRV02.V2009\2009\09020\_IRP\_CADD\CONTRACTNUMBER\PLANS\CP\_UT03\_IRP.DGN


MATCHLINE - SEE SHEET UT05

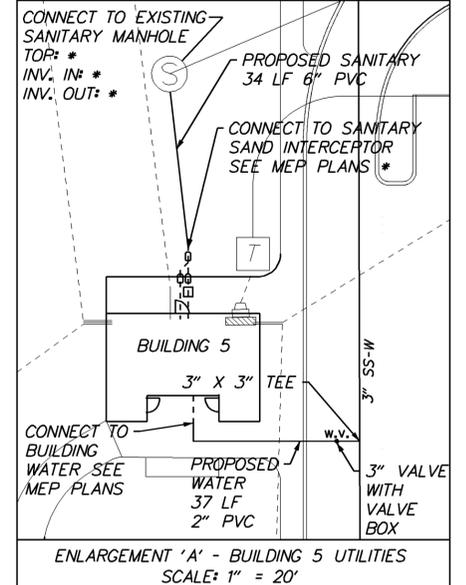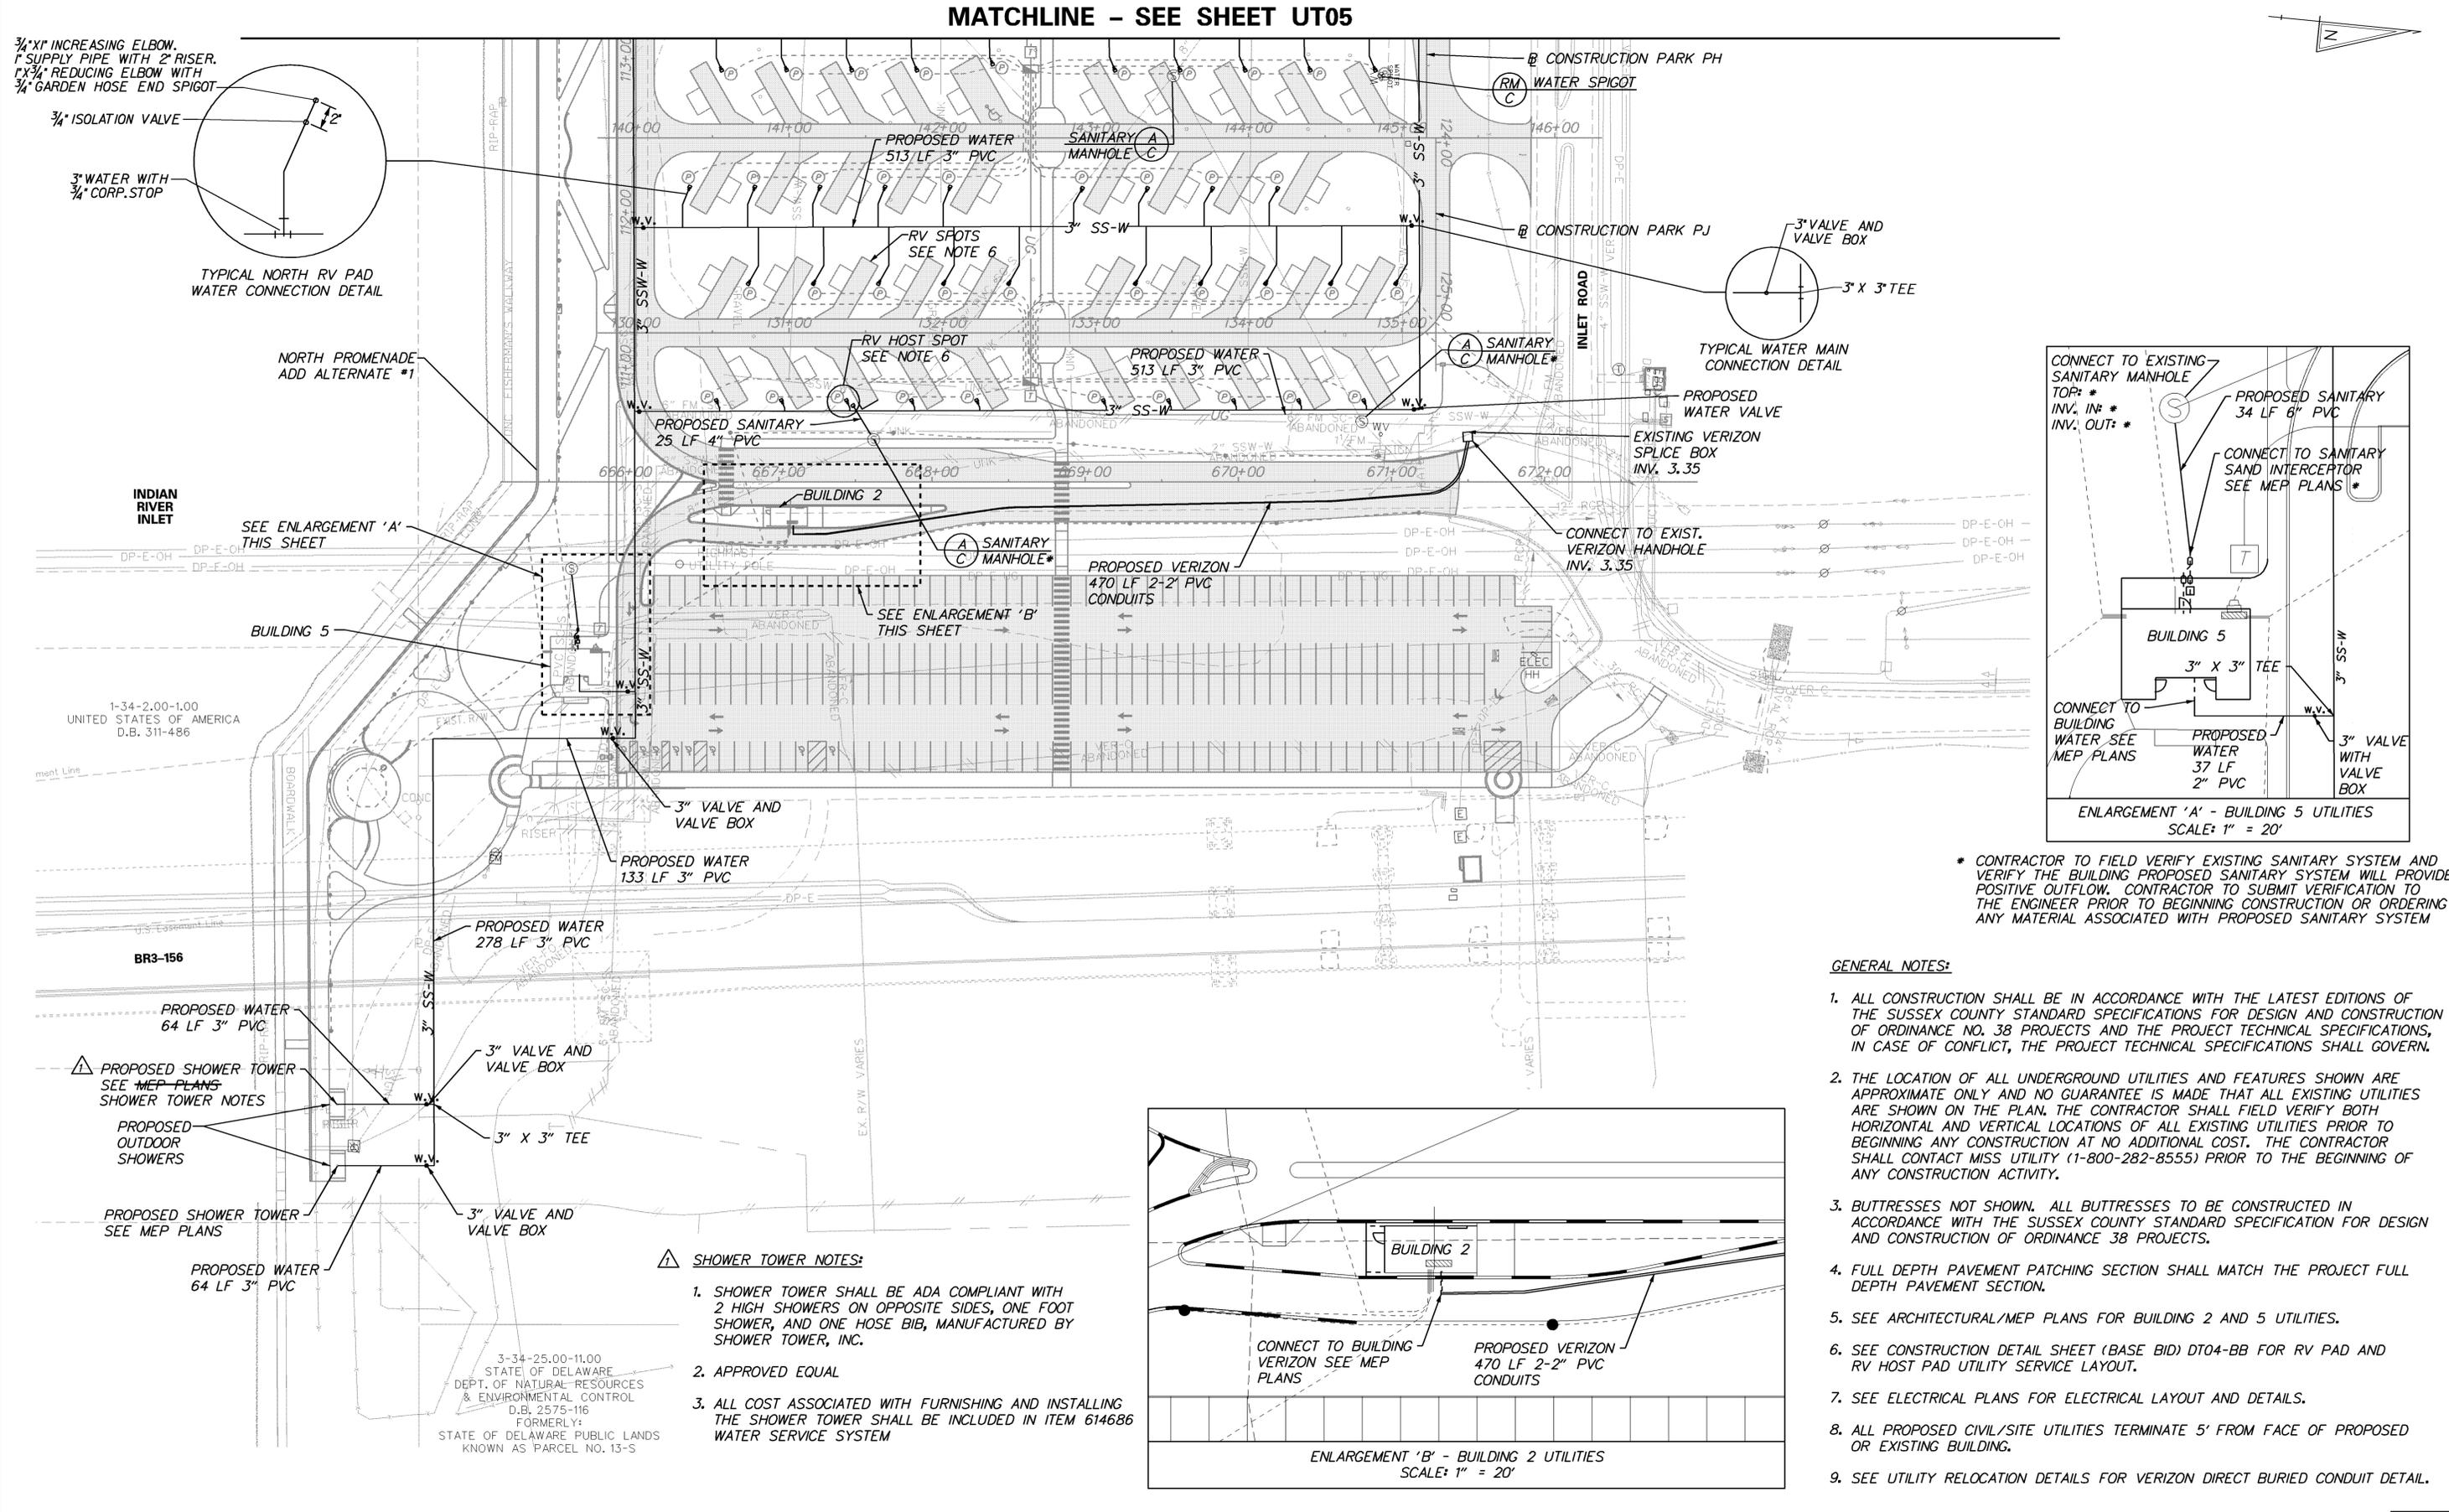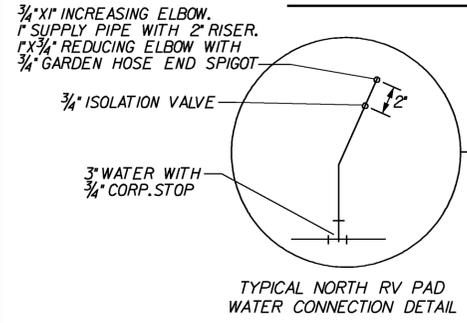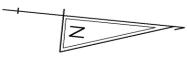

\* CONTRACTOR TO FIELD VERIFY EXISTING SANITARY SYSTEM AND VERIFY THE BUILDING PROPOSED SANITARY SYSTEM WILL PROVIDE POSITIVE OUTFLOW. CONTRACTOR TO SUBMIT VERIFICATION TO THE ENGINEER PRIOR TO BEGINNING CONSTRUCTION OR ORDERING ANY MATERIAL ASSOCIATED WITH PROPOSED SANITARY SYSTEM

GENERAL NOTES:


1. ALL CONSTRUCTION SHALL BE IN ACCORDANCE WITH THE LATEST EDITIONS OF THE SUSSEX COUNTY STANDARD SPECIFICATIONS FOR DESIGN AND CONSTRUCTION OF ORDINANCE NO. 38 PROJECTS AND THE PROJECT TECHNICAL SPECIFICATIONS, IN CASE OF CONFLICT, THE PROJECT TECHNICAL SPECIFICATIONS SHALL GOVERN.
2. THE LOCATION OF ALL UNDERGROUND UTILITIES AND FEATURES SHOWN ARE APPROXIMATE ONLY AND NO GUARANTEE IS MADE THAT ALL EXISTING UTILITIES ARE SHOWN ON THE PLAN. THE CONTRACTOR SHALL FIELD VERIFY BOTH HORIZONTAL AND VERTICAL LOCATIONS OF ALL EXISTING UTILITIES PRIOR TO BEGINNING ANY CONSTRUCTION AT NO ADDITIONAL COST. THE CONTRACTOR SHALL CONTACT MISS UTILITY (1-800-282-8555) PRIOR TO THE BEGINNING OF ANY CONSTRUCTION ACTIVITY.
3. BUTTRESSES NOT SHOWN. ALL BUTTRESSES TO BE CONSTRUCTED IN ACCORDANCE WITH THE SUSSEX COUNTY STANDARD SPECIFICATION FOR DESIGN AND CONSTRUCTION OF ORDINANCE 38 PROJECTS.
4. FULL DEPTH PAVEMENT PATCHING SECTION SHALL MATCH THE PROJECT FULL DEPTH PAVEMENT SECTION.
5. SEE ARCHITECTURAL/MEP PLANS FOR BUILDING 2 AND 5 UTILITIES.
6. SEE CONSTRUCTION DETAIL SHEET (BASE BID) DT04-BB FOR RV PAD AND RV HOST PAD UTILITY SERVICE LAYOUT.
7. SEE ELECTRICAL PLANS FOR ELECTRICAL LAYOUT AND DETAILS.
8. ALL PROPOSED CIVIL/SITE UTILITIES TERMINATE 5' FROM FACE OF PROPOSED OR EXISTING BUILDING.
9. SEE UTILITY RELOCATION DETAILS FOR VERIZON DIRECT BURIED CONDUIT DETAIL.

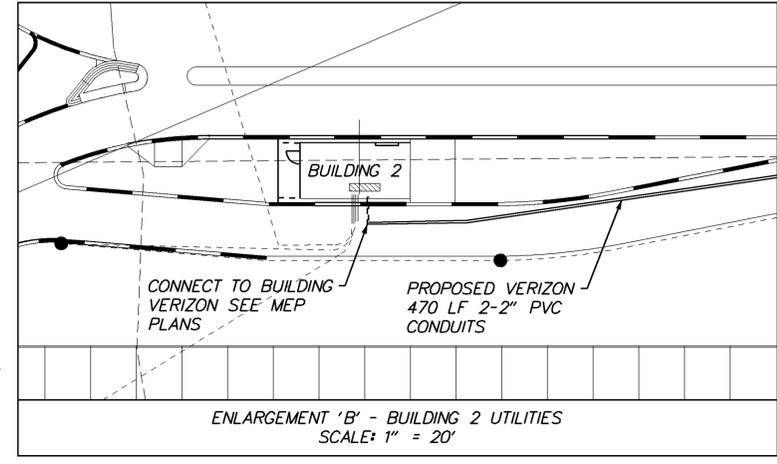

- SHOWER TOWER NOTES:
1. SHOWER TOWER SHALL BE ADA COMPLIANT WITH 2 HIGH SHOWERS ON OPPOSITE SIDES, ONE FOOT SHOWER, AND ONE HOSE BIB, MANUFACTURED BY SHOWER TOWER, INC.
  2. APPROVED EQUAL
  3. ALL COST ASSOCIATED WITH FURNISHING AND INSTALLING THE SHOWER TOWER SHALL BE INCLUDED IN ITEM 614686 WATER SERVICE SYSTEM

3-34-25.00-11.00  
STATE OF DELAWARE  
DEPT. OF NATURAL RESOURCES  
& ENVIRONMENTAL CONTROL  
D.B. 2575-116  
FORMERLY:  
STATE OF DELAWARE PUBLIC LANDS  
KNOWN AS PARCEL NO. 13-S

ADDENDUMS / REVISIONS	
ADDENDUM NO. 1	REVISED/ADDED NOTES
5/17/2013, RLS	





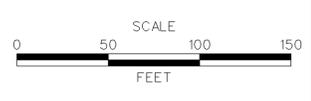


CONTRACT	BRIDGE NO.	X
T200507303	DESIGNED BY: RK&K	
COUNTY	CHECKED BY: RK&K	
SUSSEX		


UT04
SHEET NO.
171
TOTAL SHTS.
282

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1-34-2.00-1.00  
 UNITED STATES OF AMERICA  
 D.B. 311-486

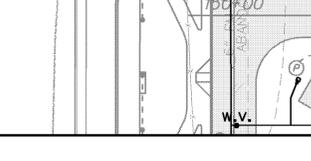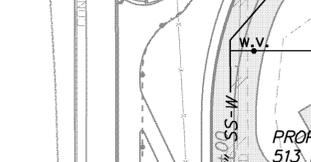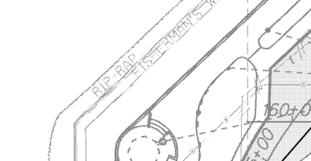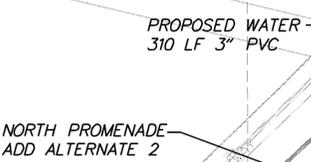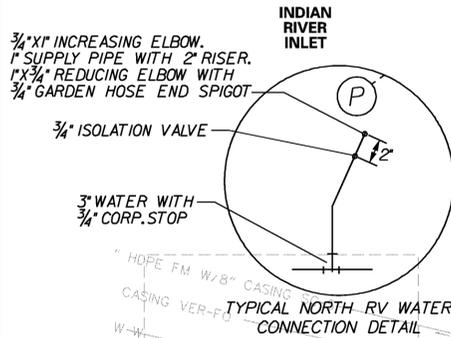

SEE ENLARGEMENT 'A' THIS SHEET  
**MATCHLINE - SEE SHEET UT04**

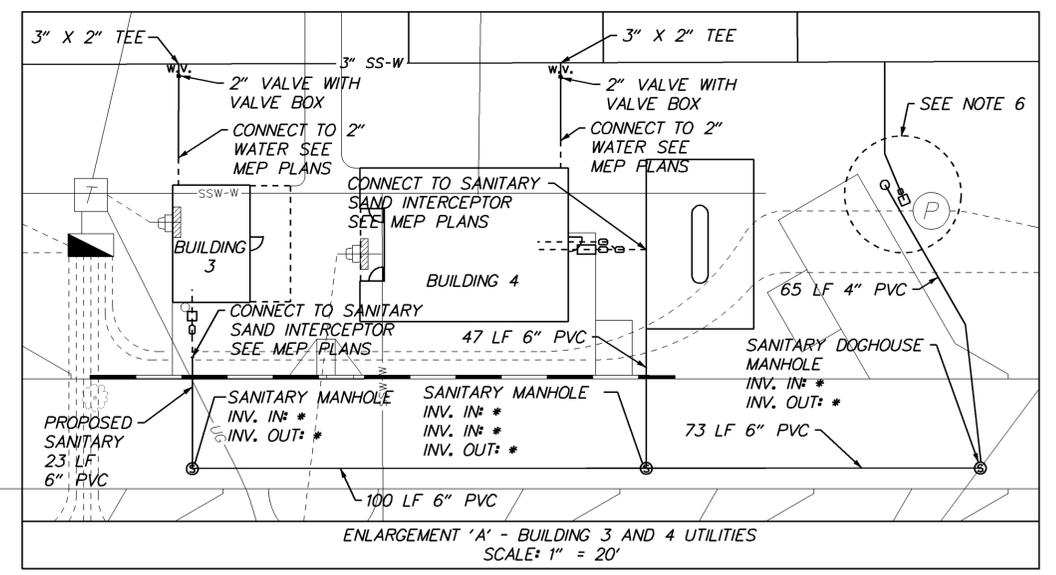

\* CONTRACTOR TO FIELD VERIFY EXISTING SANITARY SYSTEM AND VERIFY THE BUILDING PROPOSED SANITARY SYSTEM WILL PROVIDE POSITIVE OUTFLOW. CONTRACTOR TO SUBMIT VERIFICATION TO THE ENGINEER PRIOR TO BEGINNING CONSTRUCTION OR ORDERING ANY MATERIAL ASSOCIATED WITH PROPOSED SANITARY SYSTEM


**GENERAL NOTES:**

- ALL CONSTRUCTION SHALL BE IN ACCORDANCE WITH THE LATEST EDITIONS OF THE SUSSEX COUNTY STANDARD SPECIFICATIONS FOR DESIGN AND CONSTRUCTION OF ORDINANCE NO. 38 PROJECTS AND THE PROJECT TECHNICAL SPECIFICATIONS, IN CASE OF CONFLICT, THE PROJECT TECHNICAL SPECIFICATIONS SHALL GOVERN.
- THE LOCATION OF ALL UNDERGROUND UTILITIES AND FEATURES SHOWN ARE APPROXIMATE ONLY AND NO GUARANTEE IS MADE THAT ALL EXISTING UTILITIES ARE SHOWN ON THE PLAN. THE CONTRACTOR SHALL FIELD VERIFY BOTH HORIZONTAL AND VERTICAL LOCATIONS OF ALL EXISTING UTILITIES PRIOR TO BEGINNING ANY CONSTRUCTION AT NO ADDITIONAL COST. THE CONTRACTOR SHALL CONTACT MISS UTILITY (1-800-282-8555) PRIOR TO THE BEGINNING OF ANY CONSTRUCTION ACTIVITY.
- BUTTRESSES NOT SHOWN. ALL BUTTRESSES TO BE CONSTRUCTED IN ACCORDANCE WITH THE SUSSEX COUNTY STANDARD SPECIFICATION FOR DESIGN AND CONSTRUCTION OF ORDINANCE 38 PROJECTS.
- FULL DEPTH PAVEMENT PATCHING SECTION SHALL MATCH THE PROJECT FULL DEPTH PAVEMENT SECTION.
- SEE ARCHITECTURAL/MEP PLANS FOR BUILDING 3 AND 4 UTILITIES, PROPANE TANKS AND PIPING.
- SEE CONSTRUCTION DETAIL SHEET (BASE BID) DT04-BB FOR RV PAD AND RV HOST PAD UTILITY/SERVICE LAYOUT.
- SEE ELECTRICAL PLANS FOR ELECTRICAL LAYOUT AND DETAILS.
- ALL PROPOSED CIVIL/SITE UTILITIES TERMINATE 5' FROM FACE OF PROPOSED OR EXISTING BUILDING.


**DUMP STATION WATER TOWER NOTES:**

- THE DUMP STATION WATER SHALL BE FREEZE PROOF.
- WATER TOWER - MODEL FPWT-XL, MANUFACTURED BY TRUMBALL RECREATION SUPPLY.
  - ROMORT WATER TOWER, MANUFACTURED BY TOWER COMPANY, INC.
  - RV DUMP STATION WATER HOSE, MANUFACTURED BY RV PARK SUPPLIES.
  - APPROVED EQUAL.
- ALL COST ASSOCIATED WITH FURNISHING AND INSTALLING THE DUMP STATION WATER TOWER SHALL BE INCLUDED IN ITEM 614686, WATER SERVICE SYSTEM.

5/21/2013 4:10:04 PM \\BALSRV02\2009\2009\09020\JRP\CADD\CONTRACT\NUMBER\PLANS\CP\_UT05\_IRP.DGN

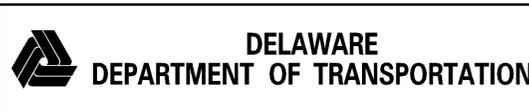

ADDENDUMS / REVISIONS	
ADDENDUM NO. $\Delta$	REVISED/ADDED NOTES
5/17/2013, RLS	

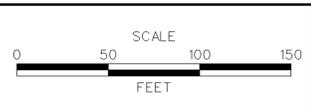


**INDIAN RIVER INLET PARK ENHANCEMENTS**

CONTRACT	BRIDGE NO.	<b>X</b>
T200507303	DESIGNED BY: RK&K	
COUNTY	CHECKED BY: RK&K	
SUSSEX		


<b>UTILITY RELOCATION PLAN (WATER, SEWER, VERIZON)</b>	
SHEET NO.	172
TOTAL SHTS.	282

**UT05**


## BRANCH CIRCUIT IDENTIFICATION:

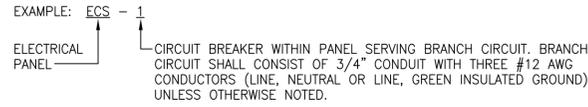

## LIGHTING CONTROL IDENTIFICATION:

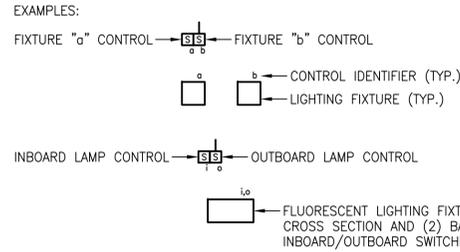

## DEVICE CONTROL IDENTIFICATION:

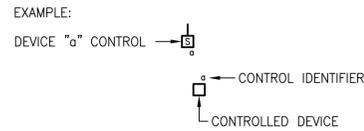

## ELECTRICAL DATUM PLANE NOTES:

1. THE ELECTRICAL DATUM PLANE FOR THIS PROJECT SHALL BE DEFINED AS "IN AREAS SUBJECT TO FLOODING...A HORIZONTAL PLANE (2 FT.) ABOVE THE POINT IDENTIFIED AS THE PREVAILING HIGH WATER MARK OR AN EQUIVALENT BENCHMARK BASED ON SEASONAL OR STORM-DRIVEN FLOODING FROM THE AUTHORITY HAVING JURISDICTION" (QUOTED FROM NEC ARTICLE 682).
2. ALL ELECTRICAL EQUIPMENT SHALL BE INSTALLED AT A MINIMUM OF 12" ABOVE THE ELECTRICAL DATUM PLANE.
3. ALL WIRE CONNECTORS (WIRE NUTS, IN-LINE SPLICERS/REDUCERS, ETC.) UTILIZED AT OR BELOW THE ELECTRICAL DATUM PLANE SHALL BE UL LISTED FOR SUBMERSIBLE APPLICATIONS.


## ELECTRICAL ABBREVIATIONS:

NOTE: REFER TO MECHANICAL DRAWINGS FOR MECHANICAL EQUIPMENT ABBREVIATIONS


A	AMPERES
AFF	ABOVE FINISHED FLOOR
AFG	ABOVE FINISHED GRADE
AIC	AMPERE INTERRUPTING CAPACITY
ATS	AUTOMATIC TRANSFER SWITCH
AWG	AMERICAN WIRE GAUGE
BAS	BUILDING AUTOMATION SYSTEM
BLDG	BUILDING
C	CONDUIT
CB	CIRCUIT BREAKER
DWG	DRAWING
EC	ELECTRICAL CONTRACTOR
EGC	EQUIPMENT GROUNDING CONDUCTOR
EQPM	EQUIPMENT
FLR	FLOOR
FSS	FUSED SAFETY SWITCH
G/GND	GROUND
GEC	GROUNDING ELECTRODE CONDUCTOR
GFCI	GROUND FAULT CIRCUIT INTERRUPTING
HACR	HEATING, AIR CONDITIONING, REFRIGERATION RATED
H-O-A	HAND-OFF-AUTO
HP	HORSEPOWER
JB	JUNCTION BOX
K	THOUSAND
KCMIL	THOUSAND CIRCULAR MILS
LV	LOW VOLTAGE
MCB	MAIN CIRCUIT BREAKER
MCC	MOTOR CONTROL CENTER
MCP	MOTOR CIRCUIT PROTECTOR
MCS	MOLDED CASE SWITCH
MH	MOUNTING HEIGHT
MLO	MAIN LUGS ONLY
MTD	MOUNTED
NEC	NATIONAL ELECTRICAL CODE (NFPA 70)
NEMA	NATIONAL ELECTRICAL MANUFACTURERS ASSOCIATION
NC	NORMALLY CLOSED
NIC	NOT IN CONTRACT
NO	NORMALLY OPEN
OH	OVERHEAD
OL	OVERLOAD
P	POLE
PV	PHOTOVOLTAIC
∅	PHASE
SCCR	SHORT CIRCUIT CURRENT RATING
SPD	SURGE PROTECTIVE DEVICE
SWBD	SWITCHBOARD
T'STAT	THERMOSTAT
TYP	TYPICAL
UL	UNDERWRITERS LABORATORIES
UON	UNLESS OTHERWISE NOTED
UV	ULTRAVIOLET
V	VOLTS
VFD	VARIABLE FREQUENCY DRIVE
W	WIRE
WP	WEATHERPROOF
XFMR	TRANSFORMER

## ELECTRICAL LEGEND:


	A	O <sub>B</sub>	LIGHTING FIXTURE – RECESSED, SURFACE OR PENDANT MOUNTED – LETTER INDICATES FIXTURE TYPE
	C	Q <sub>D</sub>	LIGHTING FIXTURE – WALL MOUNTED – LETTER INDICATES FIXTURE TYPE
	VRS	E	EMERGENCY LIGHTING BATTERY UNIT (WITH VANDAL-RESISTANT SHIELD WHERE INDICATED) – LETTER INDICATES FIXTURE TYPE – CONNECT UNSWITCHED LEG OF LIGHTING BRANCH CIRCUIT TO INPUT
	WG	E1	EMERGENCY REMOTE DUAL LIGHTING HEAD (WITH WIRE GUARD WHERE INDICATED) – LETTER INDICATES FIXTURE TYPE
	VRS	X	ILLUMINATED EXIT SIGN (WITH VANDAL-RESISTANT SHIELD WHERE INDICATED) – WALL MOUNTED, CEILING MOUNTED – FACES AND DIRECTIONAL ARROWS AS INDICATED – LETTER INDICATES FIXTURE TYPE – CONNECT UNSWITCHED LEG OF LIGHTING BRANCH CIRCUIT TO INPUT
			DEVICE BOX – FLUSH MOUNTED WITH SINGLE-GANG TILE RING AND STAINLESS STEEL DEVICE COVER PLATE (UNLESS OTHERWISE NOTED), SURFACE MOUNTED WITH GALVANIZED STEEL DEVICE COVER PLATE (UNLESS OTHERWISE NOTED).
			DEVICE BOXES IN GANGED CONFIGURATION – FLUSH MOUNTED WITH GANGED TILE RING AND STAINLESS STEEL DEVICE COVER PLATE (UNLESS OTHERWISE NOTED), SURFACE MOUNTED WITH GALVANIZED STEEL DEVICE COVER PLATE (UNLESS OTHERWISE NOTED).
		6"	DEVICE BOX MOUNTED 6" ABOVE COUNTERTOP BACKSPASH LEVEL
		42"	DEVICE BOX MOUNTED 42" A.F.F. (MOUNTING HEIGHT TO BE AS INDICATED)
			NEMA TYPE 5-20R DUPLEX RECEPTACLE OUTLET – PROVIDE EXTRA HEAVY DUTY SPECIFICATION GRADE, STRAIGHT BLADE, 20 AMPERE, 125 VOLT, 2 POLE, 3 WIRE GROUNDING TYPE WITH GRAY COLOR (HUBBELL CAT. NO. HBL5362GY OR APPROVED EQUAL BY BRYANT, COOPER, LEVITON OR PASS & SEYMOUR). MOUNT 18" A.F.F. UNLESS OTHERWISE NOTED.
			NEMA TYPE 5-20R SURGE-PROTECTION DUPLEX RECEPTACLE OUTLET – PROVIDE SPECIFICATION GRADE, STRAIGHT BLADE, 20 AMPERE, 125 VOLT, 2 POLE, 3 WIRE GROUNDING TYPE, 240 JOULES/15000A PER MODE WITH BLUE COLOR, INDICATOR LIGHT AND AUDIBLE ALARM (HUBBELL CAT. NO. HBL5362SA OR APPROVED EQUAL BY BRYANT, COOPER, LEVITON OR PASS & SEYMOUR). MOUNT 18" A.F.F. UNLESS OTHERWISE NOTED.
			NEMA TYPE 14-30R RECEPTACLE OUTLET – PROVIDE STRAIGHT BLADE, 30 AMPERE, 125/250 VOLT, 3 POLE, 4 WIRE GROUNDING TYPE (HUBBELL CAT. NO. HBL9430A OR APPROVED EQUAL BY BRYANT, COOPER, LEVITON OR PASS & SEYMOUR). MOUNTING HEIGHT AS INDICATED.
			NEMA TYPE 5-20R GFCI DUPLEX RECEPTACLE OUTLET – PROVIDE EXTRA HEAVY DUTY SPECIFICATION GRADE, WEATHER-RESISTANT, STRAIGHT BLADE, 20 AMPERE, 125 VOLT, 2 POLE, 3 WIRE GROUNDING TYPE WITH GRAY COLOR (HUBBELL CAT. NO. GFR5362SGGY OR APPROVED EQUAL BY BRYANT, COOPER, LEVITON OR PASS & SEYMOUR). MOUNT 18" A.F.F. UNLESS OTHERWISE NOTED.
			GFCI RECEPTACLE OUTLET AS ABOVE WITH WEATHERPROOF WHILE-IN-USE DEVICE COVER. UNLESS OTHERWISE NOTED, DEVICE COVER SHALL BE HORIZONTAL HEAVY DUTY GRAY DIE-CAST ALUMINUM OR ZINC (HUBBELL CAT. NO. WP826H OR APPROVED EQUAL BY PASS & SEYMOUR). MOUNT 24" A.F.F. UNLESS OTHERWISE NOTED.
			SINGLE-POLE OR 3-WAY TOGGLE SWITCH AS INDICATED – PROVIDE EXTRA HEAVY DUTY SPECIFICATION GRADE, 20 AMPERE, 1 HORSEPOWER, 120-277 VOLT WITH GROUND SCREW AND GRAY TOGGLE COLOR (HUBBELL CAT. NO. HBL122(1/3)GY OR APPROVED EQUAL BY BRYANT, COOPER, LEVITON OR PASS & SEYMOUR). MOUNT 48" A.F.F. UNLESS OTHERWISE NOTED.
			SINGLE-POLE, DOUBLE THROW MAINTAINED CONTACT 3-POSITION (2-CIRCUIT, CENTER OFF) TOGGLE SWITCH – PROVIDE HEAVY DUTY SPECIFICATION GRADE, 20 AMPERE, 120-277 VOLT WITH GROUND SCREW (HUBBELL CAT. NO. HBL385 OR APPROVED EQUAL BY BRYANT, COOPER, LEVITON OR PASS & SEYMOUR). MOUNT 48" A.F.F. UNLESS OTHERWISE NOTED.
			SINGLE-POLE, DOUBLE THROW 3-POSITION TOGGLE SWITCH AS ABOVE WITH VERTICAL WEATHERPROOF WHILE-IN-USE DEVICE COVER. DEVICE COVER SHALL BE HEAVY DUTY GRAY DIE-CAST ALUMINUM OR ZINC WITH ADAPTER PLATE AND GASKETING SUITABLE FOR USE WITH TOGGLE SWITCH (HUBBELL CAT. NO. WP826 OR APPROVED EQUAL BY PASS & SEYMOUR). MOUNT 24" A.F.F. UNLESS OTHERWISE NOTED.
		WG	CEILING-MOUNTED OCCUPANCY SENSOR WITH WIRE GUARD – PROVIDE DUAL-TECHNOLOGY (ULTRASONIC/PIR) OPERATION (HUBBELL BUILDING AUTOMATION SYSTEMS CAT. NO. OMNIDT2000 OR APPROVED EQUAL BY WATTSTOPPER, SENSOR SWITCH OR LEVITON).
		WG	WALL-MOUNTED OCCUPANCY SENSOR WITH WIRE GUARD – PROVIDE DUAL-TECHNOLOGY (ULTRASONIC/PIR) OPERATION (HUBBELL BUILDING AUTOMATION SYSTEMS CAT. NO. L0DT OR APPROVED EQUAL BY WATTSTOPPER, SENSOR SWITCH OR LEVITON).
			OCCUPANCY SENSOR POWER RELAY PACK – PROVIDE UNIVERSAL VOLTAGE (120/277V), 20 AMPERE, 1 HORSEPOWER WITH ZERO-CROSSING CIRCUITRY (HUBBELL BUILDING AUTOMATION SYSTEMS CAT. NO. UVPP OR APPROVED EQUAL BY WATTSTOPPER, SENSOR SWITCH OR LEVITON).
			FRACTIONAL HORSEPOWER MOTOR STARTER WITH 2-POLE TOGGLE DISCONNECT SWITCH, LOCKABLE TOGGLE GUARD KIT, THERMAL OVERLOAD RELAY, H-O-A SWITCH AND RED PILOT LIGHT IN 2-GANG SURFACE MOUNTED NEMA 1 ENCLOSURE. TOGGLE AND H-O-A SWITCHES SHALL BE RATED 1 HORSEPOWER (16 AMPERES CONTINUOUS CURRENT) @ 115-230/277 VOLTS (STARTER SHALL BE SQUARE D CLASS 2510 TYPE F OR APPROVED EQUAL; TOGGLE GUARD SHALL BE SQUARE D CAT. NO. 2510FL1 OR APPROVED EQUAL). PROVIDE OVERLOAD RELAY PER MOTOR NAMEPLATE FULL LOAD CURRENT. MOUNT 48" A.F.F. UNLESS OTHERWISE NOTED.
			MANUAL MOTOR SWITCH (WITHOUT THERMAL OVERLOAD RELAY) AS INDICATED – MOUNT ADJACENT TO EQUIPMENT SERVED (EXACT MOUNTING LOCATION TO BE FIELD-COORDINATED)
			FLUSH-MOUNTED TELECOMMUNICATION OUTLET (VOICE & DATA) – PROVIDE FLUSH-MOUNTED DUAL-GANG OUTLET BOX WITH SINGLE-GANG PLASTER RING. MOUNT 18" A.F.F. UNLESS OTHERWISE NOTED. TELECOMMUNICATION WIRING, JACKS AND DEVICE PLATE TO BE PROVIDED BY OTHERS.
			OUTDOOR PHOTOSENSOR – PROVIDE 120V, 2000W TUNGSTEN/1800VA BALLAST RATED PHOTOCONTROL IN GASKETED HEAVY DUTY DIE CAST ZINC ENCLOSURE WITH SLIDING LIGHT LEVEL ADJUSTMENT (TORK CAT. NO. 2101 OR APPROVED EQUAL BY PARAGON OR INTERMATIC). MOUNT AS INDICATED.
			JUNCTION BOX – STANDARD, WEATHERPROOF
			TRANSFORMER AS INDICATED – EXACT MOUNTING LOCATION TO BE FIELD-COORDINATED
			SAFETY SWITCH AS INDICATED – EXACT MOUNTING LOCATION TO BE FIELD-COORDINATED
			ENCLOSED CIRCUIT BREAKER AS INDICATED – EXACT MOUNTING LOCATION TO BE FIELD-COORDINATED
			MOTOR OUTLET
			TIME CLOCK
			DIRECT CONNECTION TO EQUIPMENT
			GROUND CONNECTION
			CIRCUIT EXPOSED OR CONCEALED IN CEILING OR WALL CONSTRUCTION – 3/4" CONDUIT WITH THREE #12 AWG CONDUCTORS (LINE, NEUTRAL OR LINE, GREEN INSULATED GROUND) UNLESS OTHERWISE NOTED
			CIRCUIT AS ABOVE CONCEALED UNDER FLOOR CONSTRUCTION OR UNDERGROUND
			HOMERUN TO PANELBOARD – NUMBER OF ARROWS INDICATES NUMBER OF CIRCUITS
			LOW-VOLTAGE WIRING – PROVIDE RACEWAY AS REQUIRED FOR INSTALLATION
			CONDUIT TURNS UP, CONDUIT TURNS DOWN
			PANELBOARD – SURFACE MOUNTED, FLUSH MOUNTED – MOUNT TOP OF PANEL 6'-0" A.F.F. UNLESS OTHERWISE NOTED

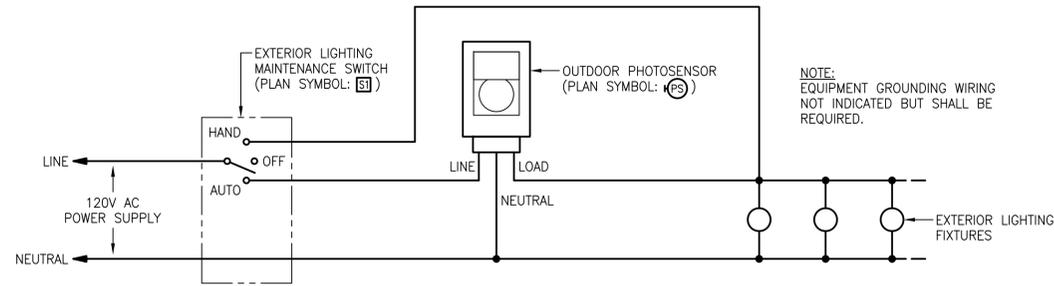

**1 EXTERIOR LIGHTING CONTROL WIRING DIAGRAM**  
E0-02 SCALE: NONE

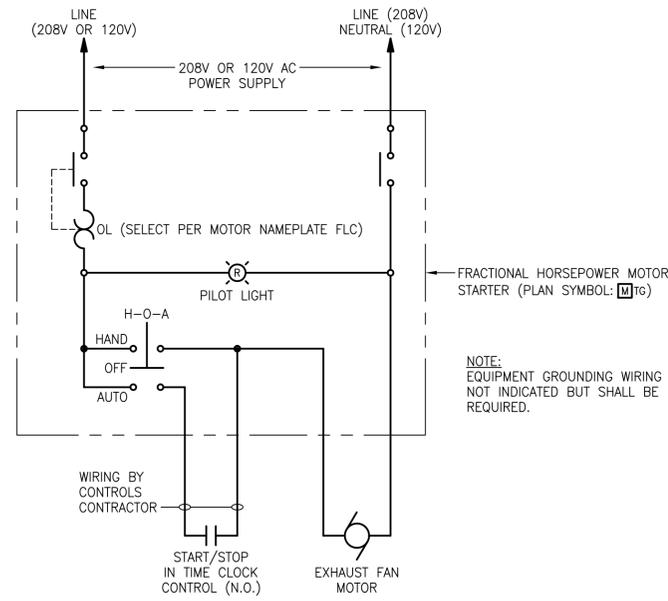



**2 EXHAUST FAN WIRING DIAGRAM**  
E0-02 SCALE: NONE

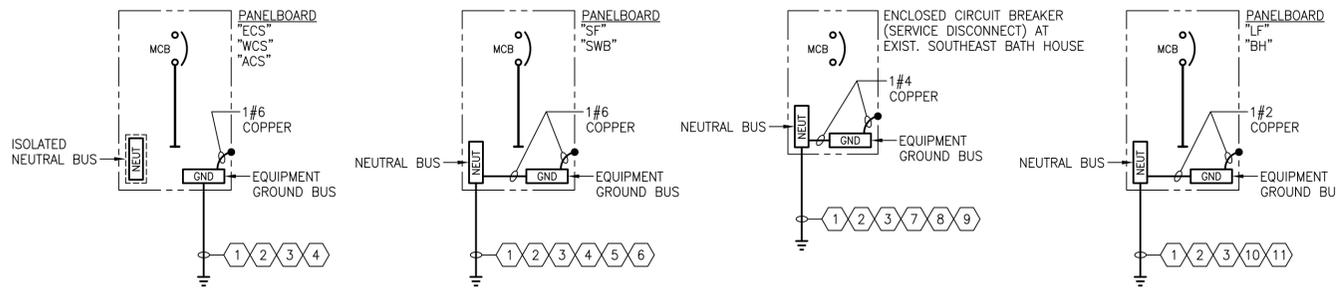

**3 GROUNDING & BONDING DETAILS**  
E0-02 SCALE: NONE

FIXTURE TYPE	MANUFACTURER MODEL NO.	LAMPS		BALLASTS		INPUT VOLTS	INPUT WATTS	INPUT VA	DESCRIPTION
		QTY.	TYPE	QTY.	TYPE				
A	KENALL R12-48-3-32-IS-2-DV (OR APPROVED EQUAL BY MORLITE OR LITHONIA)	3	32 WATT T8 LINEAR FLUORESCENT 3500K	2	ELECTRONIC LINEAR FLUORESCENT INSTANT START <10% THD .88 BALLAST FACTOR	120	90	90	4' SURFACE-MOUNTED ROUGH-SERVICE FLUORESCENT WRAPAROUND LUMINAIRE WITH 3-LAMP CROSS SECTION, NOMINAL 12" WIDE, 20 GAUGE STEEL HOUSING WITH WHITE TGIC POLYESTER POWDER COAT (5-STAGE PRETREATMENT SUBJECTED TO 1,000-HR. SALT SPRAY TEST), CLEAR PRISMATIC ACRYLIC LENS, SEAM WELDED END CAPS AND DAMP LOCATION LISTING.
B	COLUMBIA LUN4-332-EU-SSL (OR APPROVED EQUAL BY DAY-BRITE OR LITHONIA)	3	32 WATT T8 LINEAR FLUORESCENT 3500K	1	ELECTRONIC LINEAR FLUORESCENT INSTANT START <10% THD .88 BALLAST FACTOR	120	85	85	4' SURFACE-MOUNTED OR CHAIN-SUSPENDED ENCLOSED & GASKETED INDUSTRIAL FLUORESCENT LUMINAIRE WITH 3-LAMP CROSS SECTION, FIBERGLASS HOUSING, ACRYLIC DIFFUSER, STAINLESS STEEL LATCHES AND WET LOCATION LISTING. PROVIDE STAINLESS STEEL CHAIN AND ALL MOUNTING HARDWARE AS REQUIRED FOR CHAIN-SUSPENDING.
C	KENALL SH5-48-W-1-32-IS-1-DV (OR APPROVED EQUAL BY MORLITE OR LITHONIA)	1	32 WATT T8 LINEAR FLUORESCENT 3500K	1	ELECTRONIC LINEAR FLUORESCENT INSTANT START <10% THD .88 BALLAST FACTOR	120	31	31	4' SURFACE-MOUNTED VANDAL-RESISTANT FLUORESCENT WRAPAROUND LUMINAIRE WITH 1-LAMP CROSS SECTION, NOMINAL 5" WIDE, 16 GAUGE STEEL HOUSING WITH WHITE TGIC POLYESTER POWDER COAT (5-STAGE PRETREATMENT SUBJECTED TO 1,000-HR. SALT SPRAY TEST), .156" THICK PATTERN #12 POLYCARBONATE LENS, SEAM WELDED END CAPS, TAMPER-RESISTANT SCREWS AND WET LOCATION LISTING. MOUNT ON WALL ABOVE BATHROOM MIRRORS (COORDINATE EXACT LOCATION WITH ARCHITECT).
D	PRESCOLITE CFT632HEB-STF602HPLTRG (OR APPROVED EQUAL BY CAPRI, OMEGA OR LITHONIA)	1	32 WATT PL-T COMPACT FLUORESCENT 3500K	1	ELECTRONIC COMPACT FLUORESCENT 26/32/42 WATT <10% THD .98 BALLAST FACTOR	120	36	37	6" RECESSED DOWNLIGHT LISTED FOR USE IN WET LOCATIONS WITH CLEAR SPECULAR SELF-TRIM REFLECTOR, REGRESSED PRISMATIC ACRYLIC LENS AND TRIM RING GASKET. PROVIDE BAR HANGERS AND ALL MOUNTING ACCESSORIES & HARDWARE AS REQUIRED.
E	DUAL-LITE LZ25NDI-03L(-VRS-4X) (OR APPROVED EQUAL BY CHLORIDE OR LITHONIA)	2	3 WATT, 6 VOLT MR16 LED	-	-	120	11.1	13.9	EMERGENCY LIGHTING UNIT WITH (2) INTEGRAL HIGH-OUTPUT LED LAMPS, WHITE THERMOPLASTIC HOUSING, MAINTENANCE-FREE NICKEL-CADMIUM BATTERY WITH REMOTE CAPACITY (20 TOTAL WATTS FOR 90 MINUTES), 6-VOLT OUTPUT, TEST SWITCH, AND SELF-TESTING DIAGNOSTICS. PROVIDE VANDAL-RESISTANT SHIELD (DUAL-LITE CAT. NO. VRS-4X) WHERE INDICATED ON PLANS. MOUNT ON WALL 7'-6" A.F.F.
E1	DUAL-LITE CPR-D-W-0603L(-WGEL) (OR APPROVED EQUAL BY CHLORIDE OR LITHONIA)	2	3 WATT, 6 VOLT MR16 LED	-	-	6	6	6	EMERGENCY LIGHTING DECORATIVE REMOTE DUAL-HEAD ASSEMBLY WITH WHITE THERMOPLASTIC LAMP HEADS & MOUNTING PLATE. PROVIDE WIREGUARD (WGEL) WHERE INDICATED ON PLANS. MOUNT ON WALL 7'-6" A.F.F.
E2	DUAL-LITE OCR-D-B-0603L(-WGEL) (OR APPROVED EQUAL BY CHLORIDE OR LITHONIA)	2	3 WATT, 6 VOLT MR16 LED	-	-	6	6	6	EMERGENCY LIGHTING DECORATIVE OUTDOOR REMOTE DUAL-HEAD ASSEMBLY WITH DIE-CAST ALUMINUM LAMP HEADS & MOUNTING PLATE, BLACK FINISH AND WET LOCATION LISTING. PROVIDE WIREGUARD (WGEL) WHERE INDICATED ON PLANS. MOUNT ON EXTERIOR WALL 7'-6" A.F.F. UNLESS OTHERWISE NOTED.
F	HUBBELL LFS-12LU-5K-W- (OR APPROVED EQUAL BY DAY-BRITE OR LITHONIA)	-	LED ARRAY 5000K	1	HIGH POWER FACTOR LED DRIVER	120	12.8	15	COMPACT DECORATIVE LED FLOODLIGHT WITH WIDE OPTICAL DISTRIBUTION, DIE CAST ALUMINUM HOUSING, POLYESTER POWDER PROTECTIVE FINISH, SILICONE GASKETING AND WET LOCATION LISTING. FLUSH MOUNT ON INSIDE OF PAVILION POST 7'-0" A.F.F. AND AIM UPWARD AS REQUIRED TO ILLUMINATE UNDERSIDE OF PAVILION ROOF STRUCTURE. COLOR TO MATCH THAT OF PAVILION POSTS; COORDINATE WITH ARCHITECT. PROVIDE ALL MOUNTING ACCESSORIES & HARDWARE AS REQUIRED.
X	DUAL-LITE LXURWEI(-VRS3) (OR APPROVED EQUAL BY CHLORIDE OR LITHONIA)	-	LED	-	-	120	3.8	4.8	UNIVERSALLY-MOUNTED LED EXIT SIGN WITH WHITE THERMOPLASTIC HOUSING, RED STENCILLED LETTERS, UNIVERSAL SNAP-IN CHEVRON ARROWS, MAINTENANCE-FREE NICKEL-CADMIUM BATTERY, TEST SWITCH, SELF-TESTING DIAGNOSTICS AND DAMP LOCATION LISTING. PROVIDE VANDAL-RESISTANT SHIELD (DUAL-LITE CAT. NO. VRS3) WHERE INDICATED ON PLANS. MOUNT BOTTOM OF SIGN 7'-6" A.F.F.

- DETAIL NOTES:**
- 1#6 COPPER TO MINIMUM OF (2) 3/4" x 10'-0" COPPER-BONDED GROUND RODS SPACED MIN. 10'-0" APART. TOP OF RODS SHALL BE BURIED MIN. 12" BELOW FINISHED GRADE.
  - 1#4 COPPER TO BUILDING FOOTING REINFORCING STEEL.
  - 1#4 COPPER TO CONCRETE SLAB REINFORCING STEEL.
  - 1#6 COPPER TO BUILDING STRUCTURAL METAL (INCLUDING METAL ROOF).
  - 1#6 COPPER TO WATER SERVICE METAL PIPING.
  - 1#6 COPPER TO ABOVE-GROUND PROPANE GAS SERVICE METAL PIPING.
  - 1#4 COPPER TO BUILDING STRUCTURAL METAL (INCLUDING METAL ROOF).
  - 1#4 COPPER TO WATER SERVICE METAL PIPING.
  - 1#4 COPPER TO ABOVE-GROUND PROPANE GAS SERVICE METAL PIPING.
  - 1#2 COPPER TO BUILDING STRUCTURAL METAL (INCLUDING METAL ROOF).
  - 1#2 COPPER TO WATER SERVICE METAL PIPING.

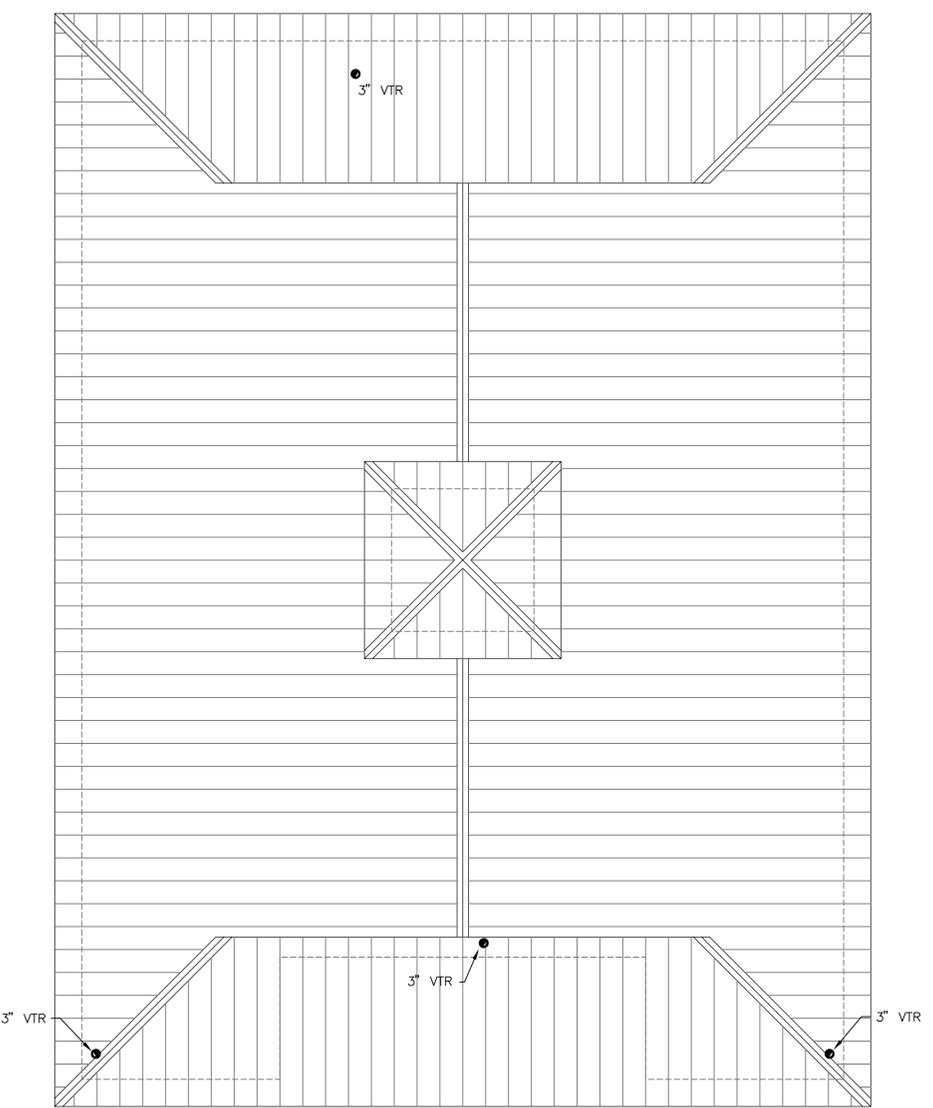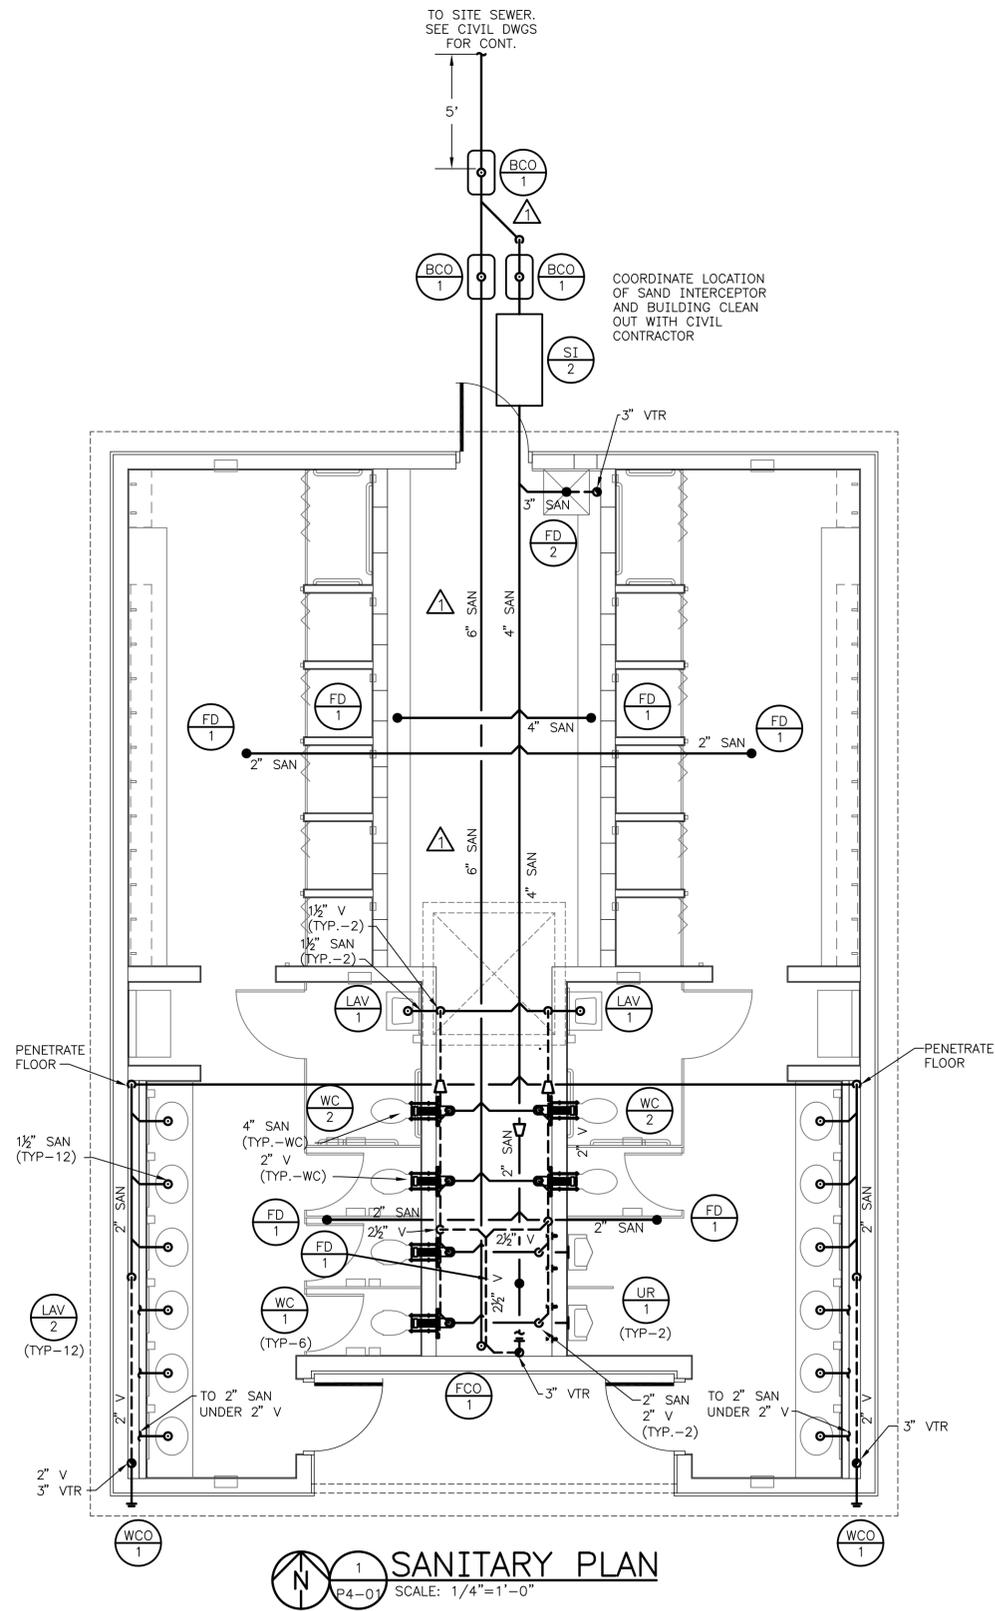

- NOTES:**
1. SEE DETAIL 6/P0-04 FOR JANITORS ROOM DRY VENT DETAIL.
  2. IN AREA'S WHERE WCO & WH-1 ARE TO BE STACKED, CONTRACTOR TO STACK PIPING WITH ADEQUATE CLEARANCE FOR COVER PLATES.

ADDENDUMS / REVISIONS		
△ INCREASED UNDERGROUND SANITARY MAIN TO 6"	MLF	5/17/13

SCALE AS NOTED

INDIAN RIVER INLET PARK ENHANCEMENTS



CONTRACT	BRIDGE NO.	X
T200507303	DRAWN BY:	MLF
COUNTY	CHECKED BY:	JRF
SUSSEX		

RV SHOWER FACILITY BUILDING 4 PLUMBING PLANS (SHEET 1 OF 2)	SHEET NO.
	CD235
	TOTAL SHTS.
	CD282

INCREASE VENT FROM 2" TO 3" MIN OF 12" BELOW ROOF (TYP. ALL)

INCREASE VENT FROM 2" TO 3" MIN OF 12" BELOW ROOF (TYP. ALL)

**1 SANITARY RISER**  
P4-03 SCALE: NONE

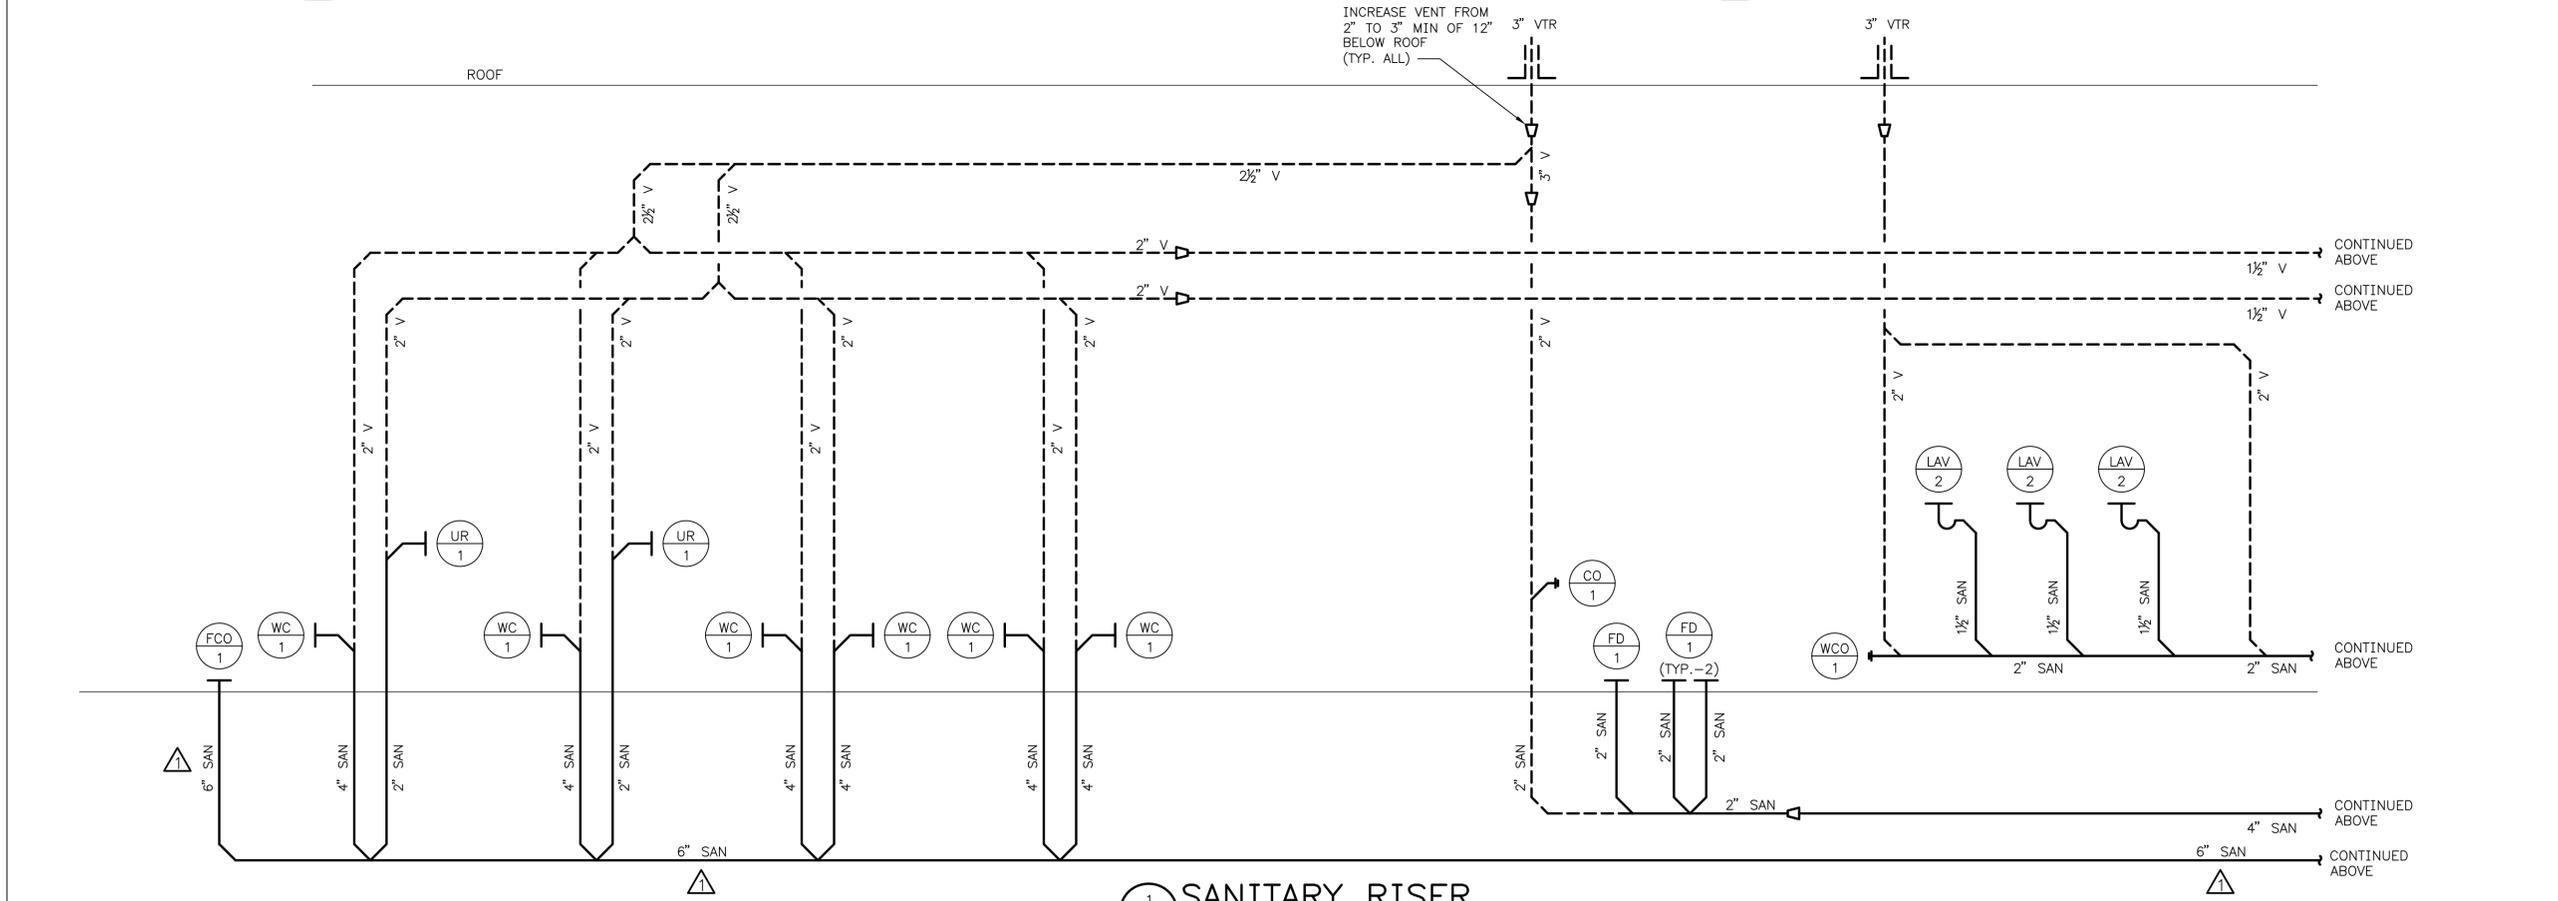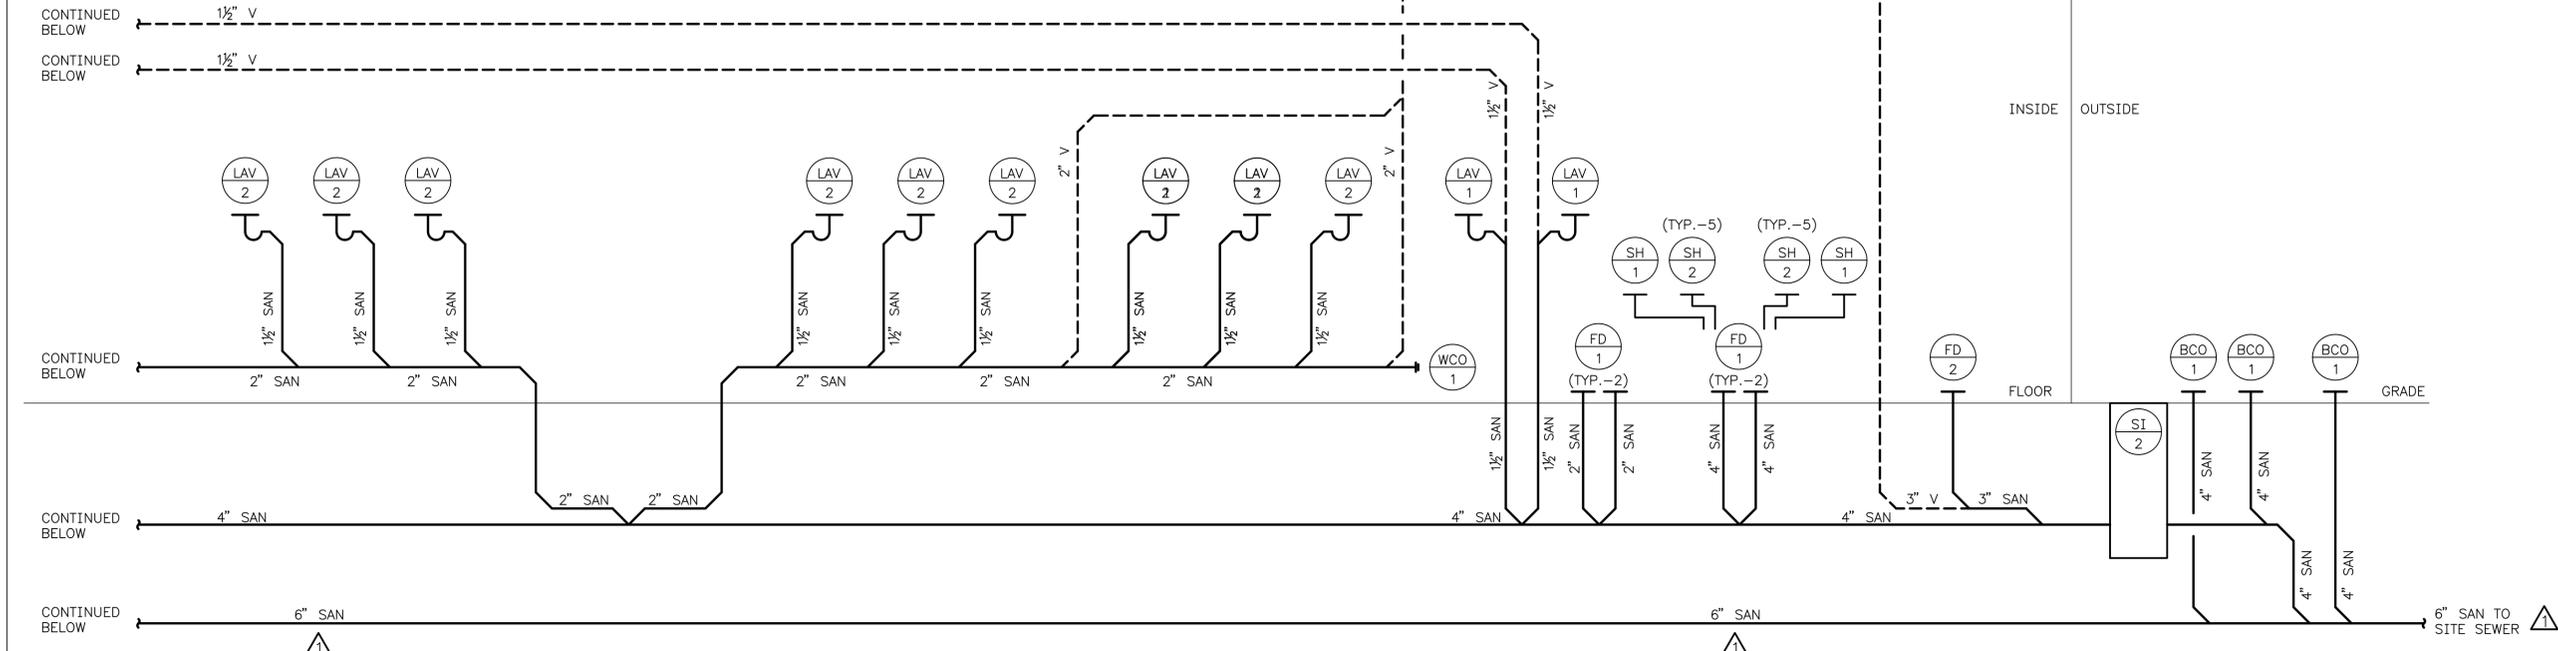

ADDENDUMS / REVISIONS		
▲ INCREASED UNDERGROUND SANITARY MAIN TO 6"	MLF	5/17/13

SCALE AS NOTED


**INDIAN RIVER INLET  
PARK ENHANCEMENTS**

CONTRACT	BRIDGE NO.	X
T200507303	DRAWN BY:	MLF
COUNTY	CHECKED BY:	JRF
SUSSEX		

**RV SHOWER FACILITY  
BUILDING 4  
RISER DIAGRAMS (SHEET 1 OF 3)**


SHEET NO.	CD237
TOTAL SHTS.	CD282

P4-03

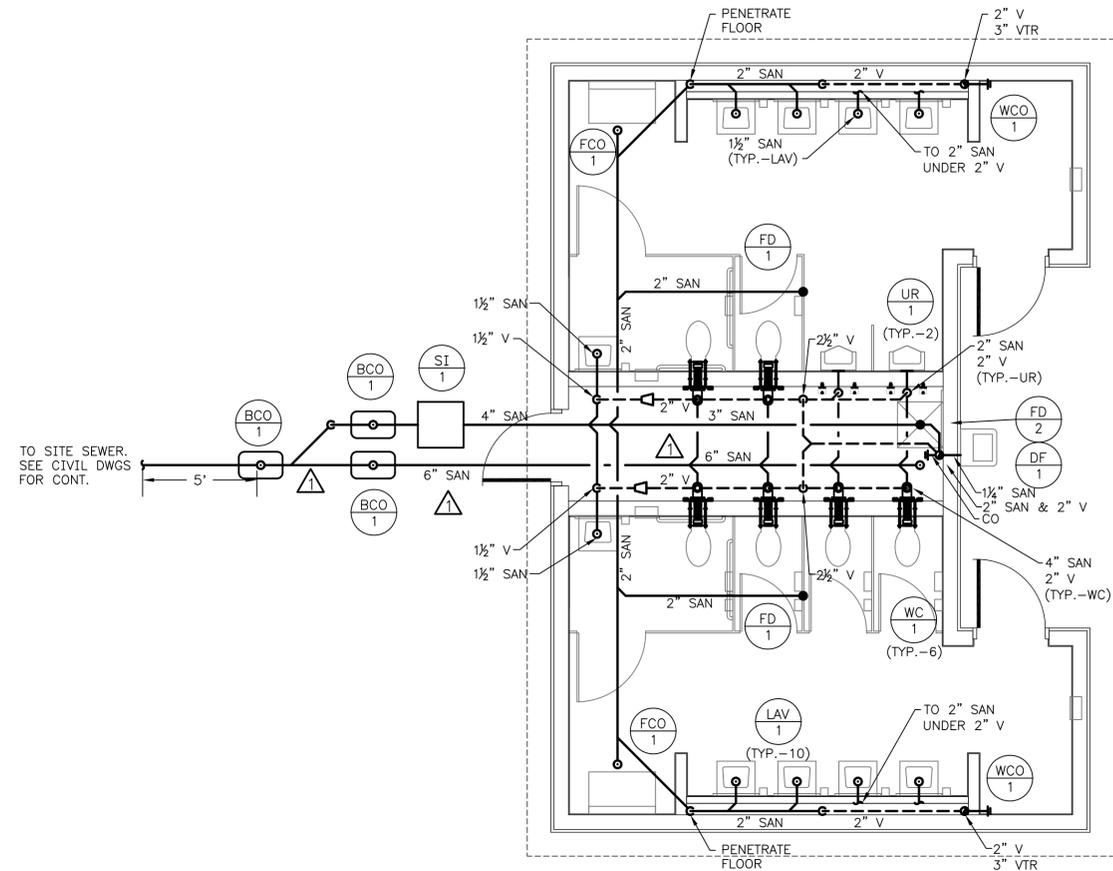

**1 SANITARY PLAN**  
 P5-01 SCALE: 1/4"=1'-0"

- NOTES:**
- SEE DETAIL 6/P0-04 FOR JANITORS ROOM DRY VENT DETAIL.
  - IN AREAS WHERE WCO & WH-1 ARE TO BE STACKED, CONTRACTOR TO STACK PIPING WITH ADEQUATE CLEARANCE FOR COVER PLATES.

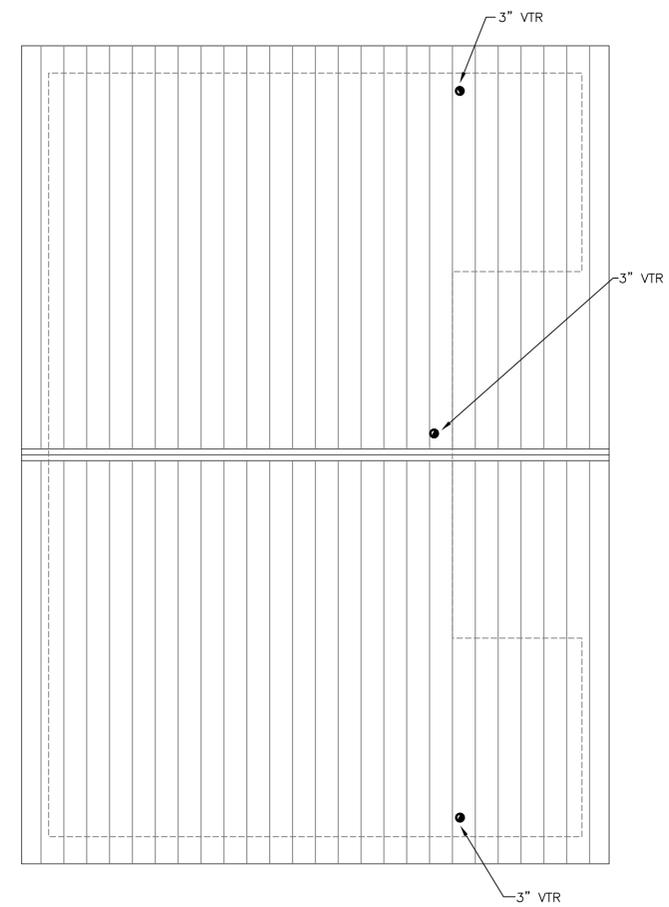

**2 SANITARY ROOF PLAN**  
 P5-01 SCALE: 1/4"=1'-0"

ADDENDUMS / REVISIONS		
▲ INCREASED UNDERGROUND SANITARY MAIN TO 8"	MLF	5/17/13

SCALE AS NOTED



**INDIAN RIVER INLET PARK ENHANCEMENTS**

CONTRACT	BRIDGE NO.	X
T200507303	DRAWN BY:	MLF
COUNTY	CHECKED BY:	JRF
SUSSEX		

**BATH HOUSE BUILDING 5 PLUMBING PLANS (SHEET 1 OF 2)**

SHEET NO.	CD248
TOTAL SHTS.	CD282

P5-01

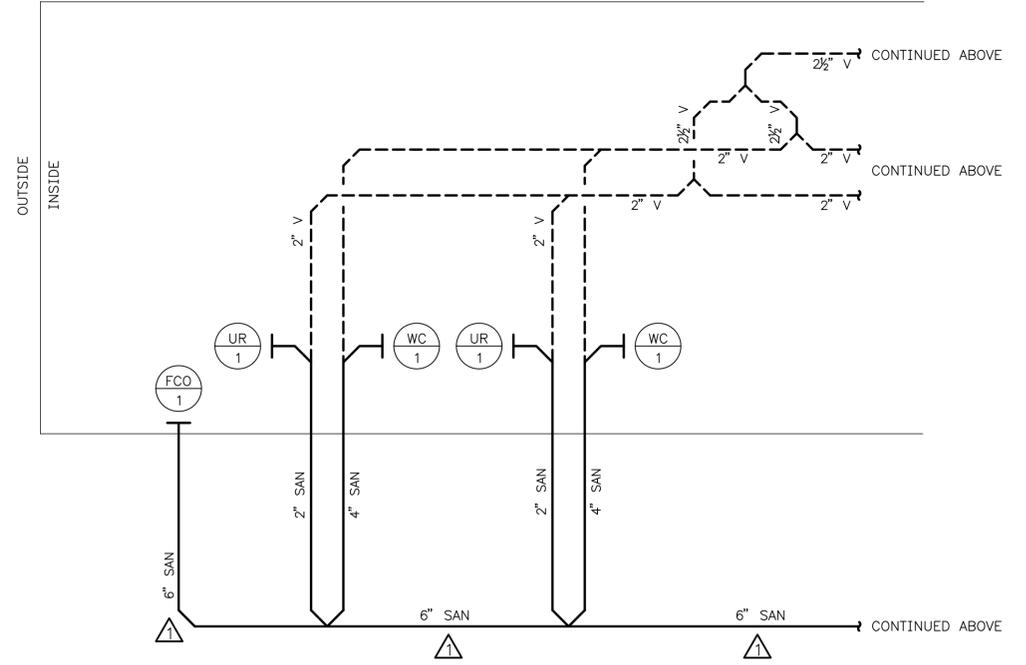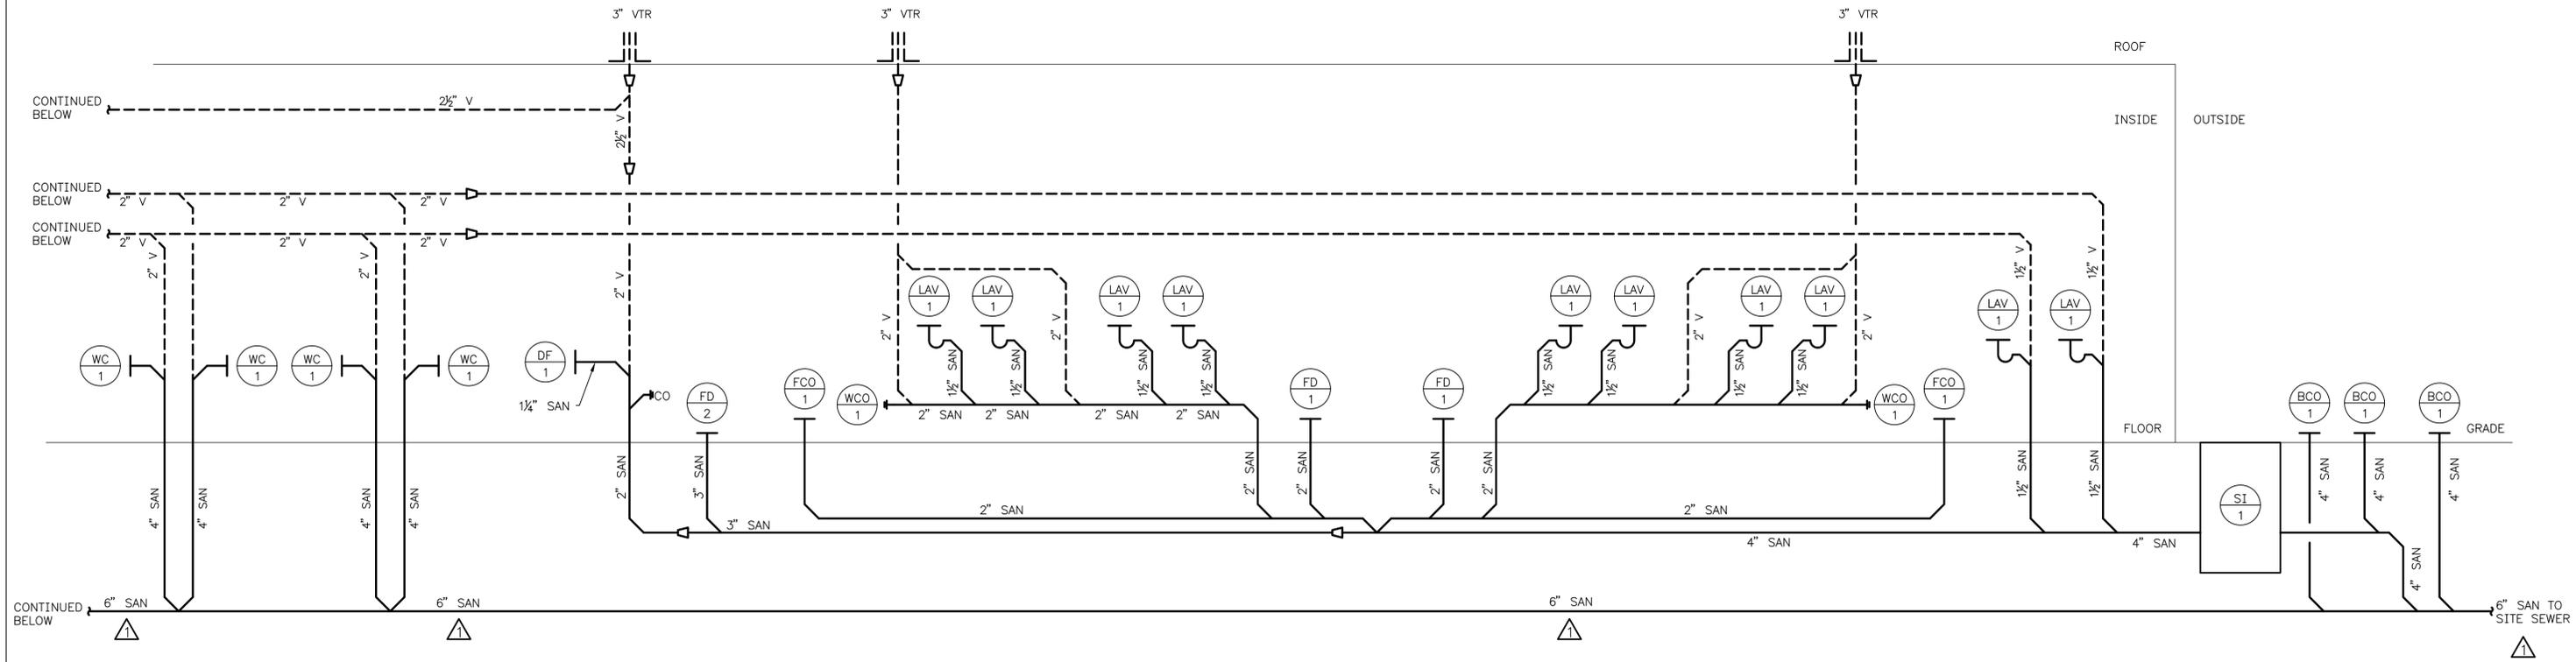

1 SANITARY RISER  
P5-03 SCALE: NONE

ADDENDUMS / REVISIONS		
INCREASED UNDERGROUND SANITARY MAIN TO 6"	MLF	5/17/13

SCALE AS NOTED

INDIAN RIVER INLET PARK ENHANCEMENTS

CONTRACT	BRIDGE NO.	X
T200507303	DRAWN BY:	MLF
COUNTY	CHECKED BY:	JRF
SUSSEX		


BATH HOUSE BUILDING 5 RISER DIAGRAMS (SHEET 1 OF 2)

SHEET NO.	CD250
TOTAL SHTS.	CD282

P5-03

# SHEET NOTES:

- ① 400A, 1Ø, 3W METER SOCKET PER UTILITY REQUIREMENTS (METER PROVIDED BY ELECTRIC UTILITY).
- ② (2) EMPTY 3" SCHEDULE 80 PVC UNDERGROUND CONDUIT STUB-OUTS WITH PULL STRINGS FOR ELECTRICAL SERVICE TO BUILDING (CONDUCTORS PROVIDED BY OTHERS). TOP OF CONDUITS SHALL BE BURIED MINIMUM 36" BELOW FINISHED GRADE. PROVIDE CONTINUOUS DETECTABLE RED WARNING TAPE IN BACKFILL 12" BELOW FINISHED GRADE ("CAUTION - BURIED ELECTRIC LINE BELOW").
- ③ (2) SETS OF 2"Ø: 3#3/Ø.
- ④ SEE DIAGRAM 3/EØ-Ø2 FOR PANELBOARD GROUNDING AND BONDING DETAILS.
- ⑤ SEE EXHAUST FAN WIRING DIAGRAM 2/EØ-Ø2.
- ⑥ ENCLOSED DISCONNECT SWITCH: 6ØA/3P, 6ØØV IN NEMA 4X POLYCARBONATE ENCLOSURE WITH ROTARY HANDLE PADLOCKABLE IN "OFF" POSITION (PROVIDE SQUARE D CLASS 311Ø "MD" SERIES OR APPROVED EQUAL).
- ⑦ CONTROL POWER TRANSFORMER (TRANSFORMER & LOW VOLTAGE CONTROL WIRING PROVIDED BY CONTROLS CONTRACTOR). PRIMARY CIRCUIT TO BE PROVIDED BY ELECTRICAL CONTRACTOR. NOTE: TRANSFORMER TO BE PROVIDED WITH FACTORY-INSTALLED PRIMARY AND SECONDARY FUSE BLOCKS WITH FUSES AS REQUIRED.
- ⑧ MASTER SWITCH CONTROL FOR EXTERIOR RECEPTACLE OUTLETS (PROVIDE LABEL).
- ⑨ TO TOGGLE SWITCH BY CHASE ENTRY DOOR.
- ⑩ EXTERIOR LIGHTING MAINTENANCE SWITCH (PROVIDE LABEL). SEE EXTERIOR LIGHTING CONTROL WIRING DIAGRAM 1/EØ-Ø2.
- ⑪ OUTDOOR PHOTOSENSOR FOR CONTROL OF EXTERIOR LIGHTING FIXTURES (SEE EXTERIOR LIGHTING CONTROL WIRING DIAGRAM 1/EØ-Ø2 FOR DETAILS). MOUNT TO ROOF LINE FASCIA ON NORTH SIDE OF BUILDING.
- ⑫ SECURE LIGHTING FIXTURE TO UNDERSIDE OF ROOF JOISTS.
- ⑬ CHAIN-SUSPEND LIGHTING FIXTURE 8'-Ø" A.F.F. EXACT LOCATION TO BE FIELD-COORDINATED WITH MECHANICAL PIPING & DUCTWORK (TYP. OF 2).
- ⑭ POWER RELAY PACK WITH OCCUPANCY SENSORS FOR CONTROL OF BATHROOM LIGHTING FIXTURES. CONNECT PER MANUFACTURER'S WIRING INSTRUCTIONS.
- ⑮ MASTER-OFF SWITCHES FOR MEN'S & WOMEN'S ROOM LIGHTING FIXTURES (PROVIDE LABELS). CONNECT PER OCCUPANCY SENSOR MANUFACTURER'S WIRING INSTRUCTIONS.
- ⑯ JUNCTION BOX FOR HAND DRYER (51ØW, 12ØV, 1Ø). FIELD-COORDINATE EXACT LOCATION AND PROVIDE ALL CIRCUITING TO HAND DRYER AS REQUIRED PER DRYER MANUFACTURER'S INSTALLATION INSTRUCTIONS.
- ⑰ EMPTY 2-1/2" SCHEDULE 8Ø PVC UNDERGROUND CONDUIT STUB-ØUT WITH PULL STRING FOR ELECTRICAL FEEDER TO ADMINISTRATION CONTACT STATION (CONDUCTORS PROVIDED BY OTHERS). TOP OF CONDUIT SHALL BE BURIED MINIMUM 36" BELOW FINISHED GRADE. PROVIDE CONTINUOUS DETECTABLE RED WARNING TAPE IN BACKFILL 12" BELOW FINISHED GRADE ("CAUTION - BURIED ELECTRIC LINE BELOW").
- ⑱ EMPTY 1" SCHEDULE 8Ø PVC UNDERGROUND CONDUIT STUB-ØUT WITH PULL STRING FOR SITE LIGHTING BRANCH CIRCUIT (CONDUCTORS PROVIDED BY OTHERS). TOP OF CONDUIT SHALL BE BURIED MINIMUM 36" BELOW FINISHED GRADE. PROVIDE CONTINUOUS DETECTABLE RED WARNING TAPE IN BACKFILL 12" BELOW FINISHED GRADE ("CAUTION - BURIED ELECTRIC LINE BELOW").
- ⑲ EMPTY 1" SCHEDULE 8Ø PVC UNDERGROUND CONDUIT STUB-ØUT WITH PULL STRING FOR PAVILION 7A LIGHTING & RECEPTACLE BRANCH CIRCUITS (CONDUCTORS PROVIDED BY OTHERS). TOP OF CONDUIT SHALL BE BURIED MINIMUM 36" BELOW FINISHED GRADE. PROVIDE CONTINUOUS DETECTABLE RED WARNING TAPE IN BACKFILL 12" BELOW FINISHED GRADE ("CAUTION - BURIED ELECTRIC LINE BELOW").
- ⑲ EMPTY 1" SCHEDULE 8Ø PVC UNDERGROUND CONDUIT STUB-ØUT WITH PULL STRING FOR POST-MOUNTED GFCI RECEPTACLE BRANCH CIRCUIT (CONDUCTORS PROVIDED BY OTHERS). TOP OF CONDUIT SHALL BE BURIED MINIMUM 36" BELOW FINISHED GRADE. PROVIDE CONTINUOUS DETECTABLE RED WARNING TAPE IN BACKFILL 12" BELOW FINISHED GRADE ("CAUTION - BURIED ELECTRIC LINE BELOW").
- ⑲ TIME CLOCK CONTROL FOR EXHAUST FAN EF/3 (TIME CLOCK & CONTROL WIRING TO EXHAUST FAN PROVIDED BY CONTROLS CONTRACTOR). POWER SUPPLY CIRCUIT TO BE PROVIDED BY ELECTRICAL CONTRACTOR.

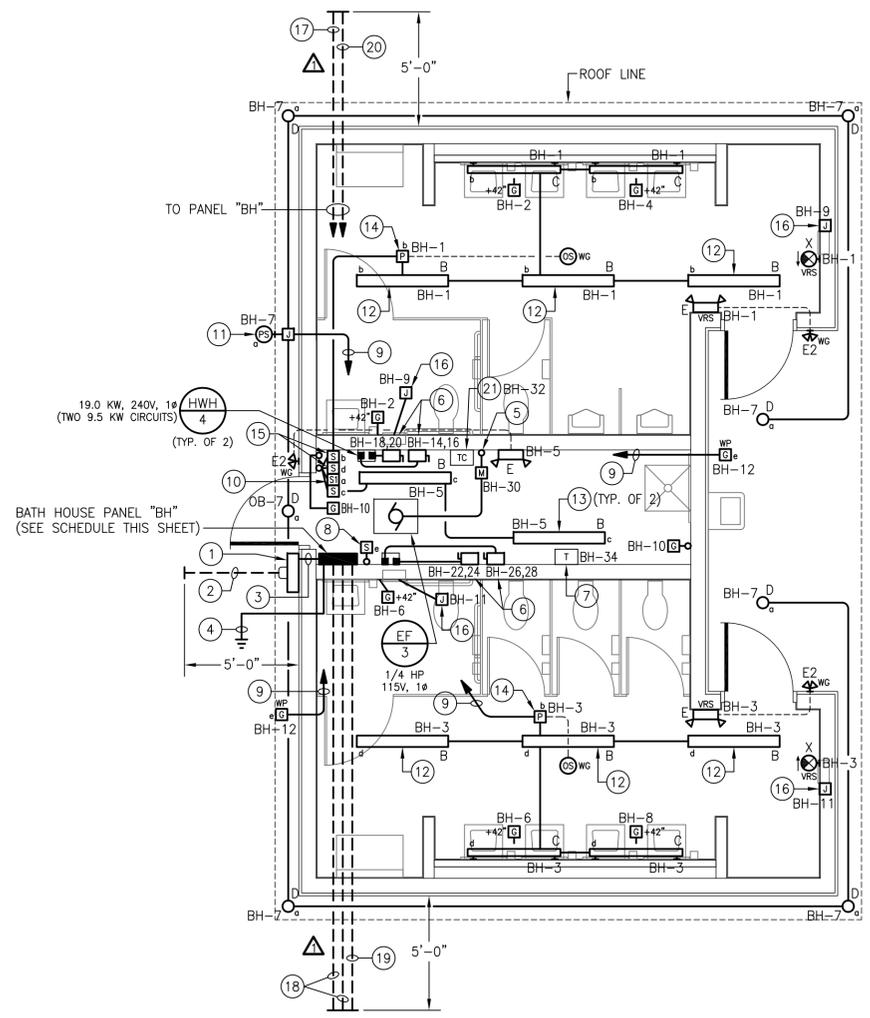


**BATH HOUSE - ELECTRICAL PLAN**  
 SCALE: 1/4"=1'-0"  
 E5-Ø1

## PANELBOARD "BH" SCHEDULE


LOCATION: BATH HOUSE TYPE: 24Ø/12ØV, 1Ø, 3W  
 SOURCE: UTILITY TRANSFORMER MAIN BREAKER: 4ØØA

DESCRIPTION	BRKR SIZE	CIR NO	A <sup>b</sup> B <sup>a</sup>	CIR NO	BRKR SIZE	DESCRIPTION
LTG - MEN'S ROOM	2ØA	1		2	2ØA	REC - MEN'S ROOM
LTG - WOMEN'S ROOM	2ØA	3		4	2ØA	REC - MEN'S ROOM
LTG - CHASE	2ØA	5		6	2ØA	REC - WOMEN'S ROOM
LTG - EXTERIOR	2ØA	7		8	2ØA	REC - WOMEN'S ROOM
HAND DRYERS (MEN'S)	2ØA	9		1Ø	2ØA	REC - CHASE
HAND DRYERS (WOMEN'S)	2ØA	11		12	2ØA	REC - EXTERIOR
SPARE	2ØA	13		14	5ØA	INSTANTANEOUS WTR. HTR. (MEN'S) - CIRC. #1
SPARE	2ØA	15		16	5ØA	INSTANTANEOUS WTR. HTR. (MEN'S) - CIRC. #2
SPARE	2ØA	17		18	5ØA	INSTANTANEOUS WTR. HTR. (MEN'S) - CIRC. #2
SPARE	2ØA	19		2Ø	5ØA	INSTANTANEOUS WTR. HTR. (WOMEN'S) - CIRC. #1
SPARE	2ØA	21		22	5ØA	INSTANTANEOUS WTR. HTR. (WOMEN'S) - CIRC. #1
SPARE	2ØA	23		24	5ØA	INSTANTANEOUS WTR. HTR. (WOMEN'S) - CIRC. #2
PREPARED SPACE	-	25		26	5ØA	INSTANTANEOUS WTR. HTR. (WOMEN'S) - CIRC. #2
PREPARED SPACE	-	27		28	5ØA	INSTANTANEOUS WTR. HTR. (WOMEN'S) - CIRC. #2
PREPARED SPACE	-	29		3Ø	15A	EXHAUST FAN
PREPARED SPACE	-	31		32	15A	EXH. FAN TIME CLOCK CONTROL
(RESERVED FOR POST MID. REC'S)	2ØA	33		34	2ØA	CONTROL POWER XFMR
(RESERVED FOR PAVILION 7A LTG.)	2ØA	35		36	2ØA	SPARE
(RESERVED FOR PAVILION 7A REC'S)	2ØA	37		38	2ØA	SPARE
(RESERVED FOR SITE LTG.)	2ØA	39		4Ø	6ØA	(RESERVED FOR FEEDER TO ADMIN. CONTACT STATION)
(RESERVED FOR SITE LTG.)	2ØA	41		42	6ØA	(RESERVED FOR FEEDER TO ADMIN. CONTACT STATION)


- PANEL NOTES:**
1. PANELBOARD ASSEMBLY SHALL BE SUITABLE FOR USE AS SERVICE EQUIPMENT.
  2. UL SHORT CIRCUIT CURRENT RATING OF PANELBOARD AND UL INTERRUPT RATINGS OF ALL CIRCUIT BREAKERS WITHIN PANELBOARD SHALL BE COORDINATED WITH AVAILABLE FAULT CURRENT AT PANELBOARD PRIOR TO PURCHASING EQUIPMENT. COORDINATE WITH ELECTRIC UTILITY AND SITE ENGINEER.
  3. ALL CIRCUIT BREAKERS WITHIN PANELBOARD SHALL BE HACR RATED.

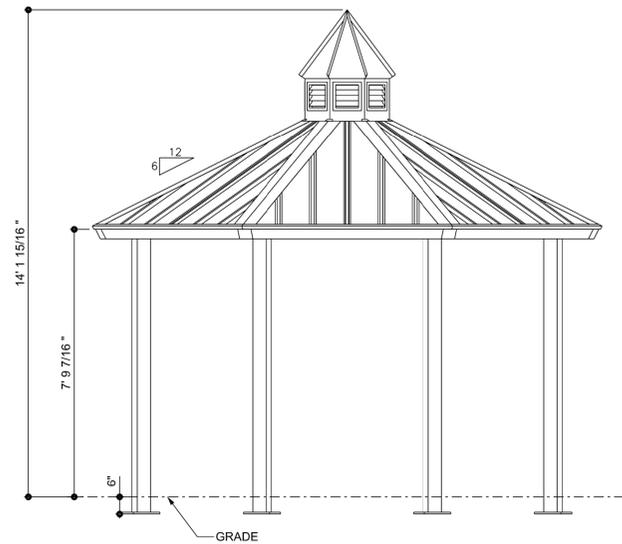



**4 ELEVATION - 16' PAVILION**  
SCALE: 3/8"= 1'-0"

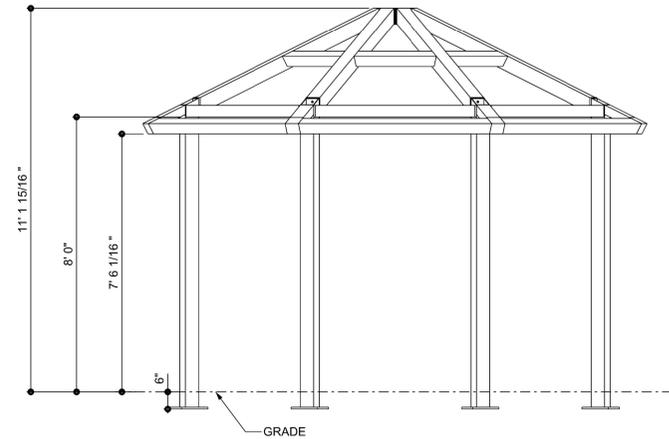


ALL STRUCTURAL COMPONENTS WILL BE:  
TUBE: ASTM A500 GRADE B  
PLATE: ASTM A36  
BOLTS: ASTM A325  
NUTS: ASTM A563  
WELDING: GMAW  
NOTE:  
COLUMN SIZE: HSS 5X5X3/16

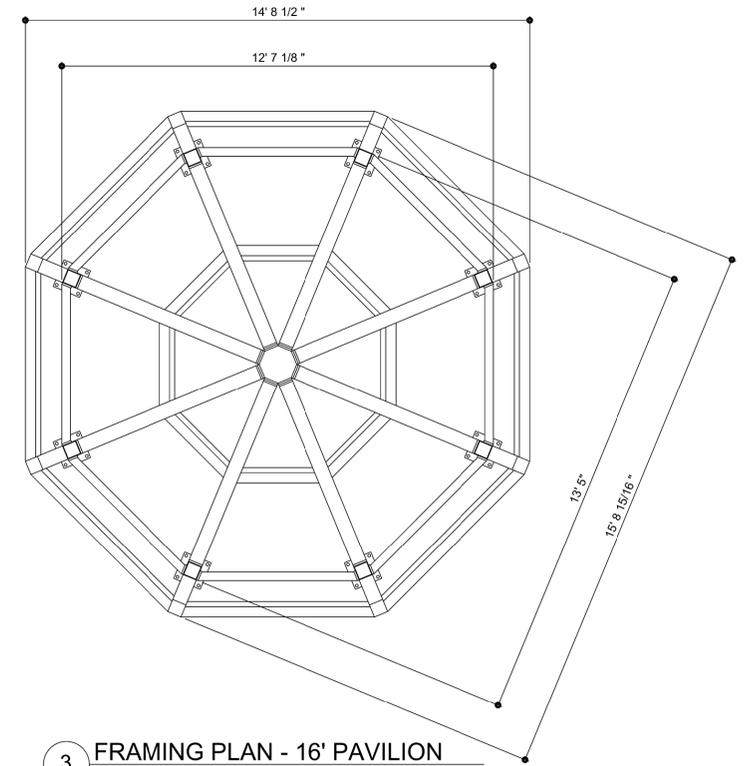

**3 FRAMING PLAN - 16' PAVILION**  
SCALE: 3/8"= 1'-0"

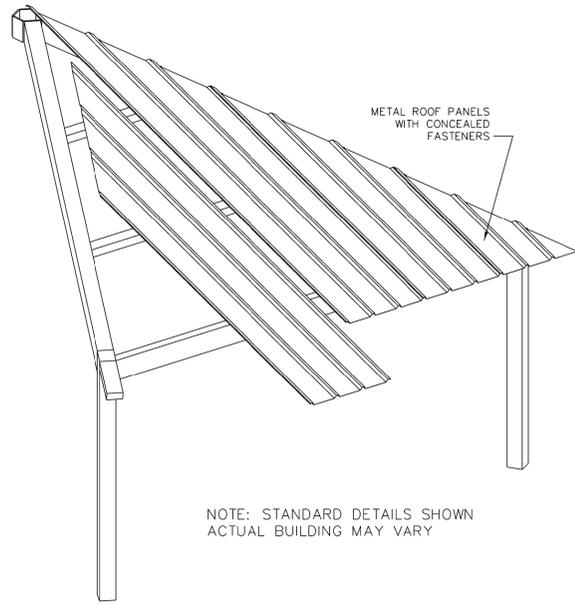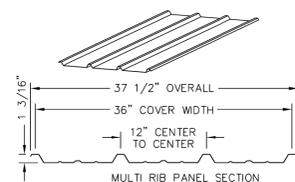

NOTE: STANDARD DETAILS SHOWN  
ACTUAL BUILDING MAY VARY

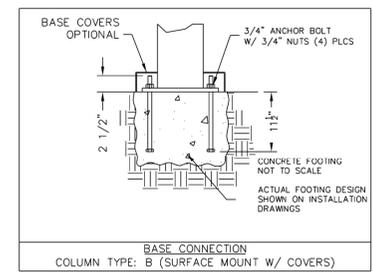

**2 FOUNDATION DETAILS - 16' PAVILION**  
SCALE: NTS


NOTES:  
1. SHADE STRUCTURES SHOWN ARE BASIS-OF-DESIGN ICON SHELTER SYSTEMS, INC. OTHER ACCEPTABLE MANUFACTURERS ARE CLASSIC RECREATION SYSTEMS, INC. & POLIGON, OR EQUIVALENT.  
2. SHADE STRUCTURE MANUFACTURER IS RESPONSIBLE FOR ENGINEERING THE STRUCTURE, AND PROVIDE LOAD AND REACTION INFORMATION TO FOUNDATION DESIGN ENGINEER.  
3. SHADE STRUCTURE TO BE ENGINEERED AS AN OPEN-AIR STRUCTURE, NO SIDE WALLS.  
4. CONTRACTOR IS RESPONSIBLE TO ENGINEER AND PROVIDE THE CONCRETE FOUNDATIONS FOR THE STRUCTURES.

DEFINITIONS:  
DL = SERVICE LEVEL DEAD LOAD REACTION WITH THE GREATEST AXIAL LOAD  
SL = SERVICE LEVEL SNOW LOAD REACTION WITH THE GREATEST AXIAL LOAD  
W-UL = SERVICE LEVEL WIND LOAD REACTION WITH THE GREATEST UPLIFT LOAD  
W-Y = SERVICE LEVEL WIND LOAD REACTION WITH THE GREATEST MAGNITUDE OF SHEAR IN THE LOCAL Y DIRECTION  
W-Z = SERVICE LEVEL WIND LOAD REACTION WITH THE GREATEST SHEAR VALUE ACTING IN THE SAME DIRECTION AS THE DL SHEAR LOAD  
E-Y = SERVICE LEVEL SEISMIC LOAD REACTION WITH THE GREATEST MAGNITUDE OF SHEAR IN THE LOCAL Y DIRECTION  
E-Z = SERVICE LEVEL SEISMIC LOAD REACTION WITH THE GREATEST MAGNITUDE OF SHEAR IN THE LOCAL Z DIRECTION

Z (INSIDE OF BUILDING)  
Y  
X  
THESE FOUNDATION LOADS ARE FOR ESTIMATING PURPOSE ONLY. THE ACTUAL LOADS WILL BE DETERMINED IN THE FINAL ENGINEERING.

LOAD COMBINATION	FOUNDATION LOADS					
	AXIAL (Fx)	SHEAR (Fy)	SHEAR (Fz)	MOMENT (My)	MOMENT (Mz)	
DL	0.33	0.00	0.00	0.13	0.00	
SL	0.45	0.00	0.00	-0.10	0.00	
W-UPLIFT	-0.36	0.11	-0.02	2.03	6.38	
W-FY	-0.26	-0.11	0.02	-1.95	-6.36	
W-FZ	-0.35	-0.04	-0.06	4.87	-2.66	
E-FY	-0.01	-0.02	0.00	0.34	-1.09	
E-Z	-0.02	-0.01	-0.01	0.82	-0.45	


NOTE:  
1. POST LOCATIONS TO BE COORDINATED TO NOT INTERFERE WITH ACCESSIBILITY TO COMPLY TO ANSI A117.1 THE AMERICANS WITH DISABILITIES ACT (ADA) AND THE STATE OF DELAWARE'S ARCHITECTURAL ACCESSIBILITY BOARD.

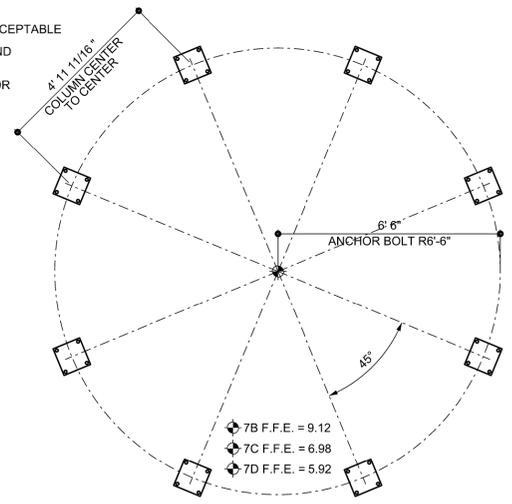

**1 FOUNDATION PLAN - 16' PAVILION**  
SCALE: 3/8"= 1'-0"

**SHEET NOTES:**

- ① EMPTY 1" SCHEDULE 80 PVC UNDERGROUND CONDUIT STUB-OUT WITH PULL STRING FOR LIGHTING & RECEPTACLE BRANCH CIRCUITS TO PAVILION (CONDUCTORS PROVIDED BY OTHERS). TOP OF CONDUIT SHALL BE BURIED MINIMUM 36" BELOW FINISHED GRADE. PROVIDE CONTINUOUS DETECTABLE RED WARNING TAPE IN BACKFILL 12" BELOW FINISHED GRADE ("CAUTION - BURIED ELECTRIC LINE BELOW").
- ② PROVIDE WEATHERPROOF JUNCTION BOX SIZED AS REQUIRED TO DO THE FOLLOWING:
  - A. TERMINATE CIRCUITS -A & -B FOR CONNECTION TO BRANCH CIRCUIT CONDUCTORS BY OTHERS. PROVIDE MINIMUM 12" OF SLACK FOR EACH CIRCUIT.
  - B. PROVIDE EQUIPMENT GROUNDING BUS SIZED AS REQUIRED TO TERMINATE EQUIPMENT GROUNDING CONDUCTORS AND GROUNDING ELECTRODE CONDUCTOR. EQUIPMENT GROUNDING BUS SHALL BE BONDED TO JUNCTION BOX HOUSING. NEUTRAL CONDUCTORS SHALL NOT BE BONDED TO EQUIPMENT GROUNDS ANYWHERE AT PAVILION.
- ③ PROVIDE THE FOLLOWING GROUNDING ELECTRODE CONDUCTORS FROM EQUIPMENT GROUNDING BUS IN JUNCTION BOX:
  - A. 1#6 COPPER TO MINIMUM OF (2) 3/4" x 10'-0" COPPER-BONDED GROUND RODS SPACED MINIMUM 10'-0" APART. TOP OF RODS SHALL BE BURIED MINIMUM 12" BELOW FINISHED GRADE.
  - B. 1#6 COPPER TO BUILDING STRUCTURAL METAL (INCLUDING METAL ROOF).
- ④ PAVILION LIGHTING MAINTENANCE SWITCH; SEE EXTERIOR LIGHTING CONTROL WIRING DIAGRAM 1/E0-02.
- ⑤ OUTDOOR PHOTOSENSOR FOR CONTROL OF PAVILION LIGHTING FIXTURES (SEE EXTERIOR LIGHTING CONTROL WIRING DIAGRAM 1/E0-02 FOR DETAILS). MOUNT AS REQUIRED ON NORTH SIDE OF STRUCTURE.
- ⑥ PROVIDE VERTICAL WEATHERPROOF WHILE-IN-USE DEVICE COVER. COVER SHALL BE HEAVY DUTY GRAY DIE-CAST ALUMINUM OR ZINC (HUBBELL CAT. NO. WP826 OR APPROVED EQUAL BY PASS & SEYMOUR).
- ⑦ ROUTE CIRCUITING WITHIN STRUCTURAL POST; COORDINATE WITH ARCHITECTURAL PLANS.

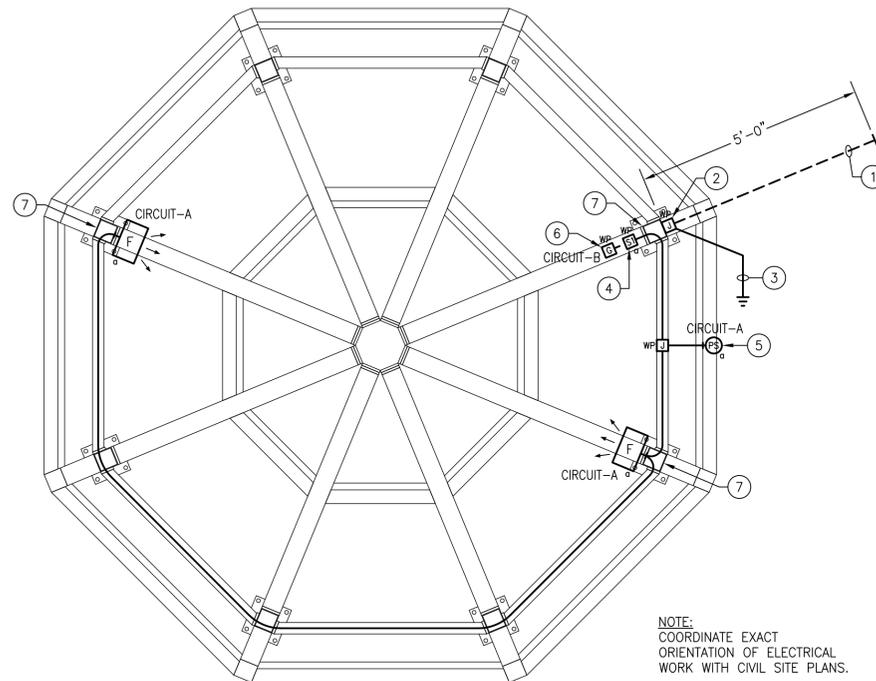

① 16' SHADE PAVILION - ELECTRICAL PLAN  
 E7-01 SCALE: 1/2" = 1'-0"


ADDENDUMS / REVISIONS	
NEW SHEET: A.H.H. 05/17/13	

SCALE AS NOTED

CONTRACT	BRIDGE NO.	X
T200507303	DRAWN BY:	AHH
COUNTY	CHECKED BY:	JRF
SUSSEX		


SHEET NO.	CD253A
TOTAL SHTS.	
	CD282

A7-01A

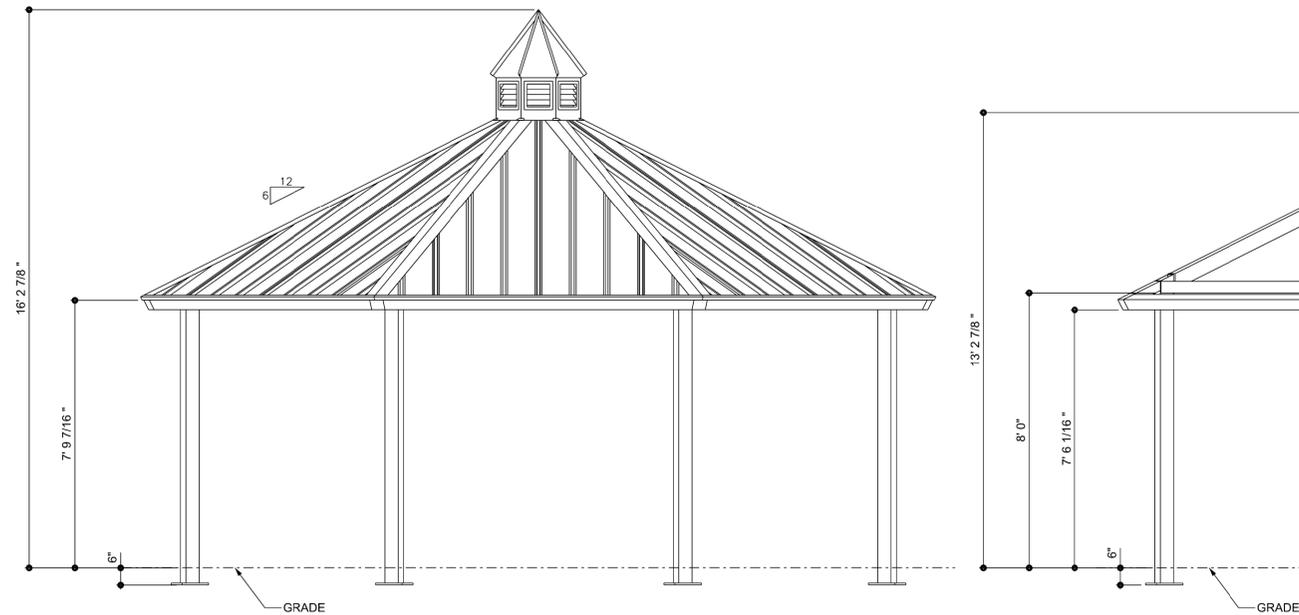


**4 ELEVATION - 25' PAVILION**  
SCALE: 3/8"=1'-0"


ALL STRUCTURAL COMPONENTS WILL BE:  
TUBE: ASTM A500 GRADE B  
PLATE: ASTM A36  
BOLTS: ASTM A325  
NUTS: ASTM A563  
WELDING: GMAW  
NOTE:  
COLUMN SIZE: HSS 5X5X3/16

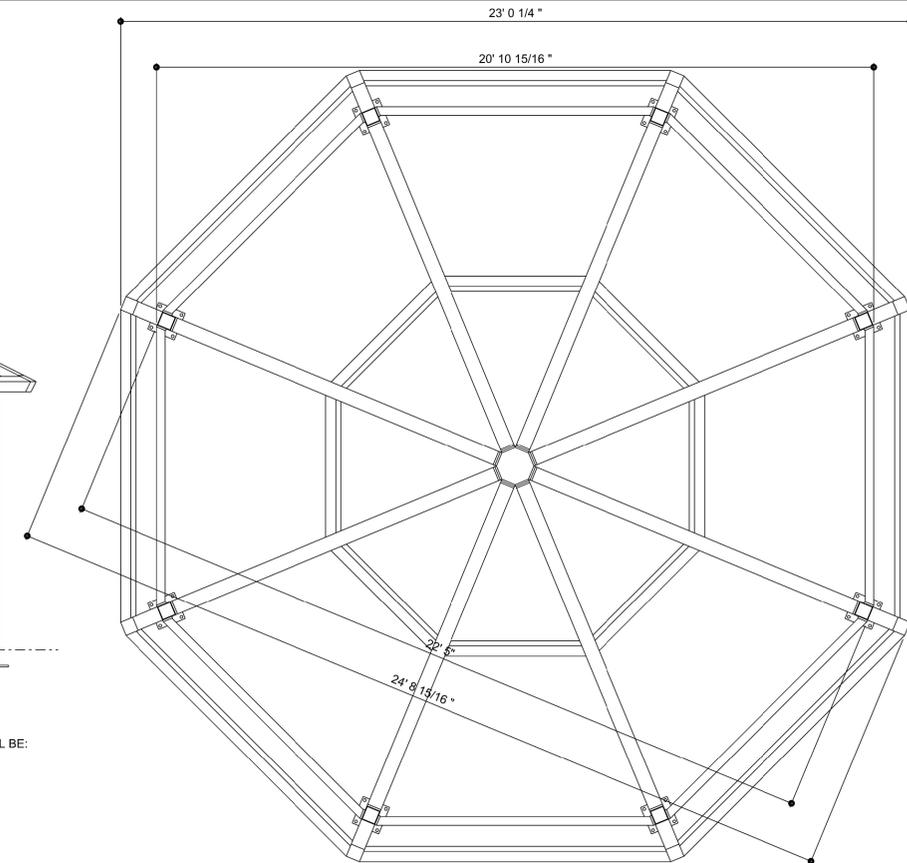


**3 FRAMING PLAN - 25' PAVILION**  
SCALE: 3/8"=1'-0"

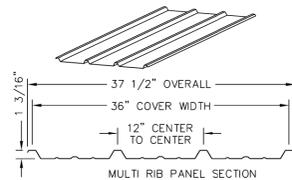

MULTI RIB PANEL SECTION

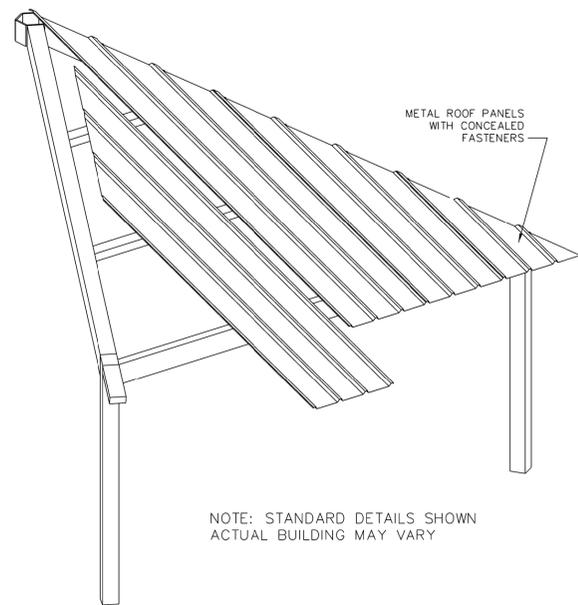

NOTE: STANDARD DETAILS SHOWN  
ACTUAL BUILDING MAY VARY

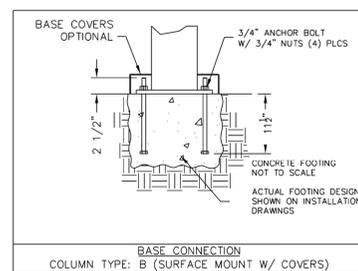

**2 FOUNDATION DETAILS - 25' PAVILION**  
SCALE: NTS


NOTES:  
1. SHADE STRUCTURES SHOWN ARE BASIS-OF-DESIGN ICON SHELTER SYSTEMS, INC. OTHER ACCEPTABLE MANUFACTURERS ARE CLASSIC RECREATION SYSTEMS, INC. & POLIGON, OR EQUIVALENT.  
2. SHADE STRUCTURE MANUFACTURER IS RESPONSIBLE FOR ENGINEERING THE STRUCTURE, AND PROVIDE LOAD AND REACTION INFORMATION TO FOUNDATION DESIGN ENGINEER.  
3. SHADE STRUCTURE TO BE ENGINEERED AS AN OPEN-AIR STRUCTURE, NO SIDE WALLS.  
4. CONTRACTOR IS RESPONSIBLE TO ENGINEER AND PROVIDE THE CONCRETE FOUNDATIONS FOR THE STRUCTURES.

DEFINITIONS:  
DL = SERVICE LEVEL DEAD LOAD REACTION WITH THE GREATEST AXIAL LOAD  
SL = SERVICE LEVEL SNOW LOAD REACTION WITH THE GREATEST AXIAL LOAD  
W-UL = SERVICE LEVEL WIND LOAD REACTION WITH THE GREATEST UPLIFT LOAD  
W-Y = SERVICE LEVEL WIND LOAD REACTION WITH THE GREATEST MAGNITUDE OF SHEAR IN THE LOCAL Y DIRECTION  
W-Z = SERVICE LEVEL WIND LOAD REACTION WITH THE GREATEST SHEAR VALUE ACTING IN THE SAME DIRECTION AS THE DL SHEAR LOAD  
E-Y = SERVICE LEVEL SEISMIC LOAD REACTION WITH THE GREATEST MAGNITUDE OF SHEAR IN THE LOCAL Y DIRECTION  
E-Z = SERVICE LEVEL SEISMIC LOAD REACTION WITH THE GREATEST MAGNITUDE OF SHEAR IN THE LOCAL Z DIRECTION

Z (INSIDE OF BUILDING)  
Y  
X  
THESE FOUNDATION LOADS ARE FOR ESTIMATING PURPOSE ONLY. THE ACTUAL LOADS WILL BE DETERMINED IN THE FINAL ENGINEERING.

LOAD COMBINATION	FOUNDATION LOADS				
	AXIAL (Fx)	SHEAR (Fy)	SHEAR (Fz)	MOMENT (My)	MOMENT (Mz)
DL	0.33	0.00	0.00	0.13	0.00
SL	0.45	0.00	0.00	-0.10	0.00
W-UPLIFT	-0.36	0.11	-0.02	2.03	6.38
W-FY	-0.26	-0.11	0.02	-1.95	-6.36
W-FZ	-0.35	-0.04	-0.06	4.87	-2.66
E-FY	-0.01	-0.02	0.00	0.34	-1.09
E-Z	-0.02	-0.01	-0.01	0.82	-0.45


NOTE:  
1. POST LOCATIONS TO BE COORDINATED TO NOT INTERFERE WITH ACCESSIBILITY TO COMPLY TO ANSI A117.1 THE AMERICANS WITH DISABILITIES ACT (ADA) AND THE STATE OF DELAWARE'S ARCHITECTURAL ACCESSIBILITY BOARD.

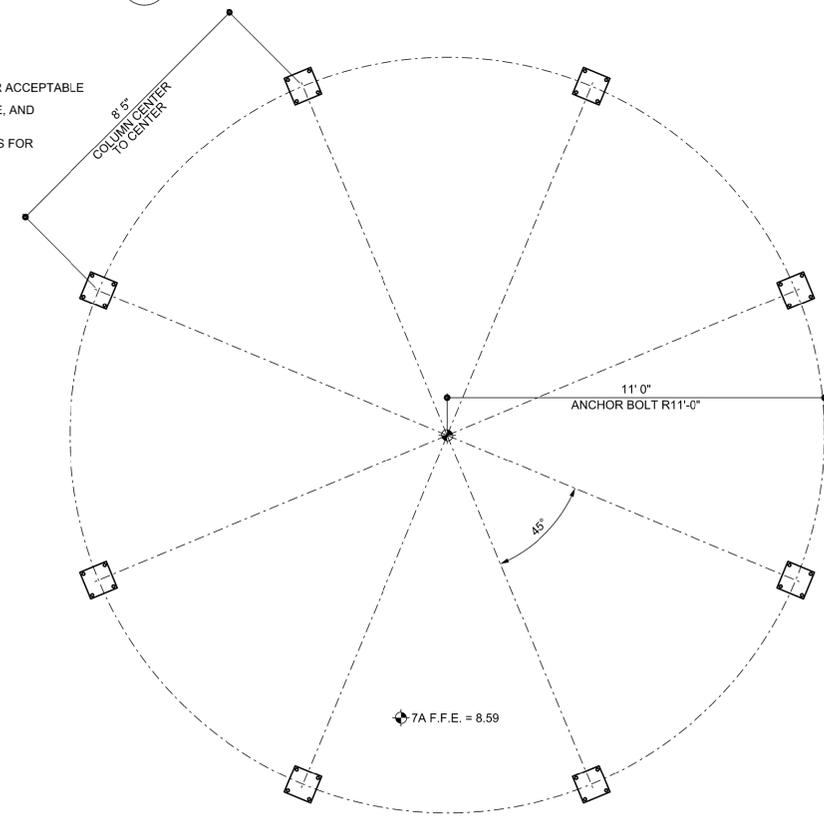

**1 FOUNDATION PLAN - 25' PAVILION**  
SCALE: 3/8"=1'-0"

**SHEET NOTES:**

- ① EMPTY 1" SCHEDULE 80 PVC UNDERGROUND CONDUIT STUB-OUT WITH PULL STRING FOR LIGHTING & RECEPTACLE BRANCH CIRCUITS TO PAVILION (CONDUCTORS PROVIDED BY OTHERS). TOP OF CONDUIT SHALL BE BURIED MINIMUM 36" BELOW FINISHED GRADE. PROVIDE CONTINUOUS DETECTABLE RED WARNING TAPE IN BACKFILL 12" BELOW FINISHED GRADE ("CAUTION - BURIED ELECTRIC LINE BELOW").
- ② PROVIDE WEATHERPROOF JUNCTION BOX SIZED AS REQUIRED TO DO THE FOLLOWING:
  - A. TERMINATE CIRCUITS -A & -B FOR CONNECTION TO BRANCH CIRCUIT CONDUCTORS BY OTHERS. PROVIDE MINIMUM 12" OF SLACK FOR EACH CIRCUIT.
  - B. PROVIDE EQUIPMENT GROUNDING BUS SIZED AS REQUIRED TO TERMINATE EQUIPMENT GROUNDING CONDUCTORS AND GROUNDING ELECTRODE CONDUCTOR. EQUIPMENT GROUNDING BUS SHALL BE BONDED TO JUNCTION BOX HOUSING. NEUTRAL CONDUCTORS SHALL NOT BE BONDED TO EQUIPMENT GROUNDS ANYWHERE AT PAVILION.
- ③ PROVIDE THE FOLLOWING GROUNDING ELECTRODE CONDUCTORS FROM EQUIPMENT GROUNDING BUS IN JUNCTION BOX:
  - A. 1#6 COPPER TO MINIMUM OF (2) 3/4" x 10'-0" COPPER-BONDED GROUND RODS SPACED MINIMUM 10'-0" APART. TOP OF RODS SHALL BE BURIED MINIMUM 12" BELOW FINISHED GRADE.
  - B. 1#6 COPPER TO BUILDING STRUCTURAL METAL (INCLUDING METAL ROOF).
- ④ PAVILION LIGHTING MAINTENANCE SWITCH; SEE EXTERIOR LIGHTING CONTROL WIRING DIAGRAM 1/E0-02.
- ⑤ OUTDOOR PHOTOSENSOR FOR CONTROL OF PAVILION LIGHTING FIXTURES (SEE EXTERIOR LIGHTING CONTROL WIRING DIAGRAM 1/E0-02 FOR DETAILS). MOUNT AS REQUIRED ON NORTH SIDE OF STRUCTURE.
- ⑥ PROVIDE VERTICAL WEATHERPROOF WHILE-IN-USE DEVICE COVER. COVER SHALL BE HEAVY DUTY GRAY DIE-CAST ALUMINUM OR ZINC (HUBBELL CAT. NO. WP826 OR APPROVED EQUAL BY PASS & SEYMOUR).
- ⑦ ROUTE CIRCUITING WITHIN STRUCTURAL POST; COORDINATE WITH ARCHITECTURAL PLANS.

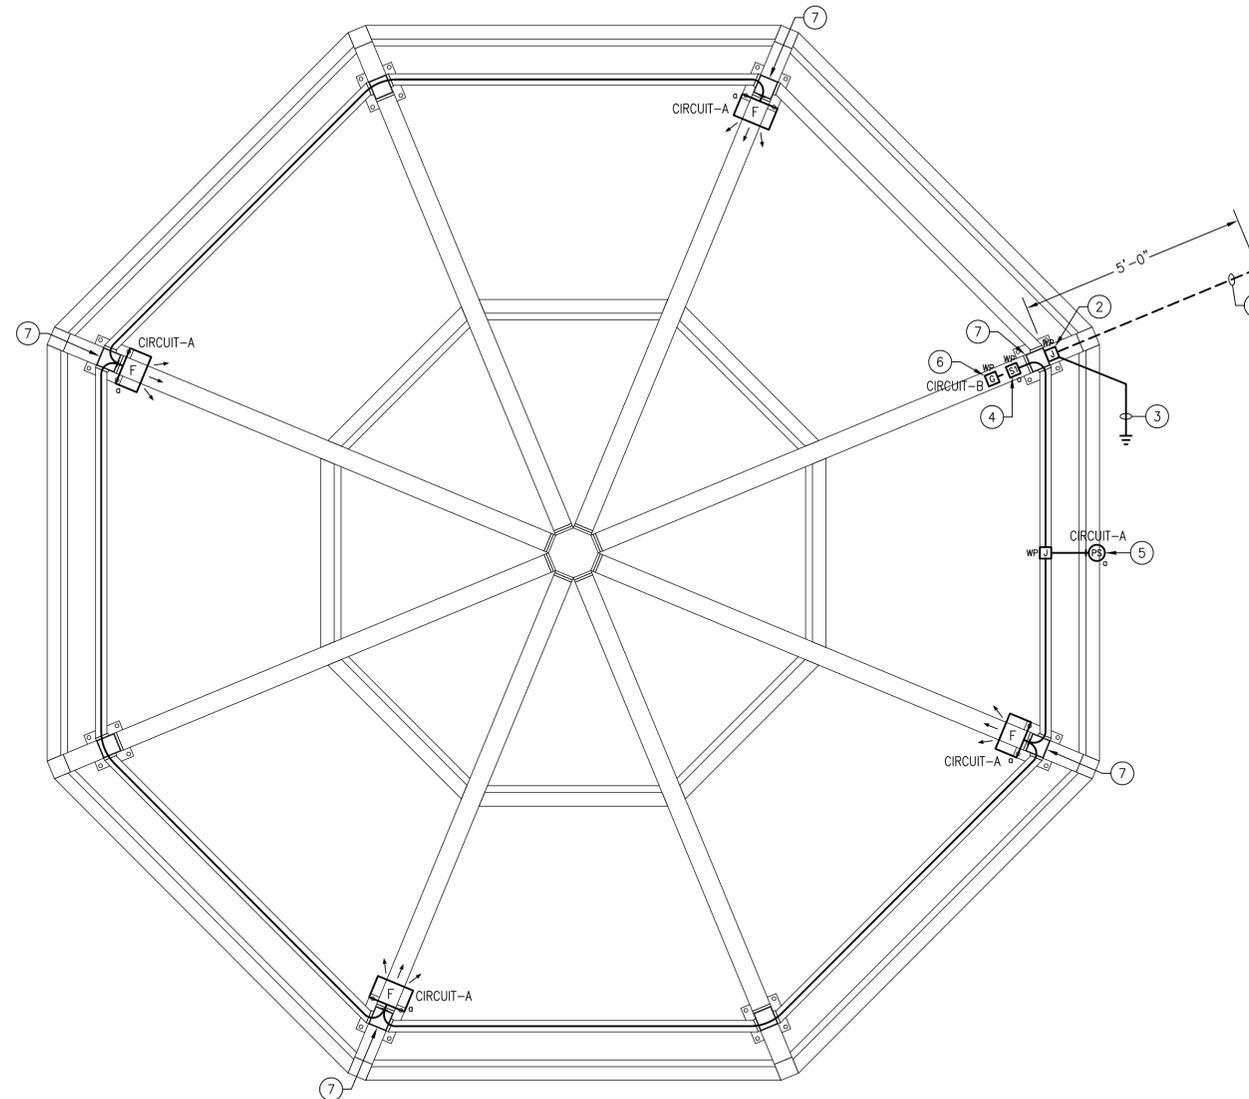

**25' SHADE PAVILION - ELECTRICAL PLAN**  
 SCALE: 1/2" = 1'-0"

ADDENDUMS / REVISIONS	
NEW SHEET: A.H.H. 05/17/13	

SCALE AS NOTED




**INDIAN RIVER INLET PARK ENHANCEMENTS**

CONTRACT	BRIDGE NO.	X
T200507303	DRAWN BY:	AHH
COUNTY	CHECKED BY:	JRF
SUSSEX		



**25' SHADE PAVILION BUILDING 7A ELECTRICAL PLAN**

SHEET NO.	CD254A
TOTAL SHTS.	
	CD282


A7-02A

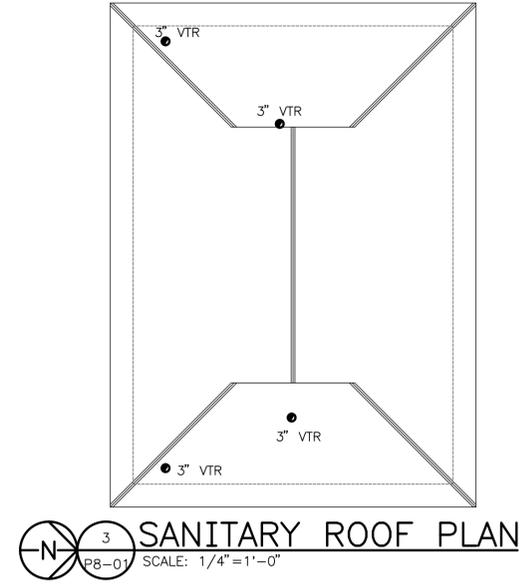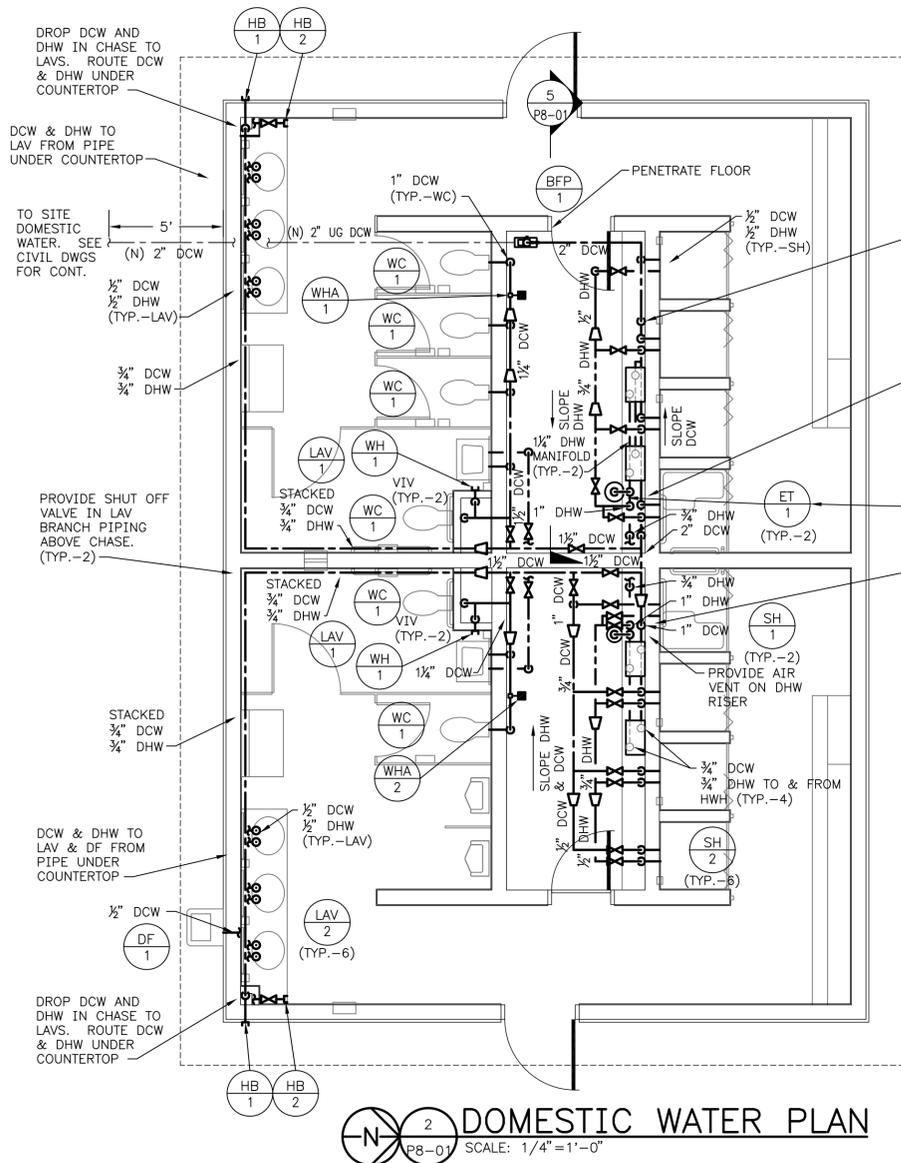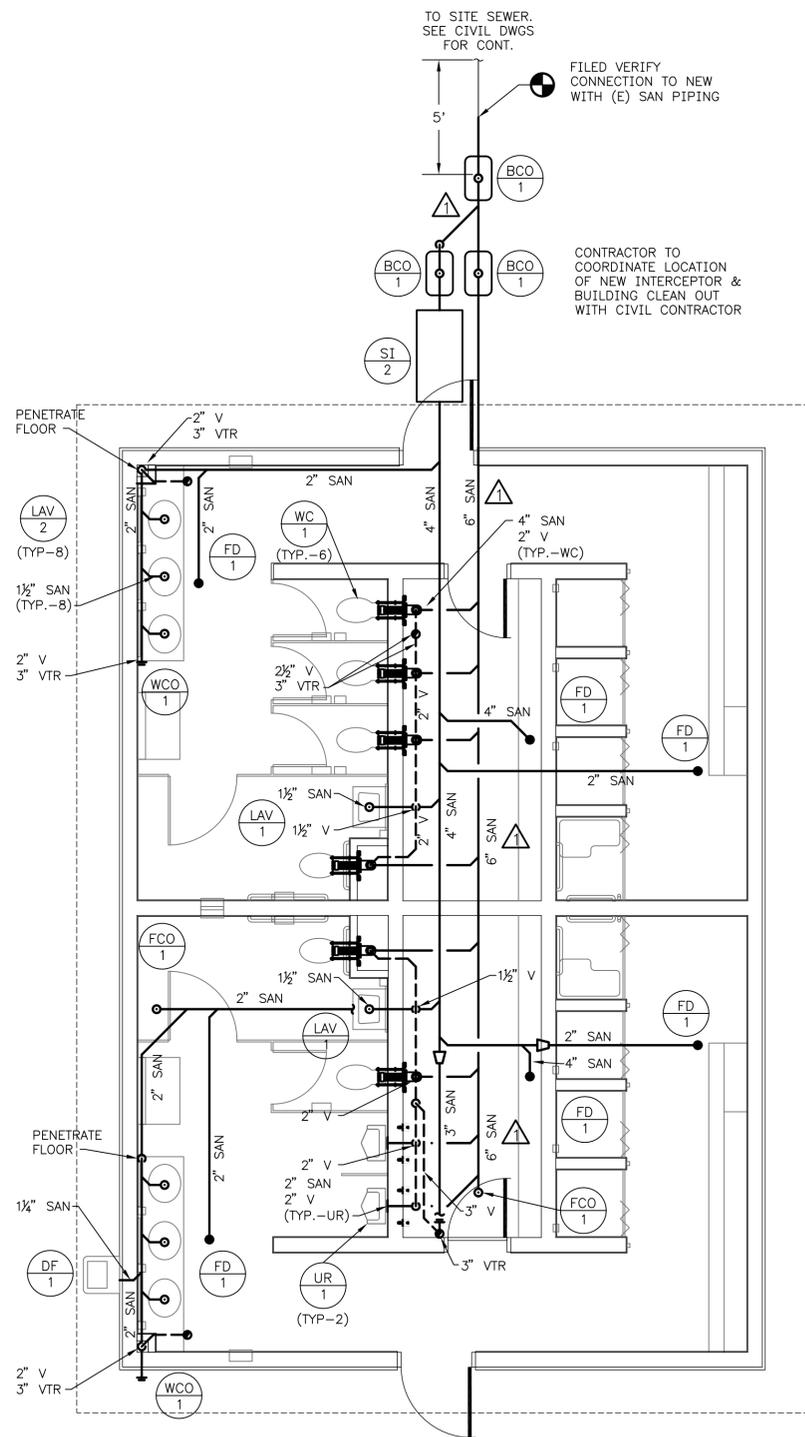


- NOTES:**
- REFER TO P0-01 FOR PLUMBING NOTES AND LEGEND
  - SLOPE ALL PIPING TOWARDS SYSTEM DRAIN.
  - CONTRACTOR TO PROVIDE SHUT OFF VALVE IN ALL FIXTURE BRANCHES. NOT SHOWN ON DRAWING FOR CLARITY.
  - CONTRACTOR TO MANIFOLD HWH'S TOGETHER FOR DCW AND DHW.
  - CONTRACTOR TO COORDINATE PROPANE TANK LOCATION WITH CIVIL CONTRACTOR.
  - SEE DETAIL 6/P0-04 FOR JANITORS ROOM DRY VENT DETAIL.
  - IN AREA'S WHERE WCO & WH-1 ARE TO BE STACKED, CONTRACTOR TO STACK PIPING WITH ADEQUATE CLEARANCE FOR COVER PLATES.
  - CONTRACTOR TO LOCATE EXISTING SANITARY PIPING FOR NEW PIPING TIE IN.

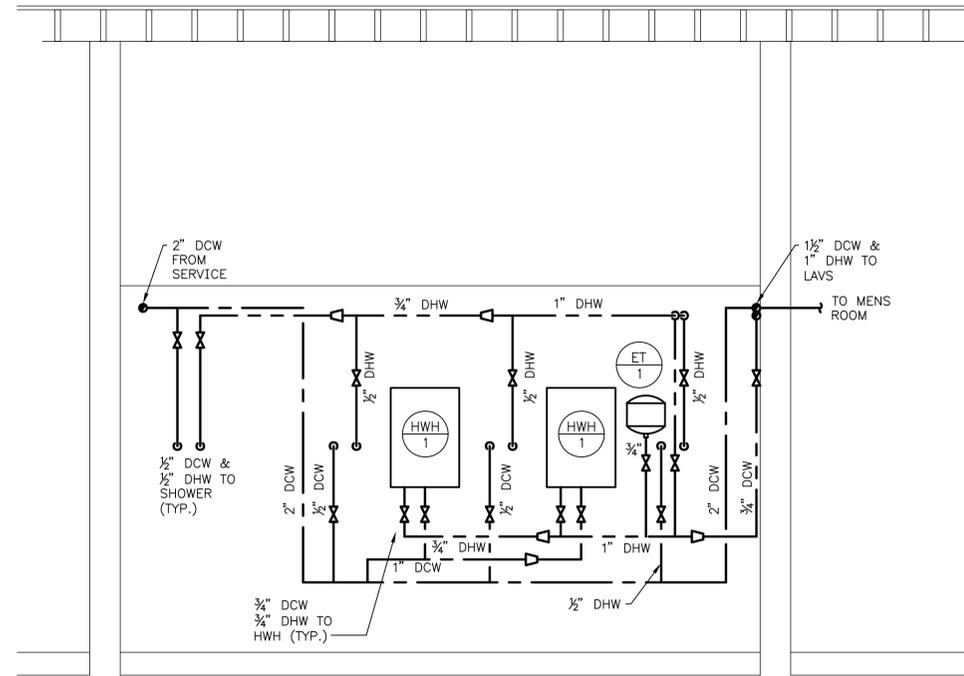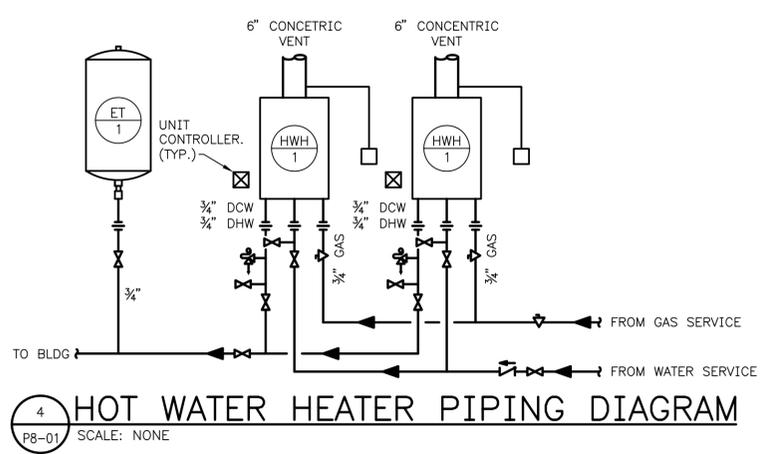




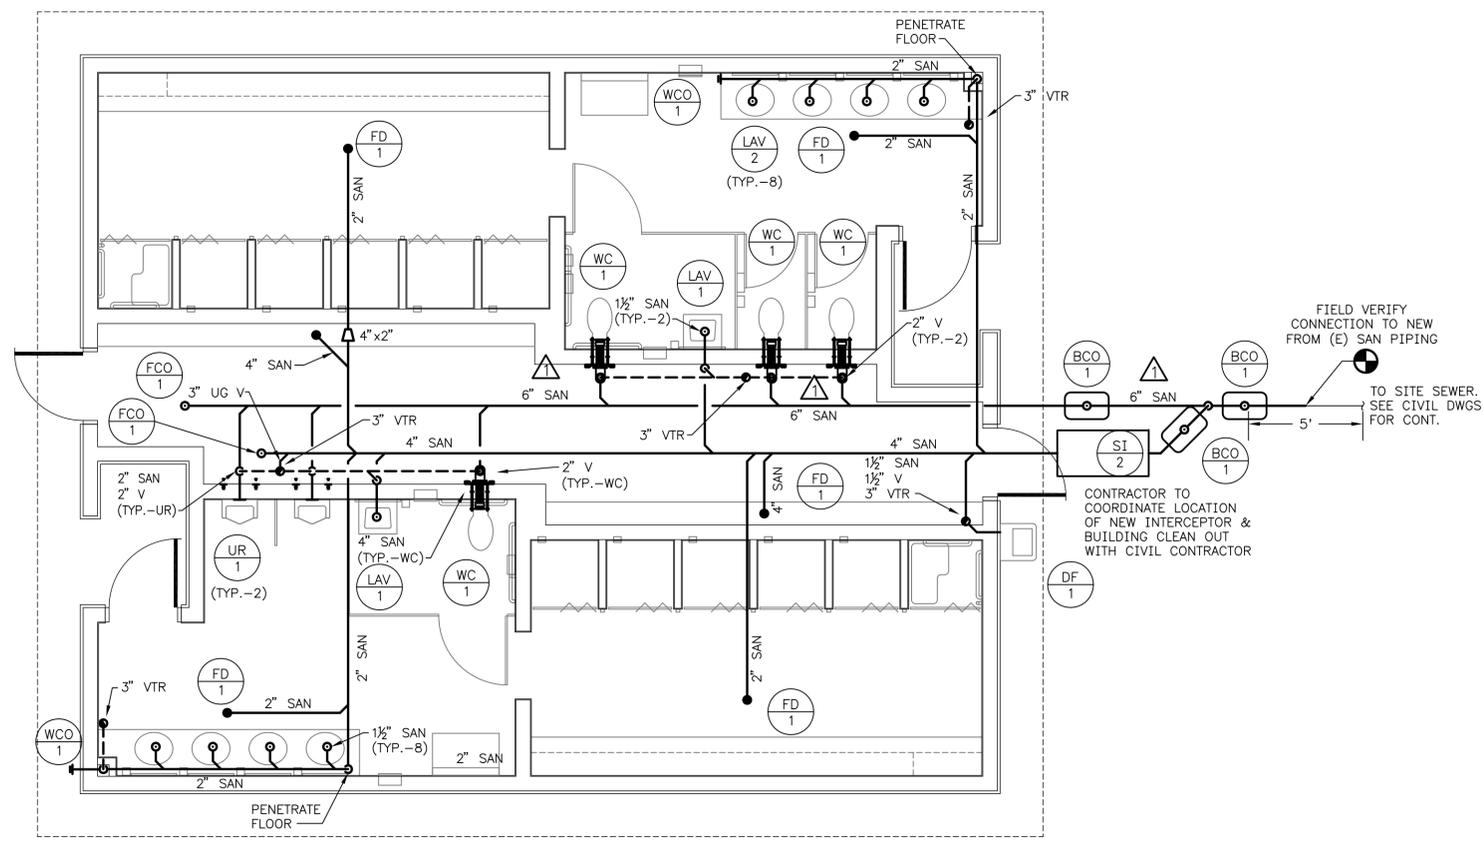


**1 SANITARY PLAN**  
 P9-01 SCALE: 1/4"=1'-0"

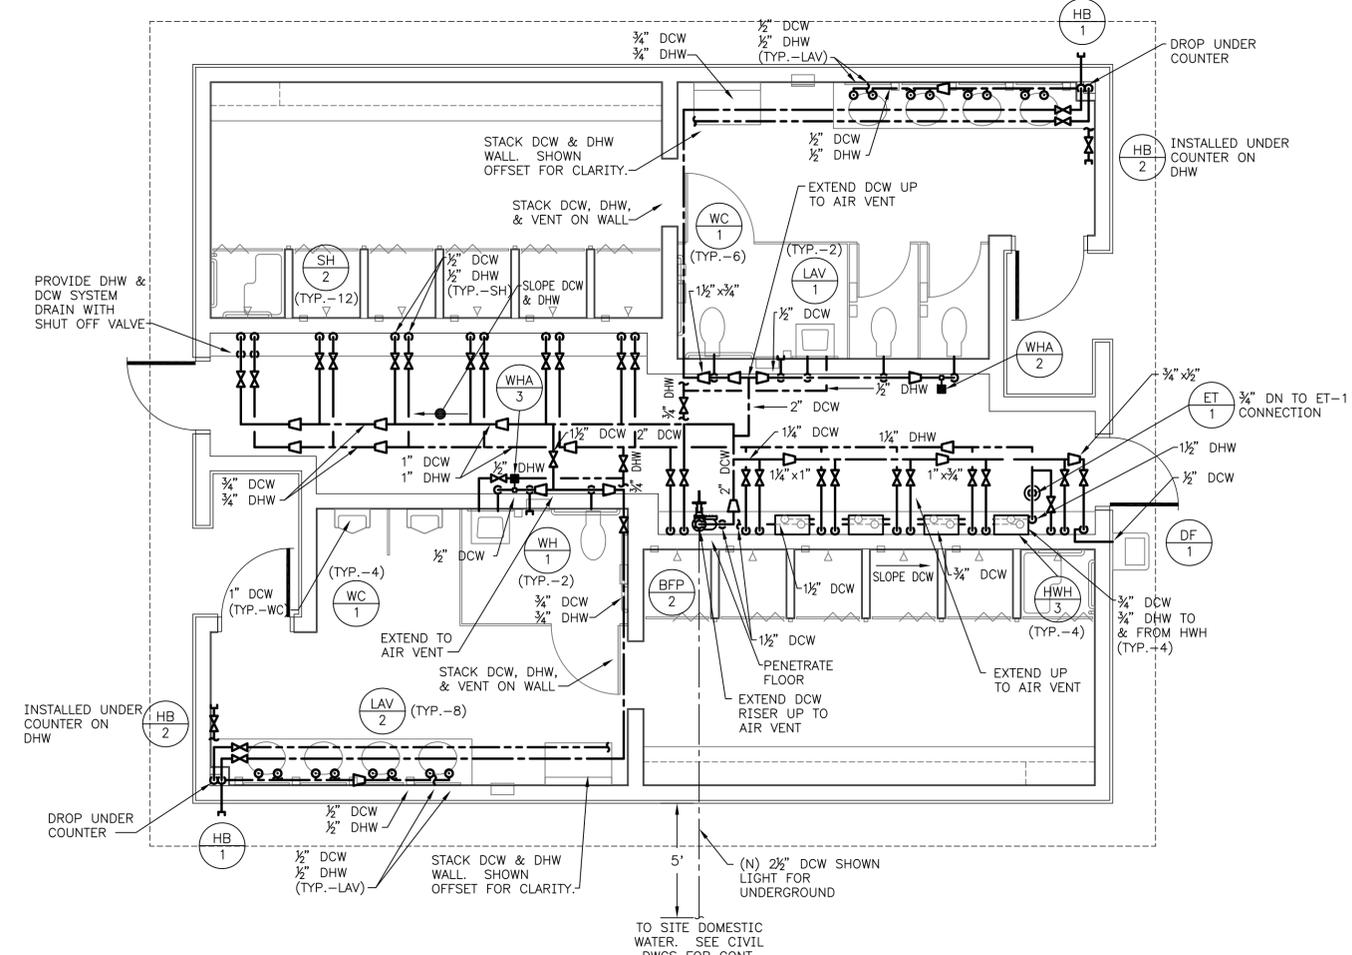

**2 DOMESTIC WATER PLAN**  
 P9-01 SCALE: 1/4"=1'-0"

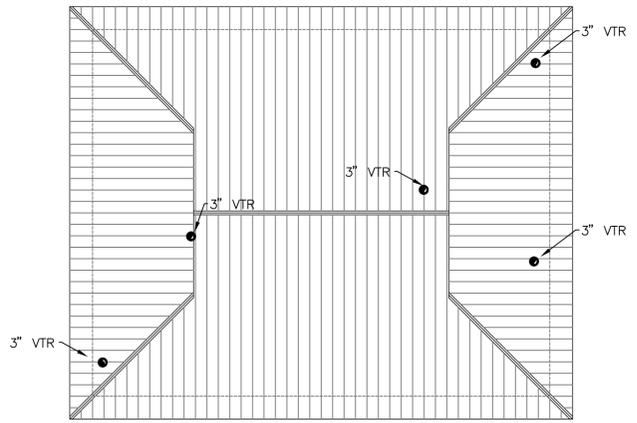

**3 SANITARY ROOF PLAN**  
 P9-01 SCALE: 1/8"=1'-0"

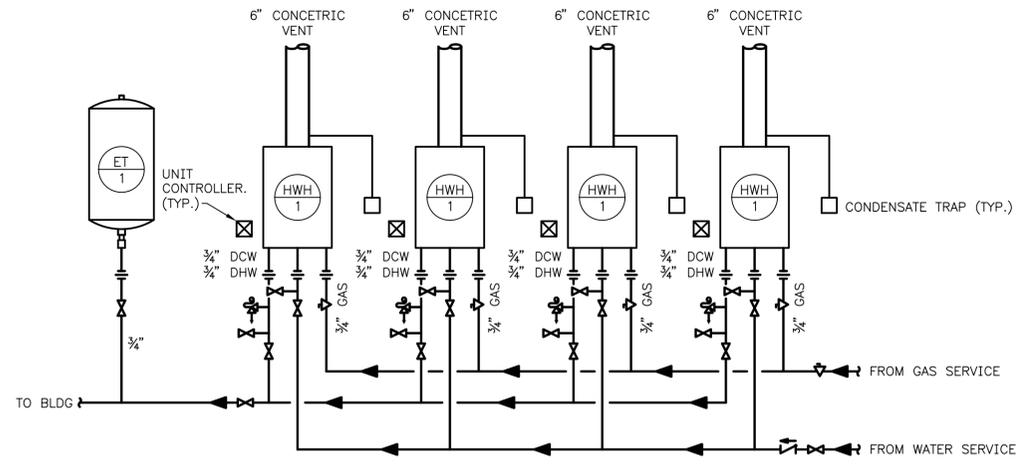

**4 HOT WATER HEATER PIPING DIAGRAM**  
 P9-01 SCALE: NONE

**NOTES:**

1. REFER TO P0-01 FOR PLUMBING NOTES AND LEGEND
2. SLOPE ALL PIPING TOWARDS SYSTEM DRAIN.
3. CONTRACTOR TO PROVIDE SHUT OFF VALVE IN ALL FIXTURE BRANCHES. NOT SHOWN ON DRAWING FOR CLARITY.
4. CONTRACTOR TO MANIFOLD HWH'S TOGETHER FOR DCW AND DHW.
5. CONTRACTOR TO COORDINATE PROPANE TANK LOCATION WITH CIVIL CONTRACTOR.
6. SEE DETAIL 6/P0-04 FOR JANITORS ROOM DRY VENT DETAIL.
7. IN AREA'S WHERE WCO & WH-1 ARE TO BE STACKED, CONTRACTOR TO STACK PIPING WITH ADEQUATE CLEARANCE FOR COVER PLATES.
8. CONTRACTOR TO LOCATE EXISTING SANITARY PIPING FOR NEW PIPING TIE IN.

ADDENDUMS / REVISIONS		
▲ INCREASED UNDERGROUND SANITARY MAIN TO 6"	MLF	5/17/13

SCALE AS NOTED



**INDIAN RIVER INLET PARK ENHANCEMENTS**

CONTRACT T200507303	BRIDGE NO. X
COUNTY SUSSEX	DRAWN BY: MLF
	CHECKED BY: JRF

**EXIST. SOUTHWEST BATH HOUSE BUILDING 9 PLUMBING PLANS & DIAGRAMS**

SHEET NO. CD278
TOTAL SHTS. CD282

P9-01

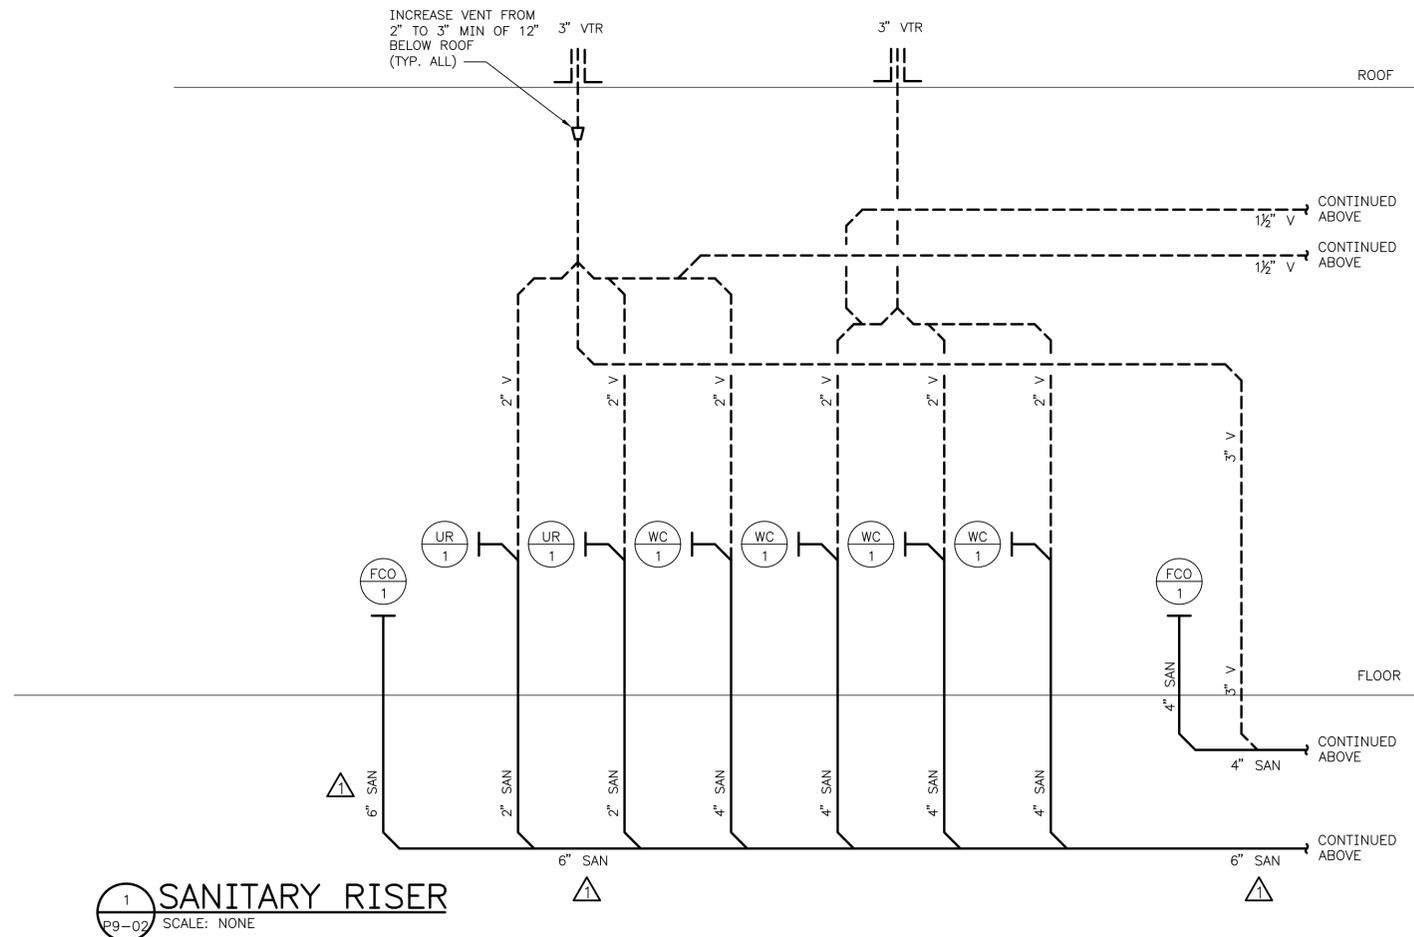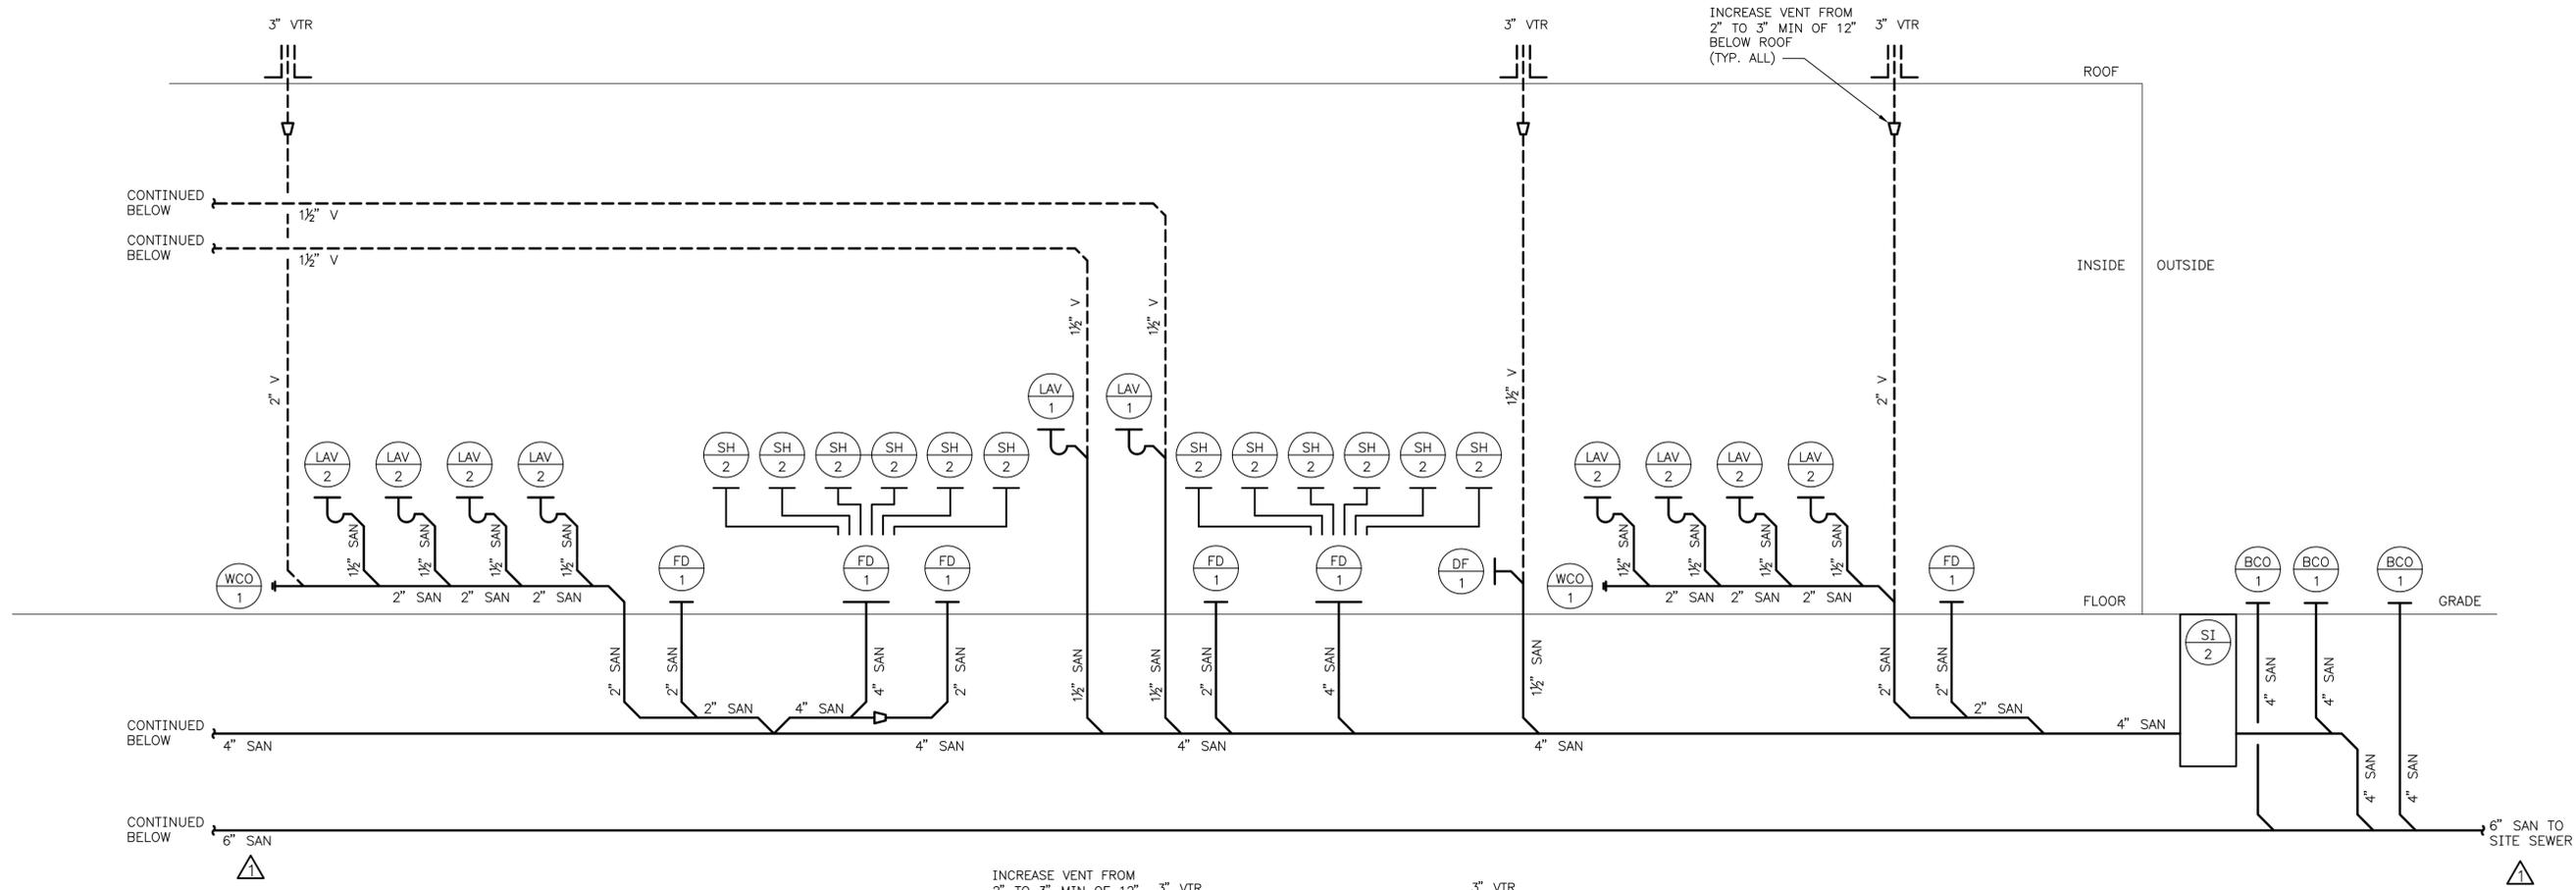

1 SANITARY RISER  
P9-02 SCALE: NONE

ADDENDUMS / REVISIONS		
△ INCREASED UNDERGROUND SANITARY MAIN TO 6"	MLF	5/17/13

SCALE AS NOTED

INDIAN RIVER INLET PARK ENHANCEMENTS

CONTRACT	BRIDGE NO.	X
T200507303	DRAWN BY:	MLF
COUNTY	CHECKED BY:	JRF
SUSSEX		

EXIST. SOUTHWEST BATH HOUSE BUILDING 9 RISER DIAGRAMS (SHEET 1 OF 2)	SHEET NO.
	CD279
	TOTAL SHTS.
	CD282