



CONTRACT
T200507303
COUNTY
SUSSEX

Х MLF JRF CHECKED BY:

**RV SHOWER FACILITY** BUILDING 4 PLUMBING PLANS (SHEET 2 OF 2) P4-02


SHEET NO. CD236 TOTAL SHTS.

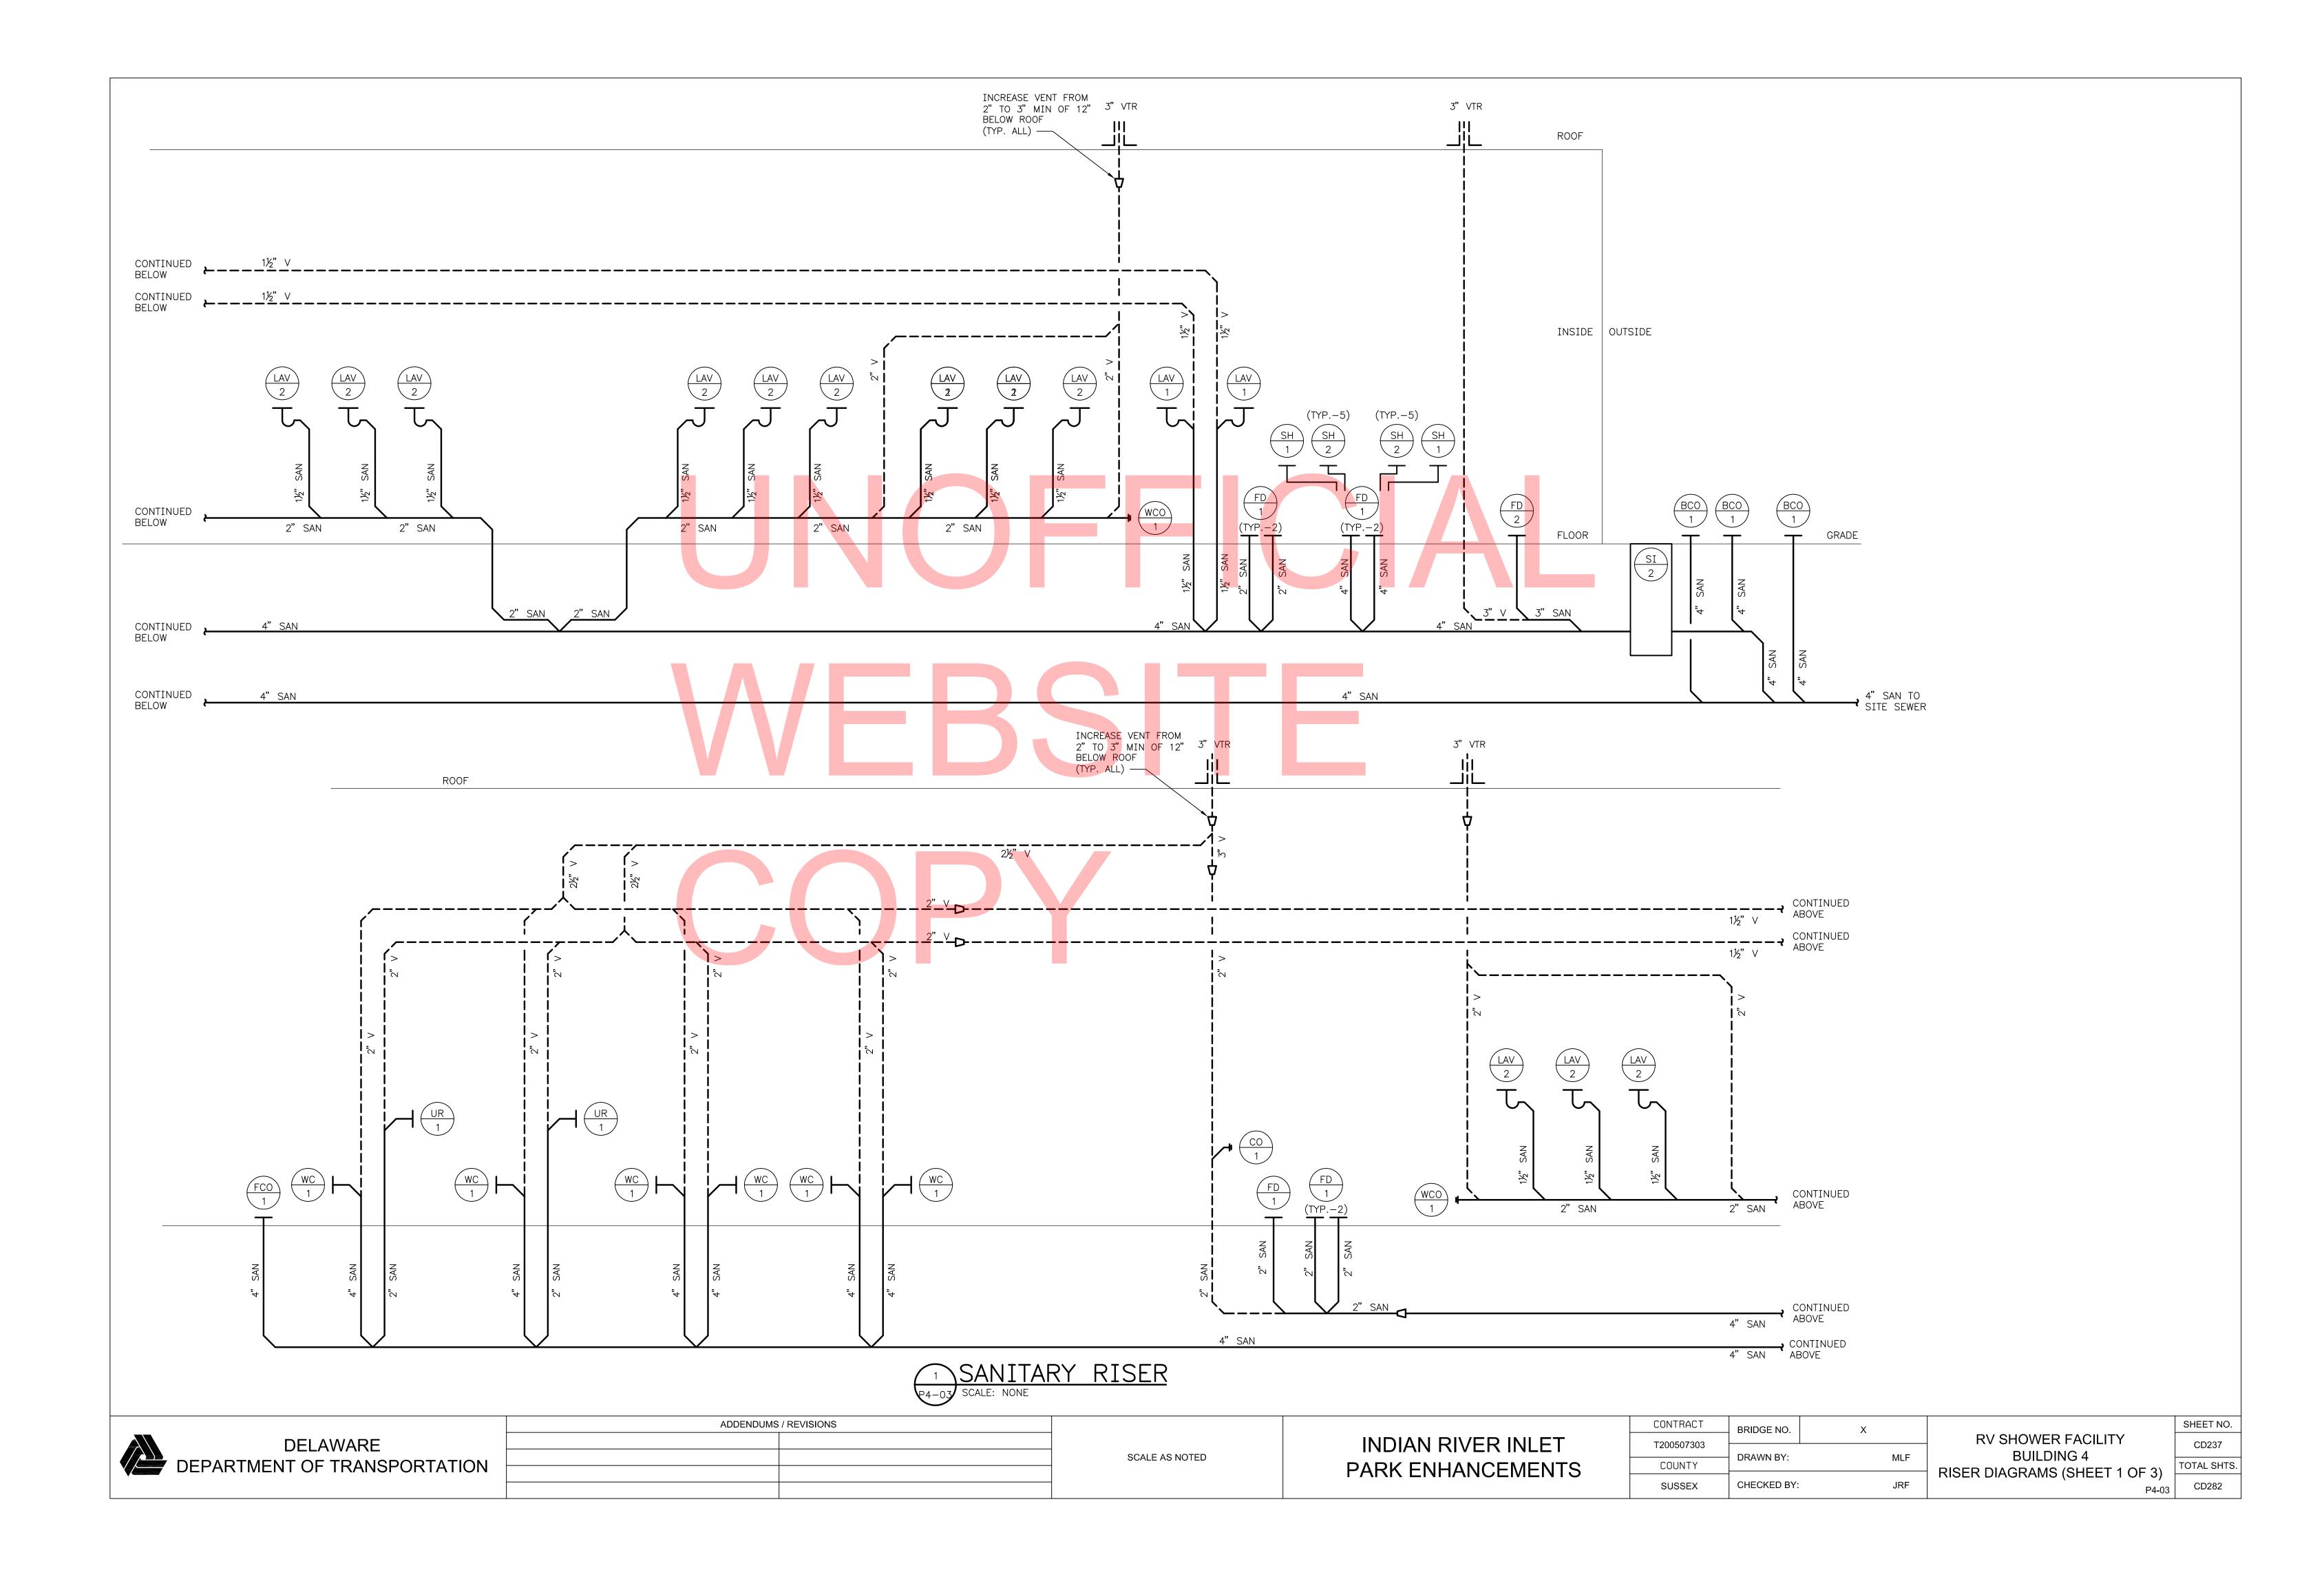

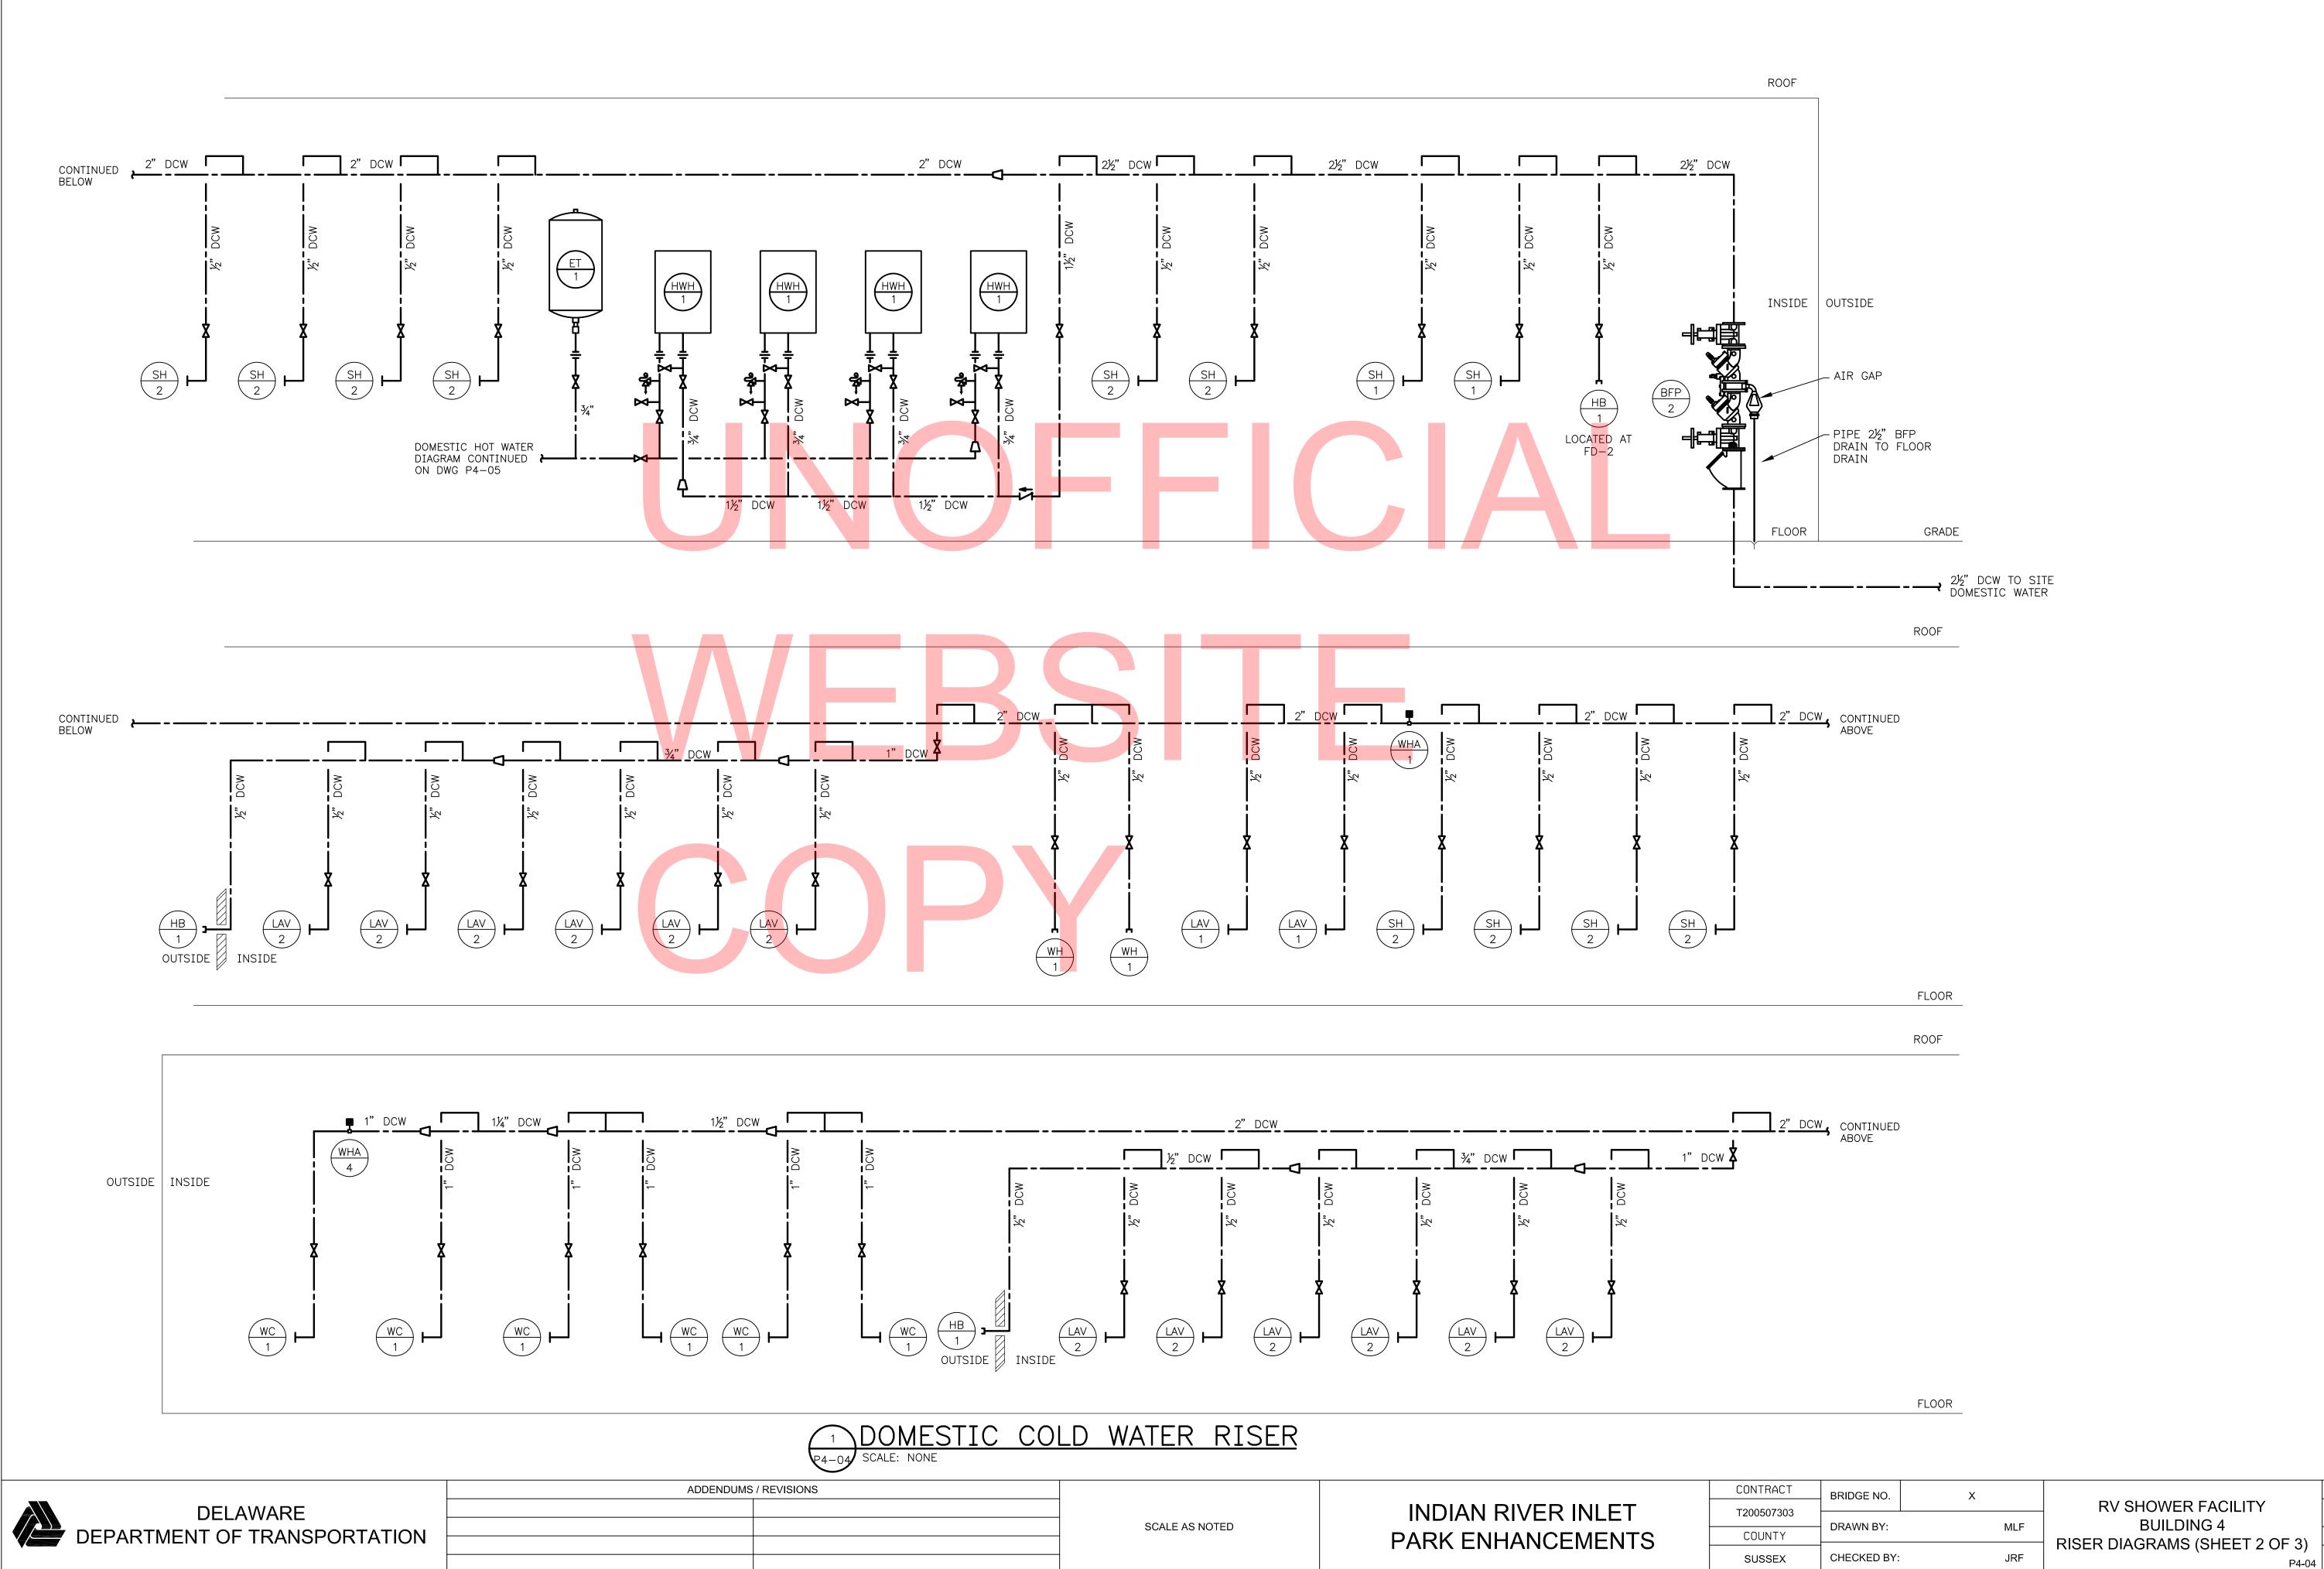

CONTRACT	BRIDO
T200507303	
COUNTY	DRAV
SUSSEX	CHEC


BRIDGE NO.	х
DRAWN BY:	MLF
CHECKED BY:	JRF

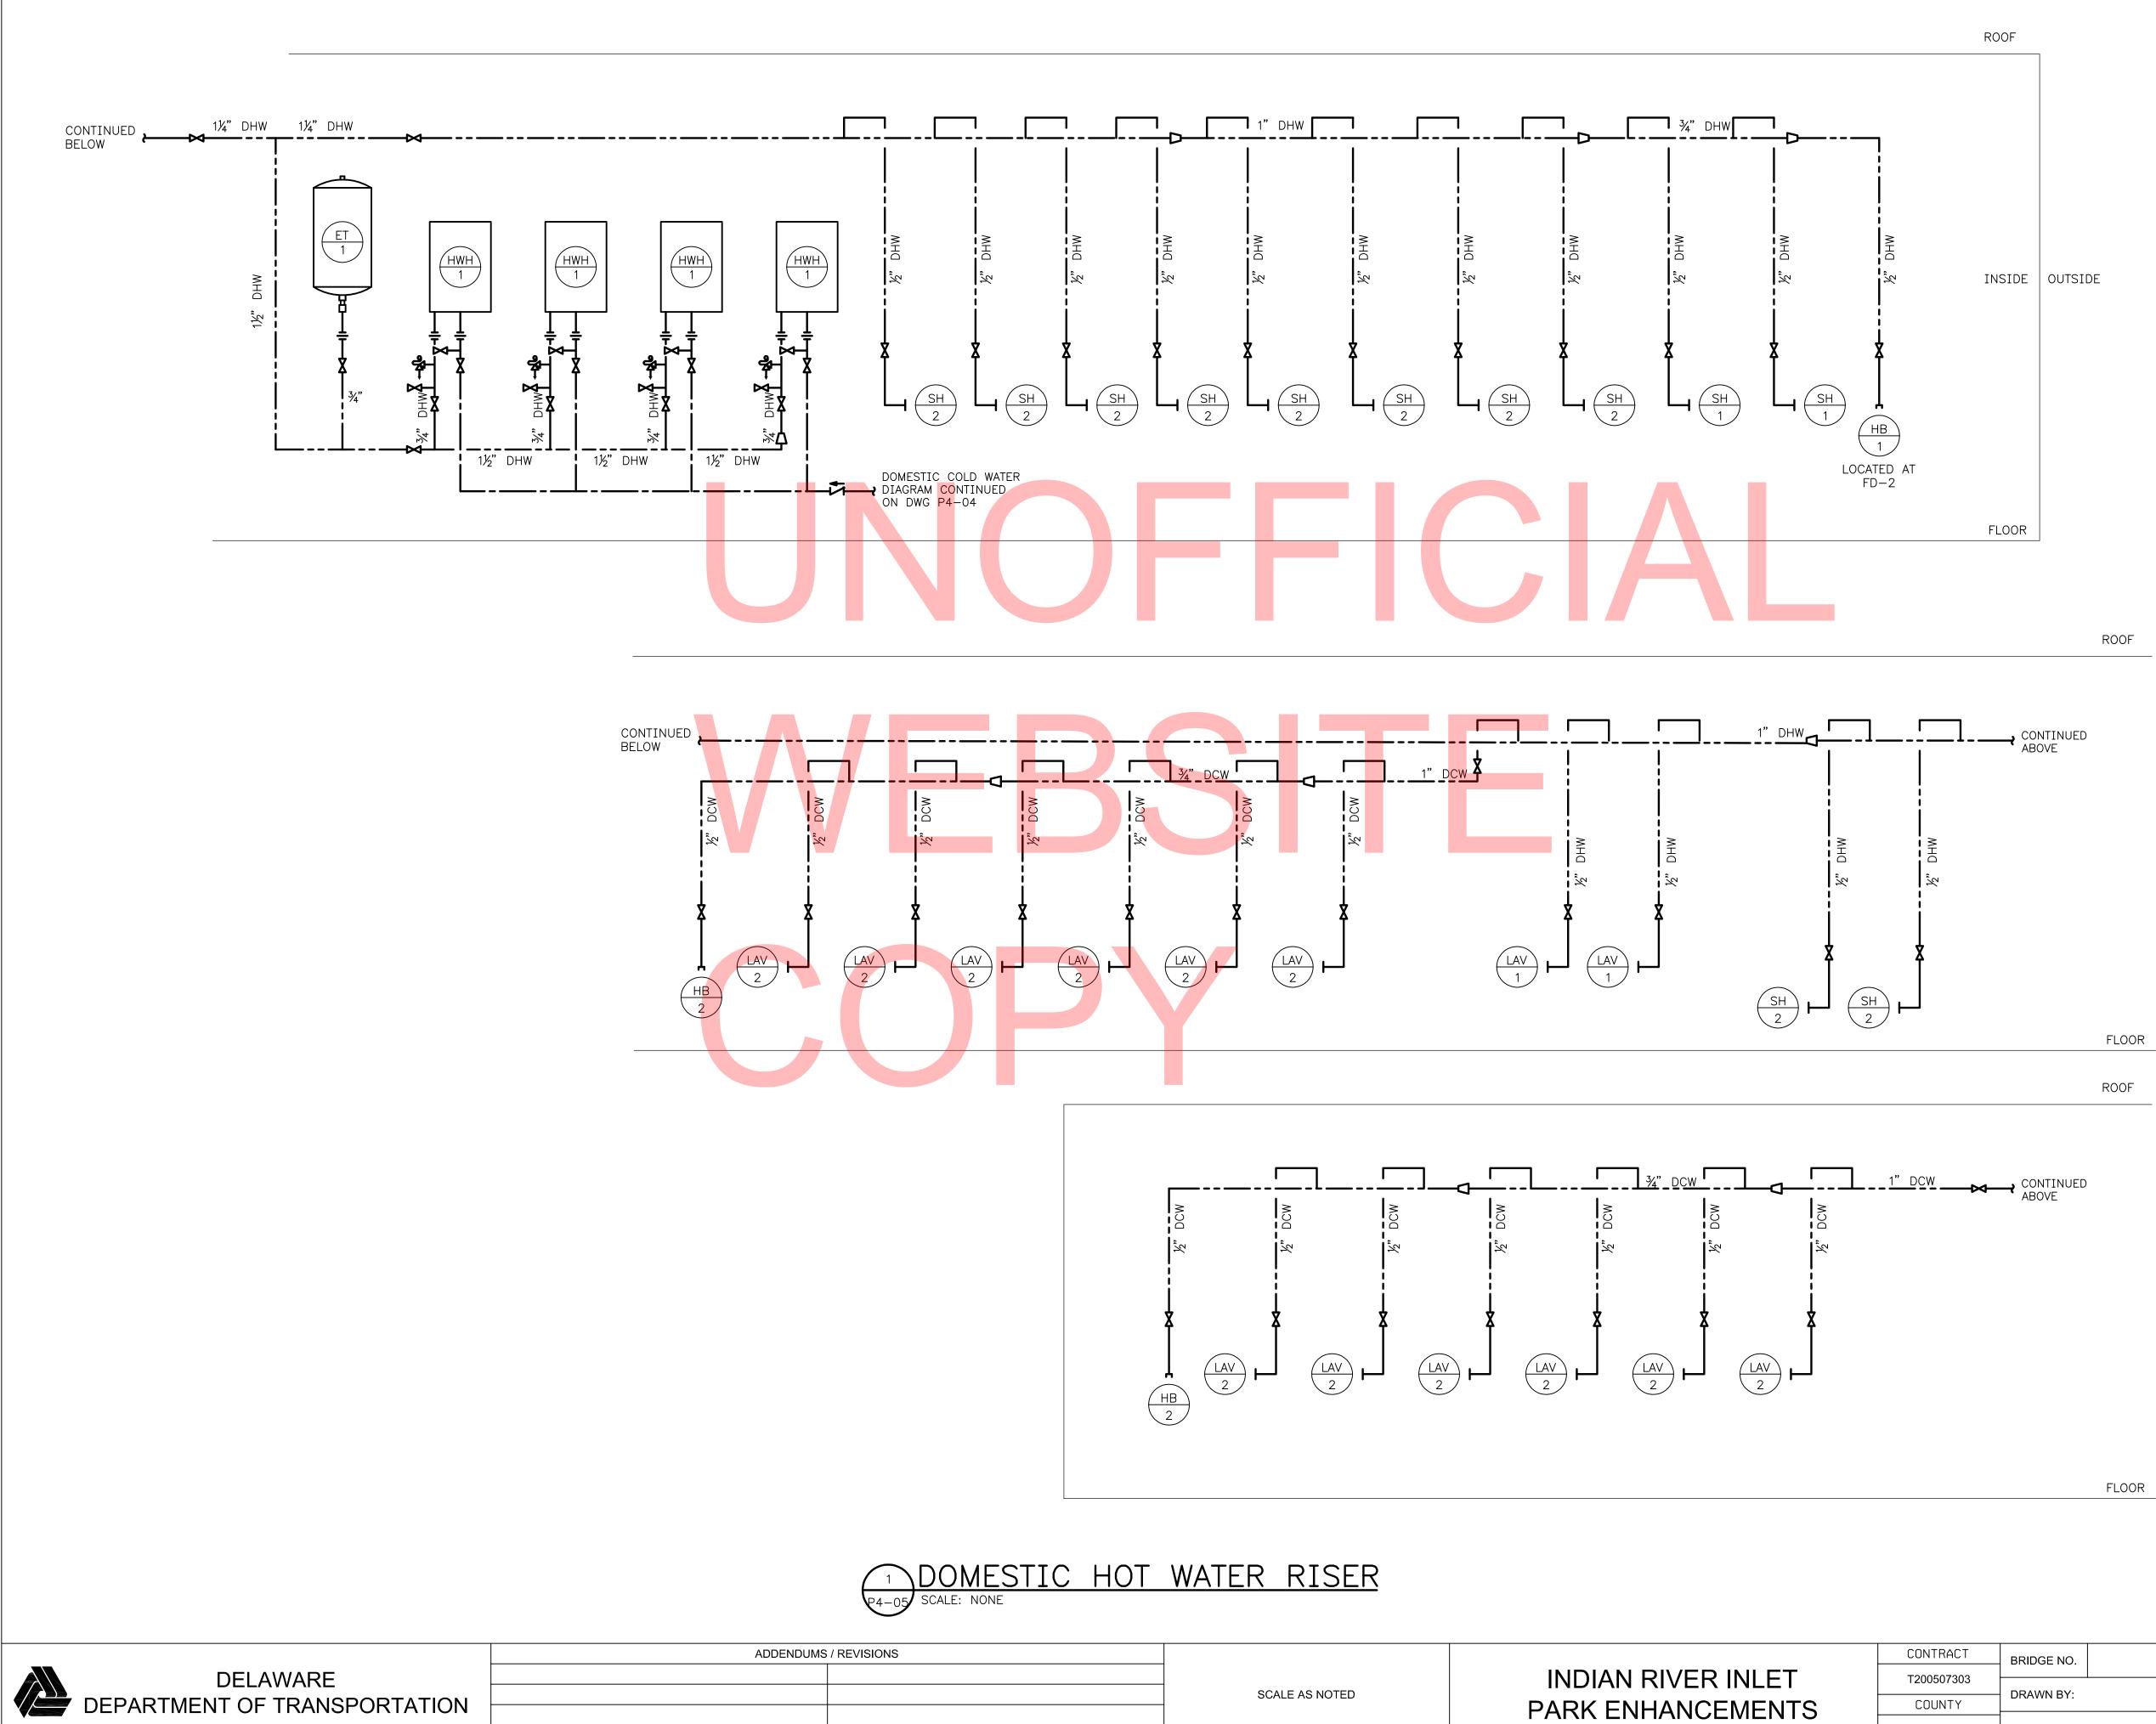


PARK ENHANCEMENTS


SUSSEX

Х MLF JRF CHECKED BY:

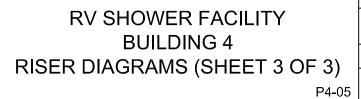

SHEET NO. CD239 TOTAL SHTS.

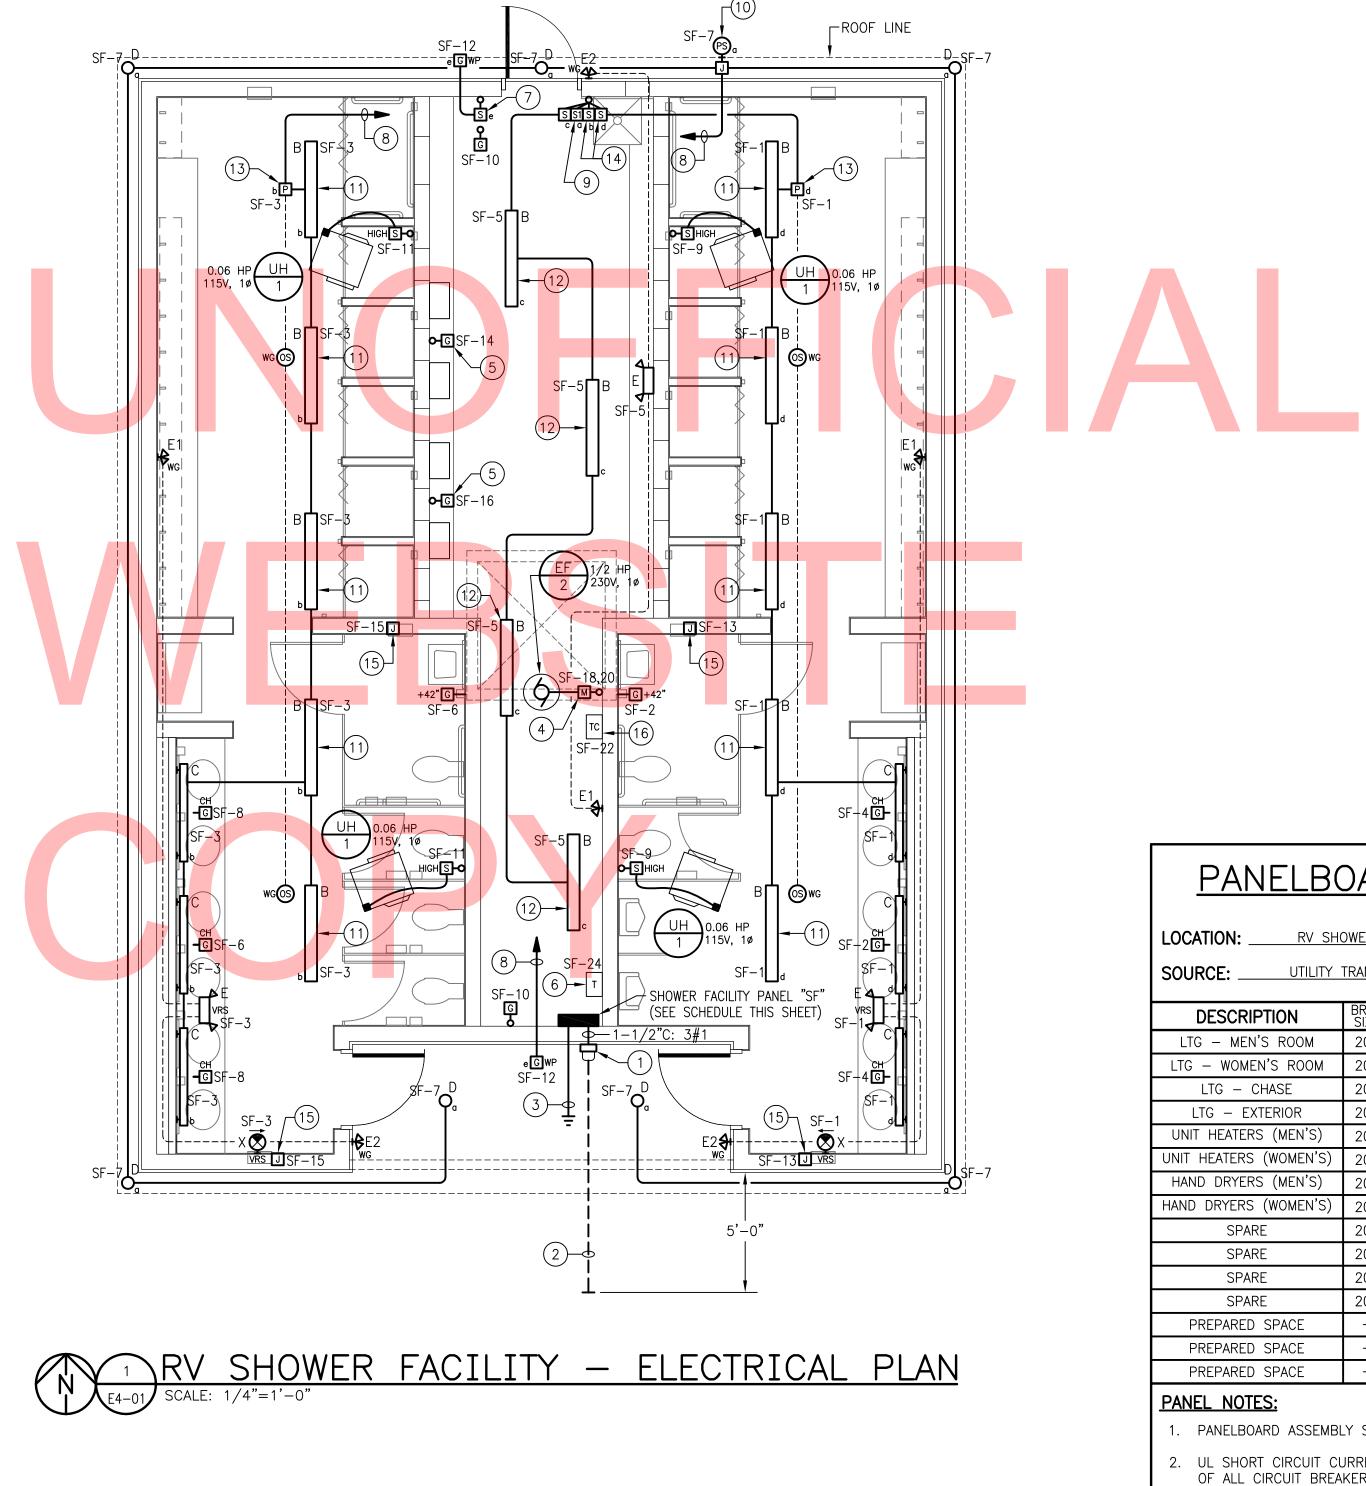

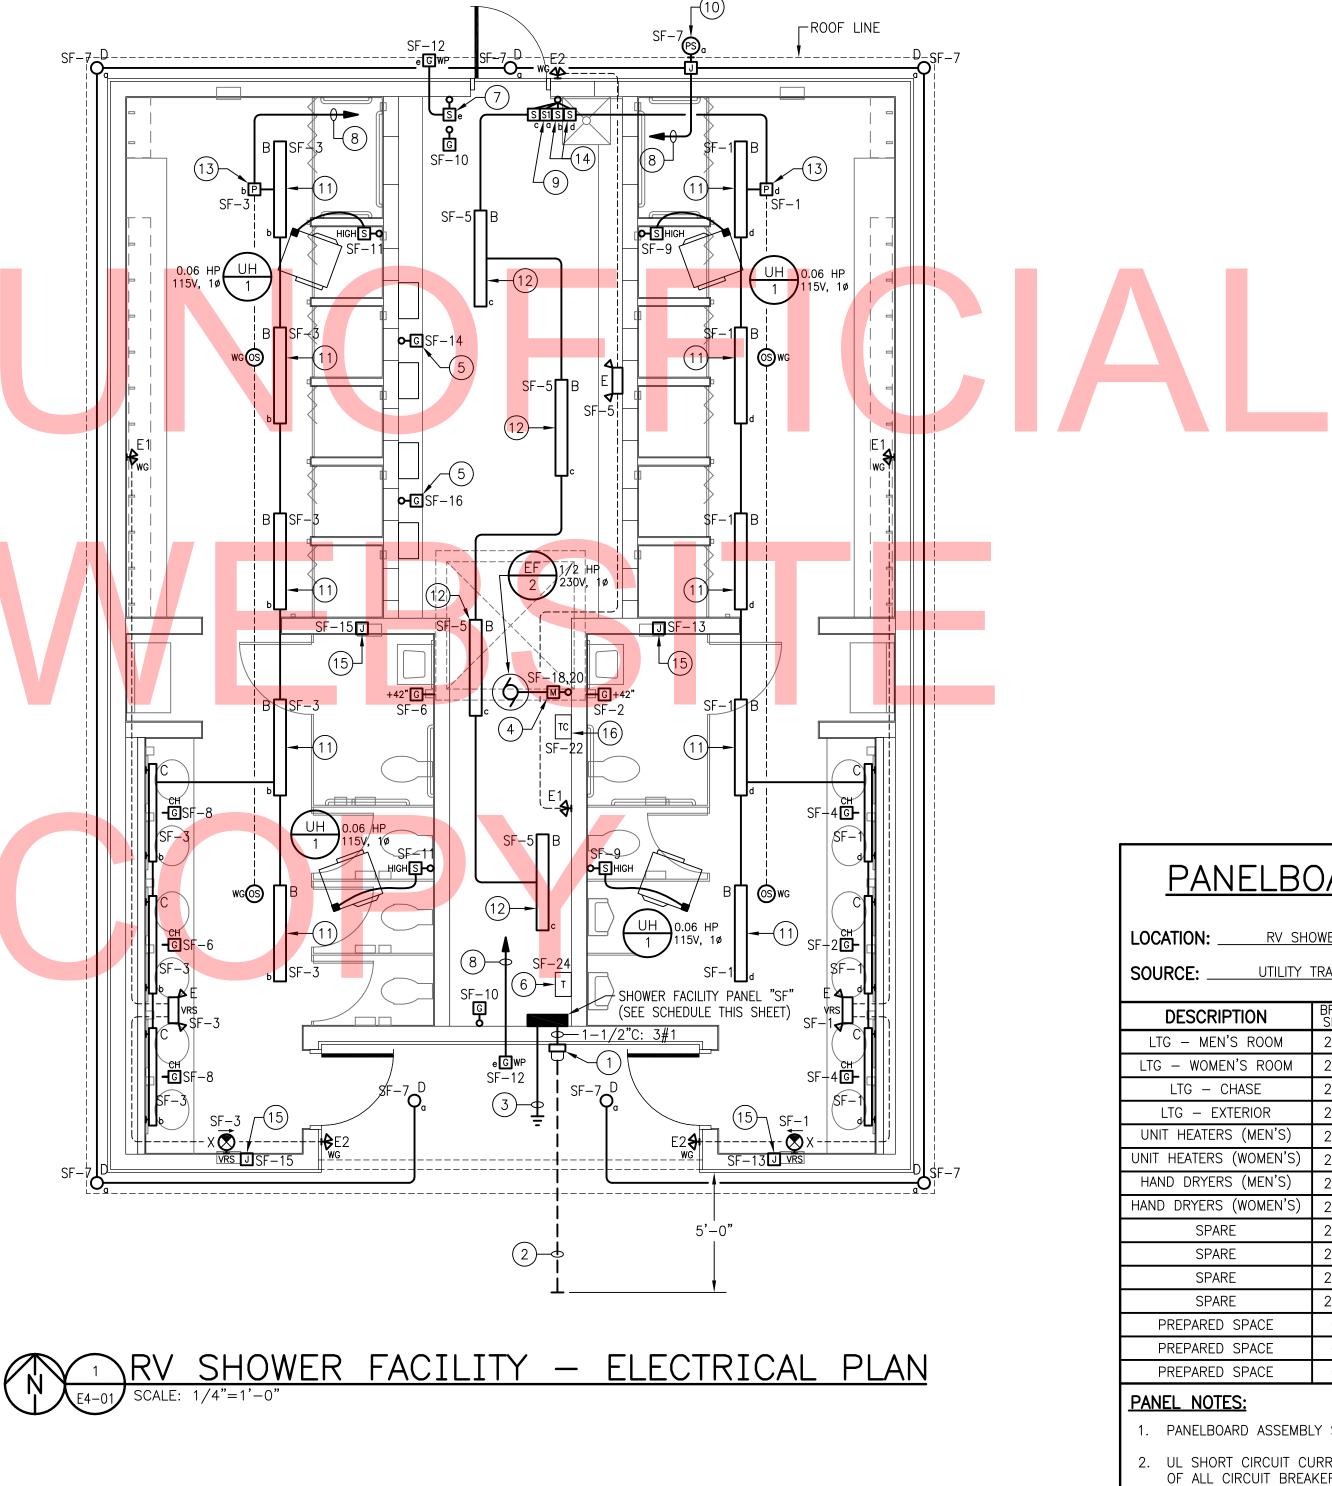



ADDENDUMS / REVISIONS

SCALE AS NOTED

INDIAN RIVER INLET PARK ENHANCEMENTS

### SHEET NOTES:

- (1) 125A, 1Ø, 3W METER SOCKET PER UTILITY REQUIREMENTS (METER PROVIDED BY ELECTRIC UTILITY).
- 2 EMPTY 3" SCHEDULE 80 PVC UNDERGROUND CONDUIT STUB-OUT WITH PULL STRING FOR ELECTRICAL SERVICE TO BUILDING (CONDUCTORS PROVIDED BY OTHERS). TOP OF CONDUIT SHALL BE BURIED MINIMUM 36" BELOW FINISHED GRADE. PROVIDE CONTINUOUS DETECTABLE RED WARNING TAPE IN BACKFILL 12" BELOW FINISHED GRADE ("CAUTION - BURIED ELECTRIC LINE BELOW").
- (3) SEE DIAGRAM 3/E0-02 FOR PANELBOARD GROUNDING AND BONDING DETAILS.
- (4) SEE EXHAUST FAN WIRING DIAGRAM 2/E0-02.
- 5 RECEPTACLE OUTLET FOR GAS-FIRED INSTANTANEOUS WATER HEATERS. EXACT MOUNTING LOCATION TO BE FIELD-COORDINATED WITH MECHANICAL PIPING.
- 6 CONTROL POWER TRANSFORMER (TRANSFORMER & LOW VOLTAGE CONTROL WIRING PROVIDED BY CONTROLS CONTRACTOR). PRIMARY CIRCUIT TO BE PROVIDED BY ELECTRICAL CONTRACTOR. NOTE: TRANSFORMER TO BE PROVIDED WITH FACTORY-INSTALLED PRIMARY AND SECONDARY FUSE BLOCKS WITH FUSES AS REQUIRED.
- (7) MASTER SWITCH CONTROL FOR EXTERIOR RECEPTACLE OUTLETS (PROVIDE LABEL).
- (8) TO TOGGLE SWITCH BY CHASE ENTRY DOOR.
- 9 EXTERIOR LIGHTING MAINTENANCE SWITCH (PROVIDE LABEL). SEE EXTERIOR LIGHTING CONTROL WIRING DIAGRAM 1/E0-02.
- 0 OUTDOOR PHOTOSENSOR FOR CONTROL OF EXTERIOR LIGHTING FIXTURES (SEE EXTERIOR LIGHTING CONTROL WIRING DIAGRAM 1/E0-02 FOR DETAILS). MOUNT TO ROOF LINE FASCIA ON NORTH SIDE OF BUILDING.
- (11) SECURE LIGHTING FIXTURE TO UNDERSIDE OF ROOF JOISTS.
- (12) CHAIN-SUSPEND LIGHTING FIXTURE 8'-0" A.F.F. EXACT LOCATION TO BE FIELD-COORDINATED WITH MECHANICAL PIPING & DUCTWORK.
- (13) POWER RELAY PACK WITH OCCUPANCY SENSORS FOR CONTROL OF BATHROOM LIGHTING FIXTURES. CONNECT PER MANUFACTURER'S WIRING INSTRUCTIONS.
- (14) MASTER-OFF SWITCHES FOR MEN'S & WOMEN'S ROOM LIGHTING FIXTURES (PROVIDE LABELS). CONNECT PER OCCUPANCY SENSOR MANUFACTURER'S WIRING INSTRUCTIONS.
- (15) JUNCTION BOX FOR HAND DRYER (510W, 120V, 10). FIELD-COORDINATE EXACT LOCATION AND PROVIDE ALL CIRCUITING TO HAND DRYER AS REQUIRED PER DRYER MANUFACTURER'S INSTALLATION INSTRUCTIONS.
- (16) TIME CLOCK CONTROL FOR EXHAUST FAN EF/2 (TIME CLOCK & CONTROL WIRING TO EXHAUST FAN PROVIDED BY CONTROLS CONTRACTOR). POWER SUPPLY CIRCUIT TO BE PROVIDED BY ELECTRICAL CONTRACTOR.

AF	R	)	"(	SF	<b>;</b> ;	S(	CHEDULE
ER FACILITY     TYPE:     240/120V, 1ø, 3W       ANSFORMER     MAIN BREAKER:     100A							
RKR SIZE	CIR NO		A <sup>Q</sup> E	3 <sub>6</sub>	CIR NO	BRKR SIZE	DESCRIPTION
20A	1	$\left  \bigcirc \right $	┢──	$\mathbb{N}$	2	20A	REC – MEN'S ROOM
20A	3	$\bigcap$	┝─┥		4	20A	REC – MEN'S ROOM
20A	5	$\left  \bigcap \right $	┢──	$\square$	6	20A	REC – WOMEN'S ROOM
20A	7	$\bigcap$	┝		8	20A	REC – WOMEN'S ROOM
20A	9	$\left  \bigcap \right $	┢──	$\sum$	10	20A	REC – CHASE
20A	11	$\left  \bigcap \right $	┝		12	20A	REC – EXTERIOR
20A	13	$\bigcap$	┢──	$\sum$	14	20A	REC – INST. WATER HTRS.
20A	15	$\left  \bigcap \right $	┝		16	20A	REC – INST. WATER HTRS.
20A	17	$\left  \bigcirc \right $	┢──	(1)	18	15A	EXHAUST FAN
20A	19	$\bigcap$	┝─┥		20	IJA	
20A	21	$\left  \begin{array}{c} \\ \end{array} \right $	┥—	$\mathcal{L}$	22	15A	EXH. FAN TIME CLOCK CONTROL
20A	23	$\cap$	┝─┥		24	20A	CONTROL POWER XFMR
-	25		┣	╞	26	—	PREPARED SPACE
-	27	-	┝┥		28	_	PREPARED SPACE
_	29	•	<u> </u>	-	30	_	PREPARED SPACE

PANELBOARD ASSEMBLY SHALL BE SUITABLE FOR USE AS SERVICE EQUIPMENT. UL SHORT CIRCUIT CURRENT RATING OF PANELBOARD AND UL INTERRUPT RATINGS OF ALL CIRCUIT BREAKERS WITHIN PANELBOARD SHALL BE COORDINATED WITH AVAILABLE FAULT CURRENT AT PANELBOARD PRIOR TO PURCHASING EQUIPMENT. COORDINATE WITH ELECTRIC UTILITY AND SITE ENGINEER.


3. ALL CIRCUIT BREAKERS WITHIN PANELBOARD SHALL BE HACR RATED.

CONTRACT	BRIDGE NO.	х
T200507303		<u>,                                    </u>
1200507303	DRAWN BY:	АНН
COUNTY		
SUSSEX	CHECKED BY:	JRF

**RV SHOWER FACILITY BUILDING 4** ELECTRICAL PLAN

SHEET NO. CD240 TOTAL SHTS. CD282

E4-01

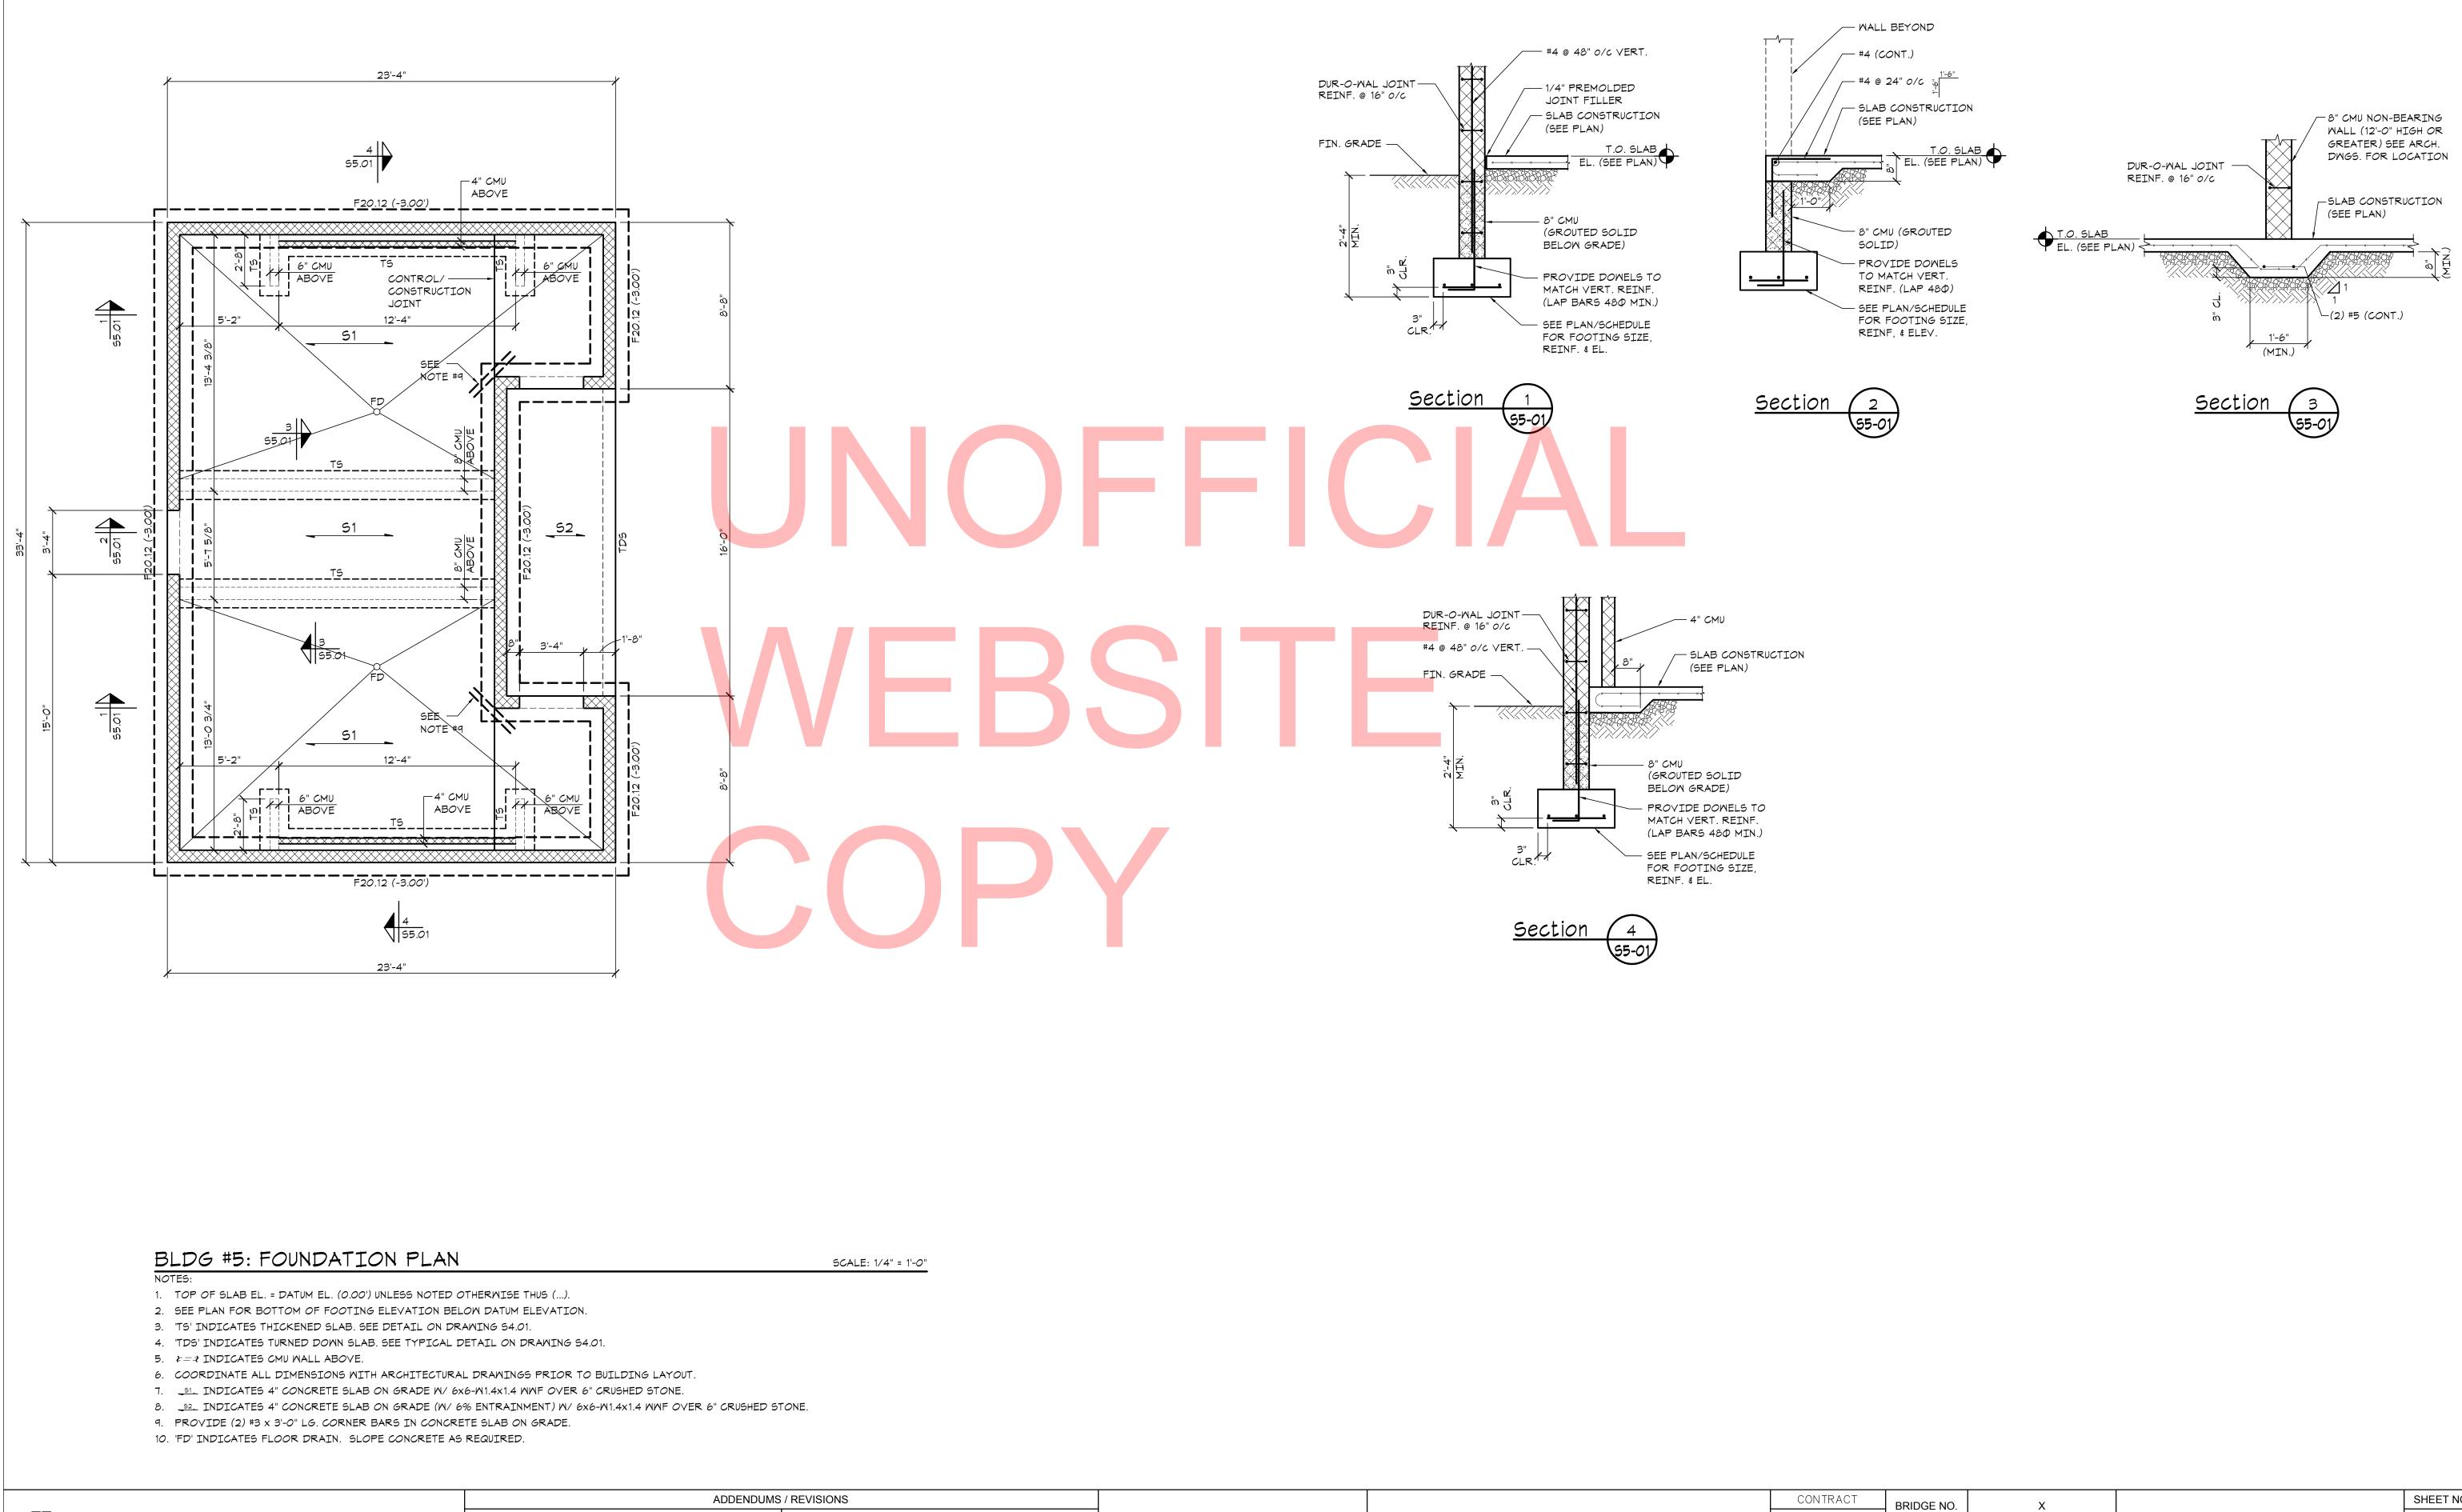


SCALE	AS	NOTED	

### INDIAN RIVER INLET PARK ENHANCEMENTS

C( T2 (

ONTRACT	BRIDGE NO.	х			SHEET NO.
200507303			BATH HOUSE - BUILDING 5		CD241
COUNTY	DRAWN BY:	JNR	PLANS / DETAILS		TOTAL SHTS.
SUSSEX	CHECKED BY:	JRB		S5-01	282

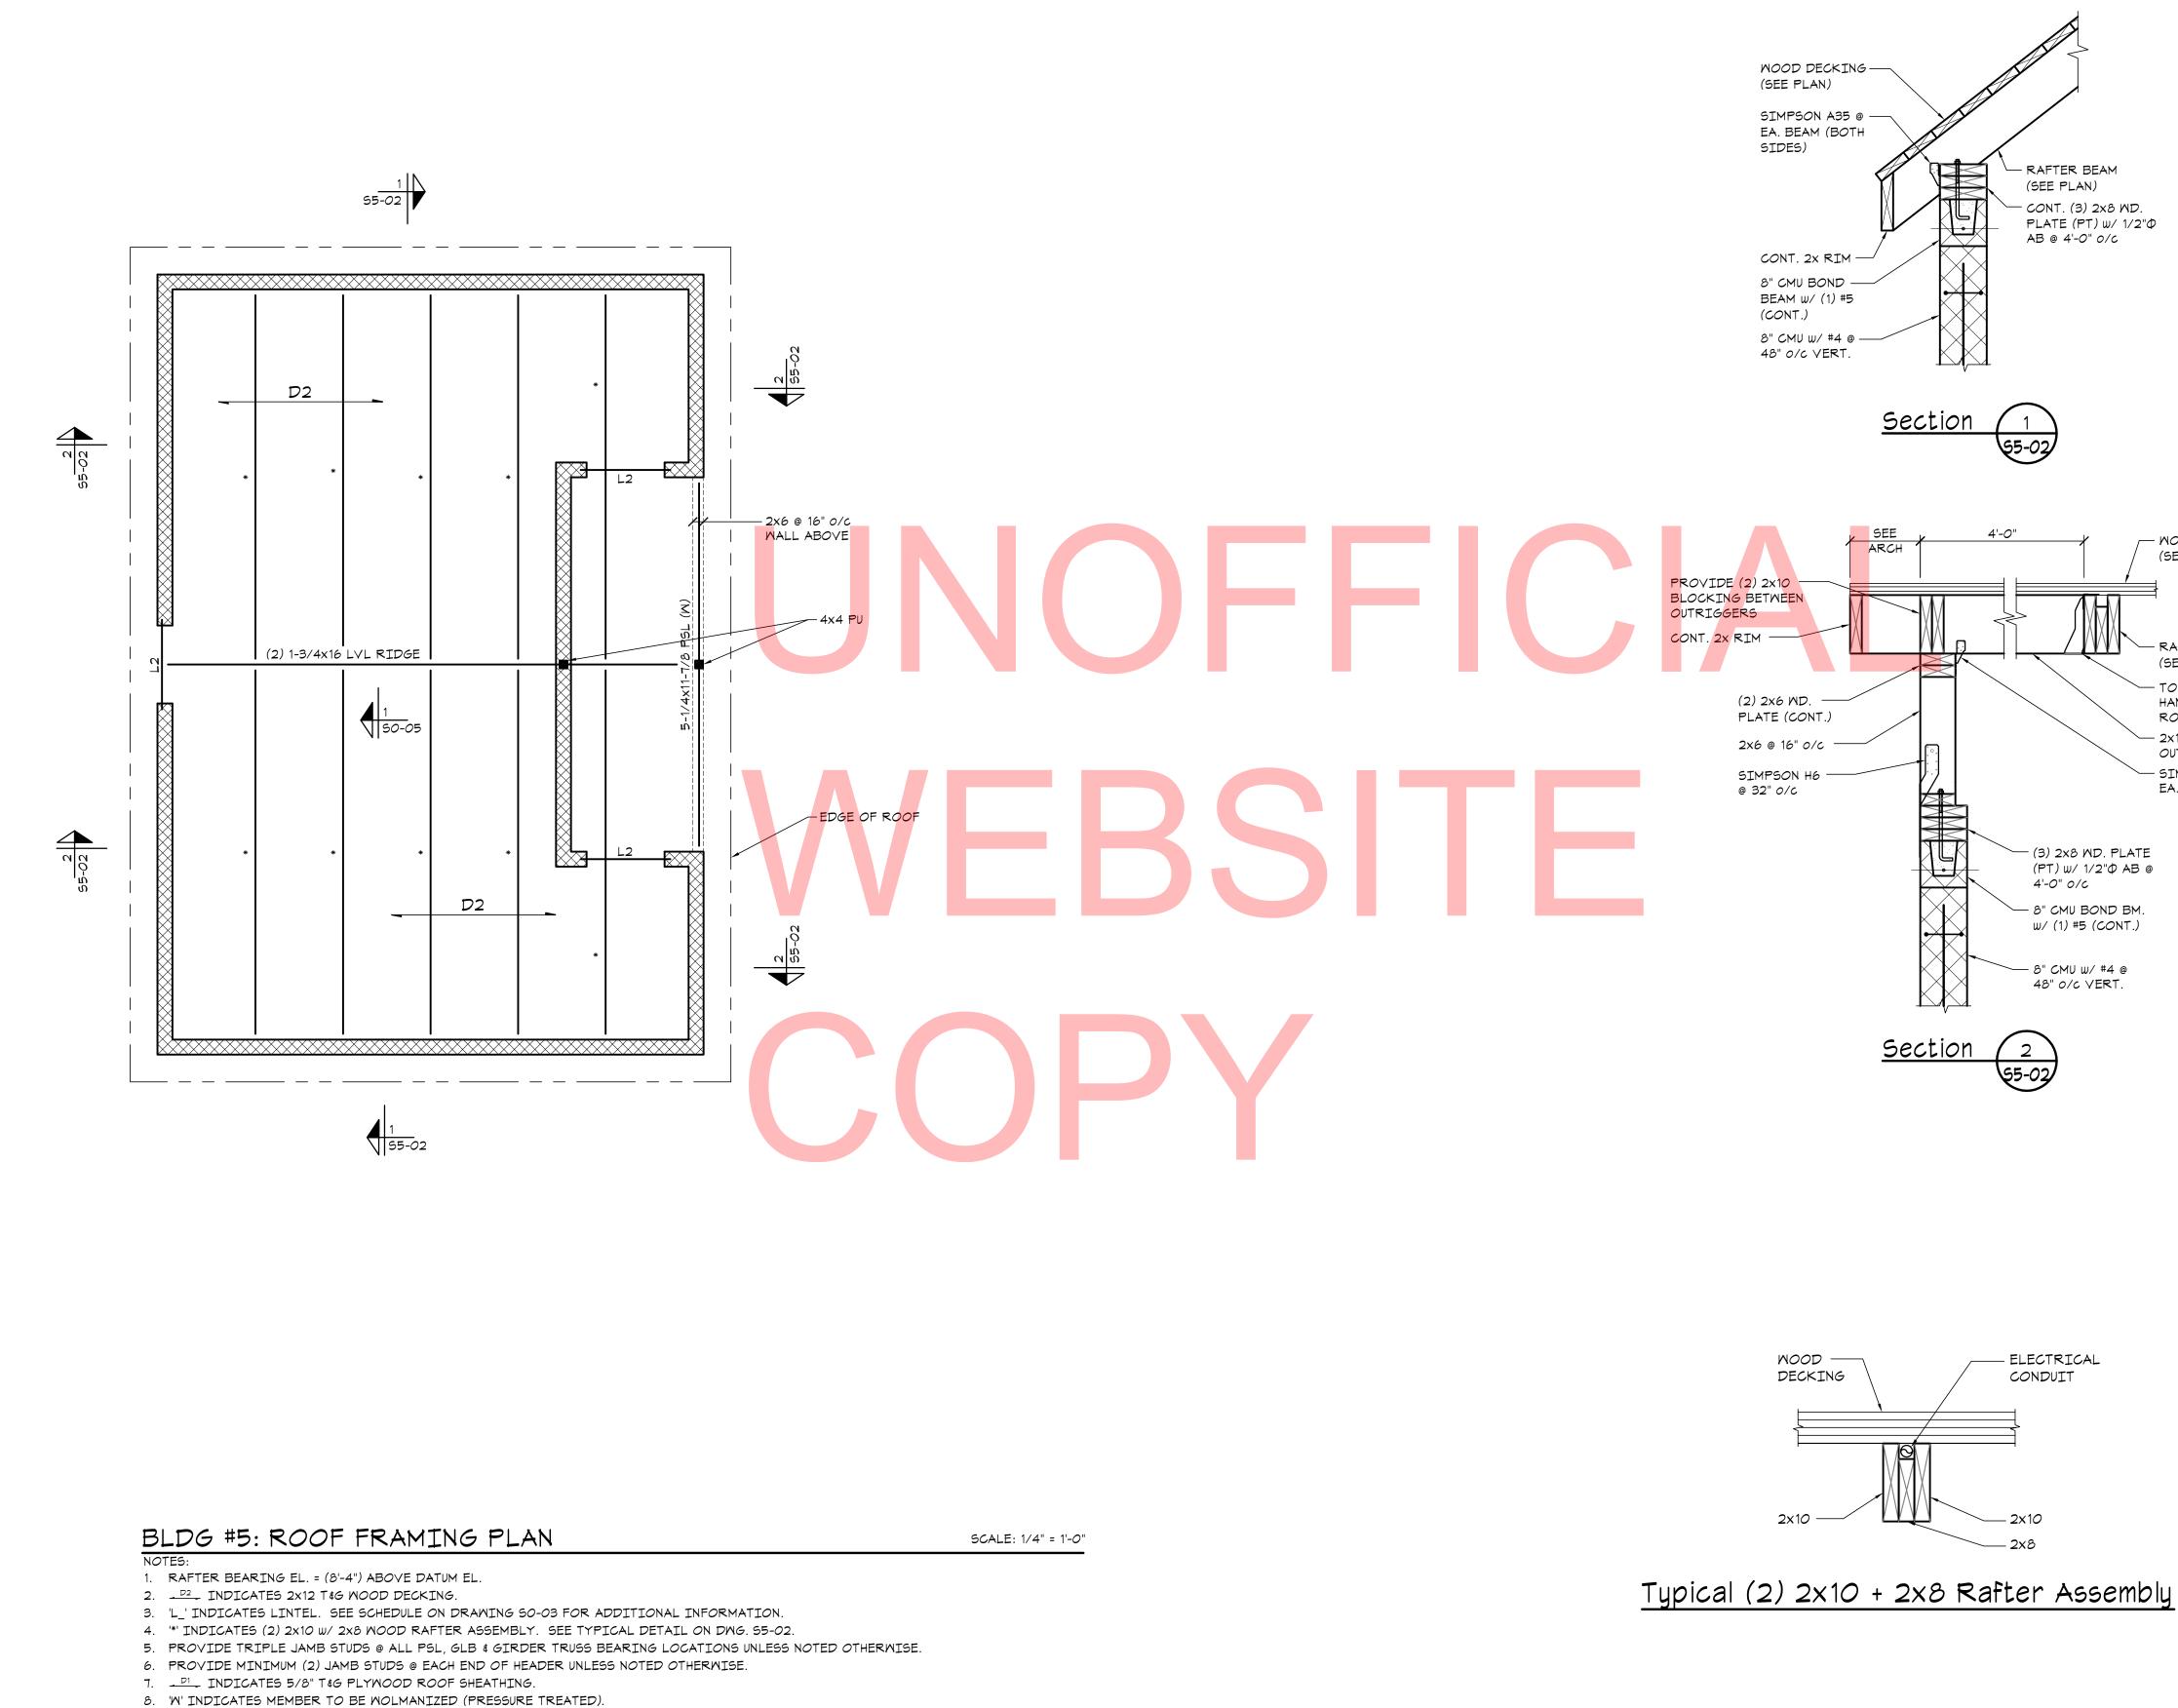



ADDENDUMS / REVISIONS

CONTRACT SHEET NO. BRIDGE NO. Х CD242 T200507303 BATH HOUSE - BUILDING 5 PLANS / DETAILS DRAWN BY: JNR COUNTY TOTAL SHTS. CHECKED BY: JRB 282 SUSSEX S5-02


SCALE AS NOTED

INDIAN RIVER INLET PARK ENHANCEMENTS

- WOOD DECKING (SEE PLAN) / V V \ RAFTER BEAM (SEE PLAN) - TOP FLANGE HANGER @ EA. ROOF OUTRIGGER — 2x10 @ 2'-0"

OUTRIGGER

- SIMPSON H2.5A @ EA. OUTRIGGER

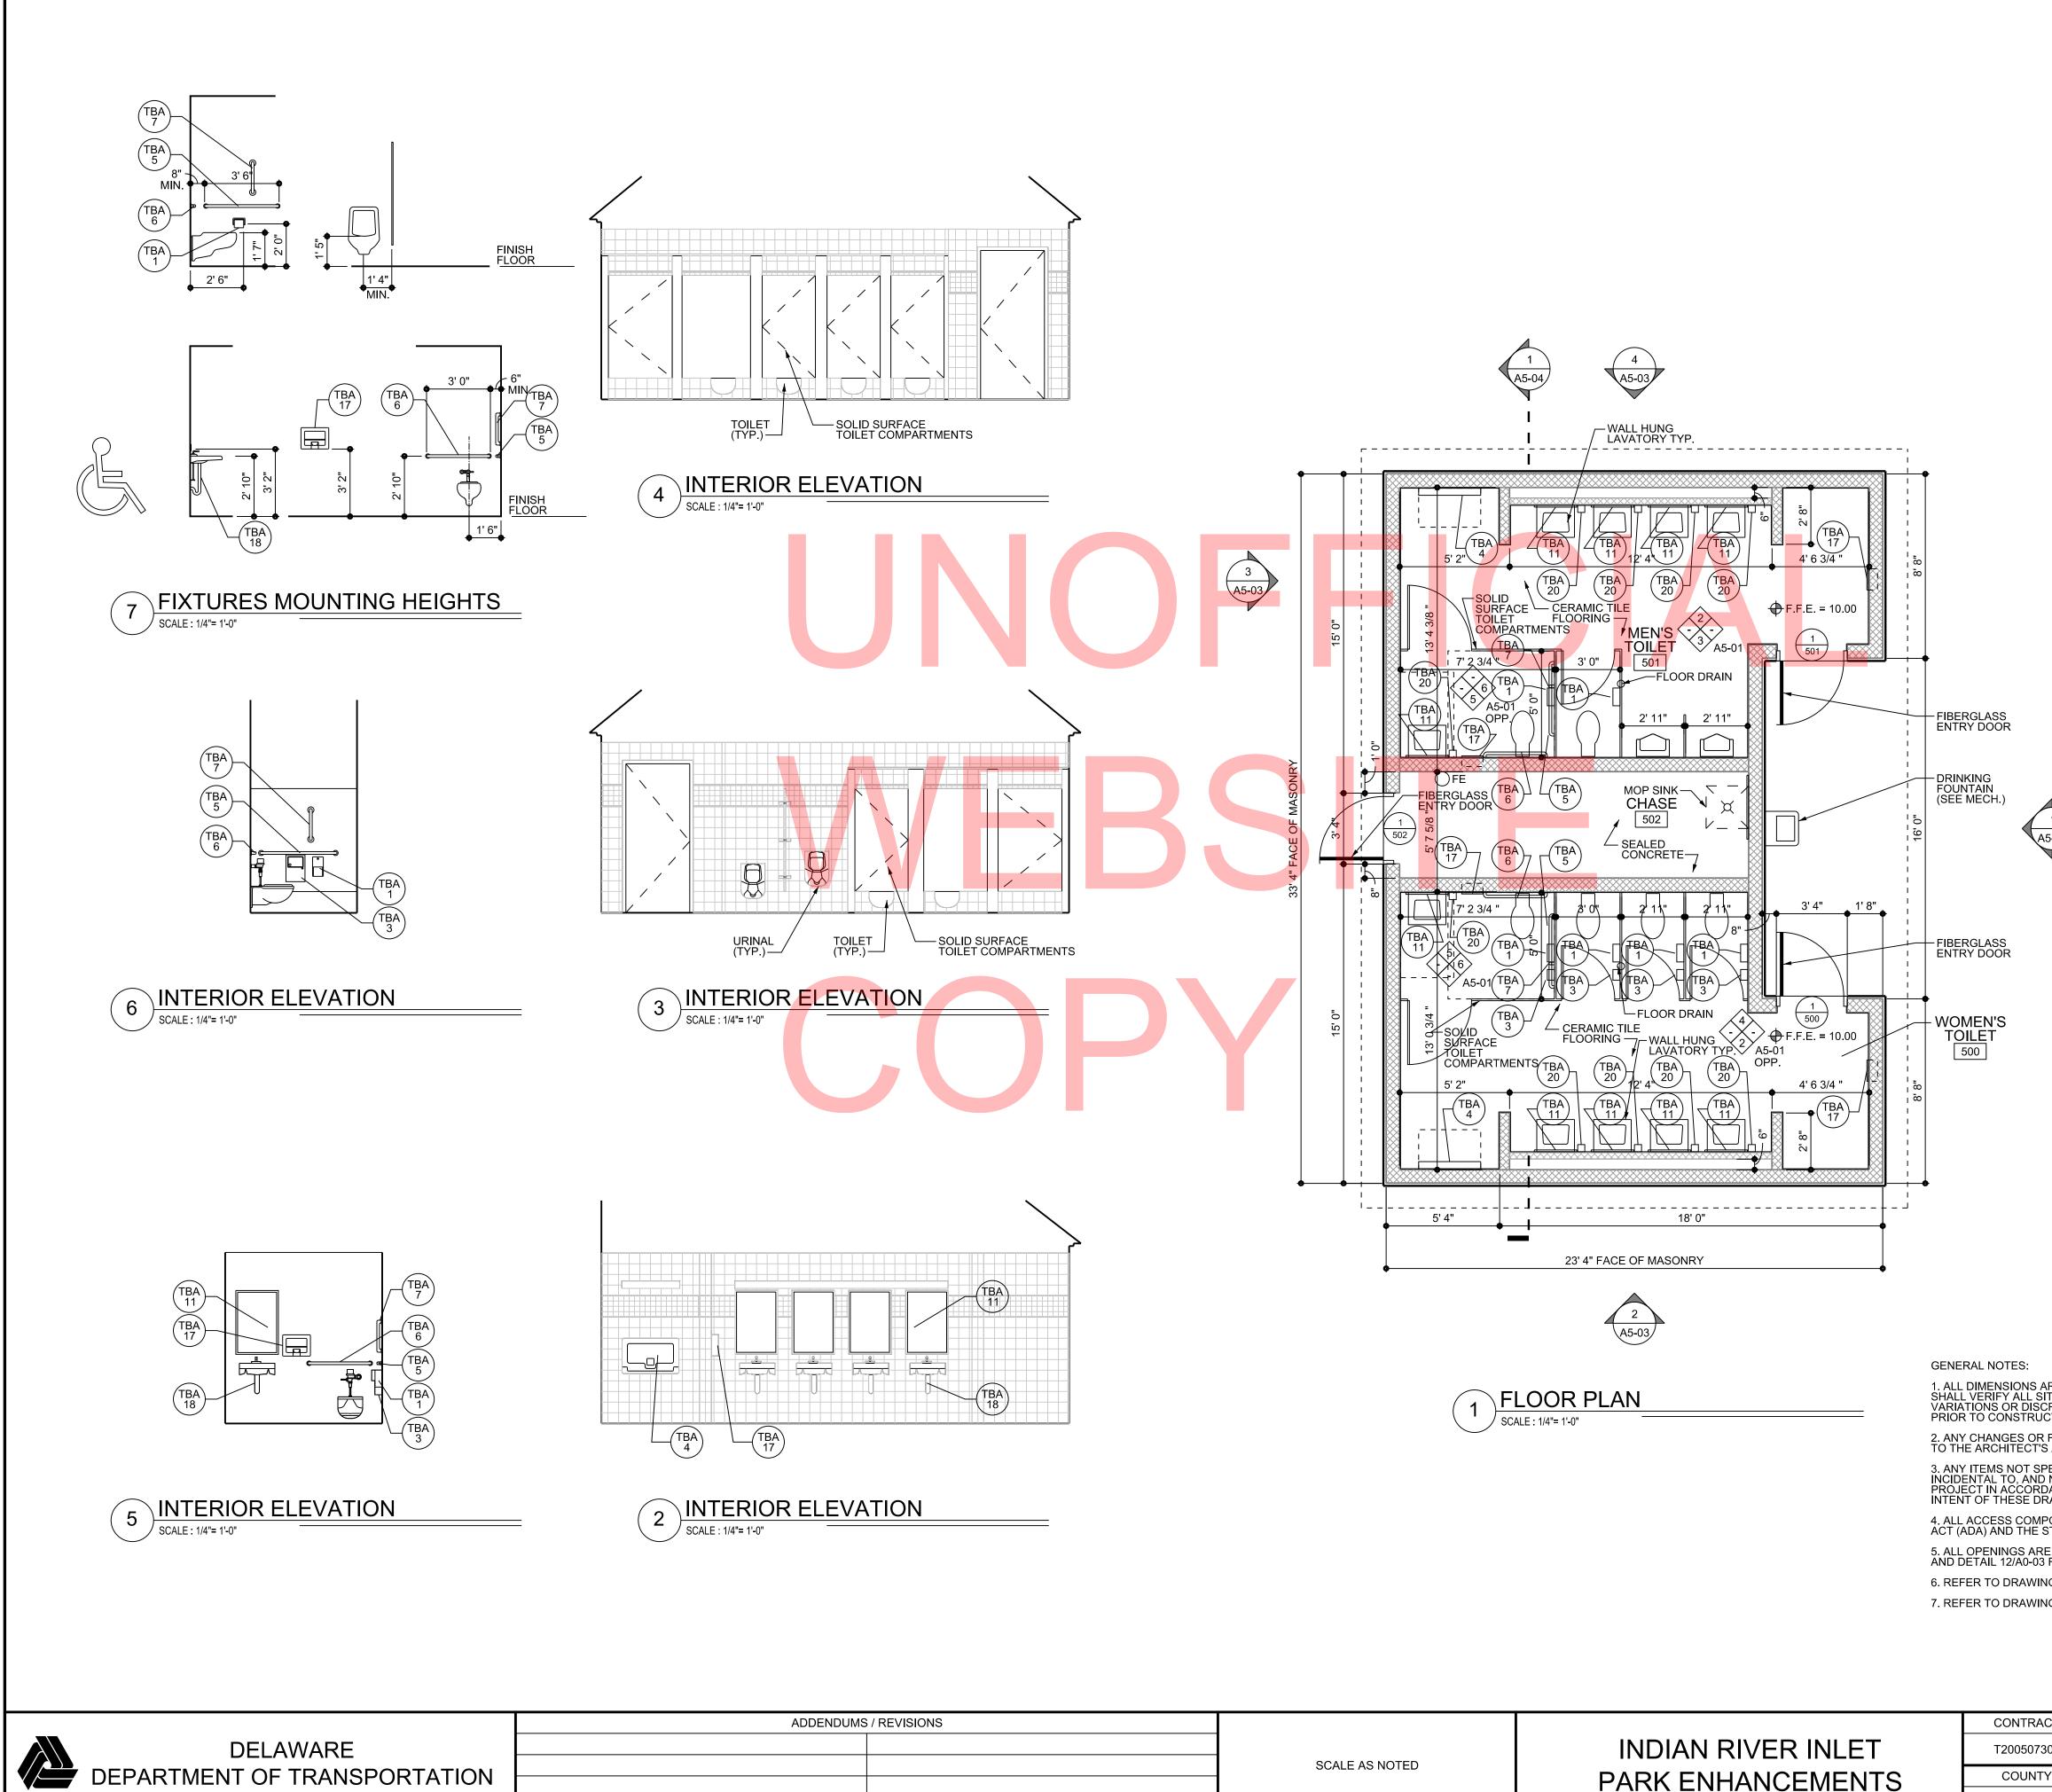

PROJECT IN A INTENT OF TH
4. ALL ACCESS ACT (ADA) ANI
5. ALL OPENIN AND DETAIL 12
6. REFER TO D
7 REFER TO D

5			

# PARK ENHANCEMENTS

	(TBA) 6 GRAB BAR, 36", STRAIGHT
	(TBA) 7 GRAB BAR, 18", STRAIGHT
	(TBA) 8 GRAB BAR, 48", STRAIGHT
	(1BA) 9 GRAB BAR, 24", STRAIGHT
	(TBA) 10 GRAB BAR, 16", STRAIGHT
	(TBA) 11 MIRROR UNIT, 24" X 36"
	(TBA) 12 SHOWER CURTAIN ROD
	(TBA) 13) SHOWER CURTAIN
	TBA 14 FOLDING SHOWER SEAT
1	(TBA) 15 SOAP DISH
45-03	TBA 16 ROB HOOK
	(TBA) 17) WARM-AIR HAND DRYER
	(TBA) 18 UNDERLAVATORY GUARD
	(TBA) 19 MOP AND BROOM HOLDER
	(TBA) 20) SOAP DISPENSER
	(TBA) 21) CLOTHES HOOK
ARE TO FACE OF CMU UNLESS NOTED OTHERWISE TTE CONDITIONS AND DIMENSIONS PRIOR TO CONS CREPANCIES SHALL BE BROUGHT TO THE ARCHITE ICTION.	STRUCTION. ANY
R FIELD ALTERATIONS TO THESE DESIGN DRAWING S ATTENTION FOR REVIEW PRIOR TO CONSTRUCTI	S SHALL BE BROUGHT ON.
PECIFICALLY SHOWN ON THE DRAWINGS, BUT ARE D NECESSARY FOR THE SATISFACTORY COMPLETION DANCE WITH INDUSTRY STANDARDS, ARE INCLUDE RAWINGS.	REASONABLY ON OF THE ED WITHIN THE
PONENTS TO COMPLY TO ANSI A117.1 THE AMERIC STATE OF DELAWARE'S ARCHITECTURAL ACCESSI	ANS WITH DISABILITIES BILITY BOARD.
RE TO HAVE STORM PANELS. REFER TO SPECIFICAT 3 FOR ADDITIONAL INFORMATION.	
NG A0-04 / CD176 STANDARD DETAILS FOR TYPICAL NG A0-03 / CD175 FOR DOOR SCHEDULE AND DETA	

ACCESSORIES LEGEND:

(TBA) 2 NOT USED


(TBA) TOILET TISSUE DISPENSER

 $\binom{\mathsf{TBA}}{4}$  DIAPER CHANGING STATION

 $\binom{\mathsf{TBA}}{5}$  GRAB BAR, 42", STRAIGHT

 $\binom{\mathsf{TBA}}{3}$ SANITARY NAPKIN DISPOSAL - SURFACE MOUNTED

ONTRACT	BRIDGE NO.	Х			SHEET NO.
200507303			BATH HOUSE -		CD243
COUNTY	DRAWN BY:	JAA	BUILDING 5 FLOOR PLAN AND		TOTAL SHTS.
		W/10	INTERIOR ELEVATIONS		
SUSSEX	CHECKED BY:	WJS		A5-01	282

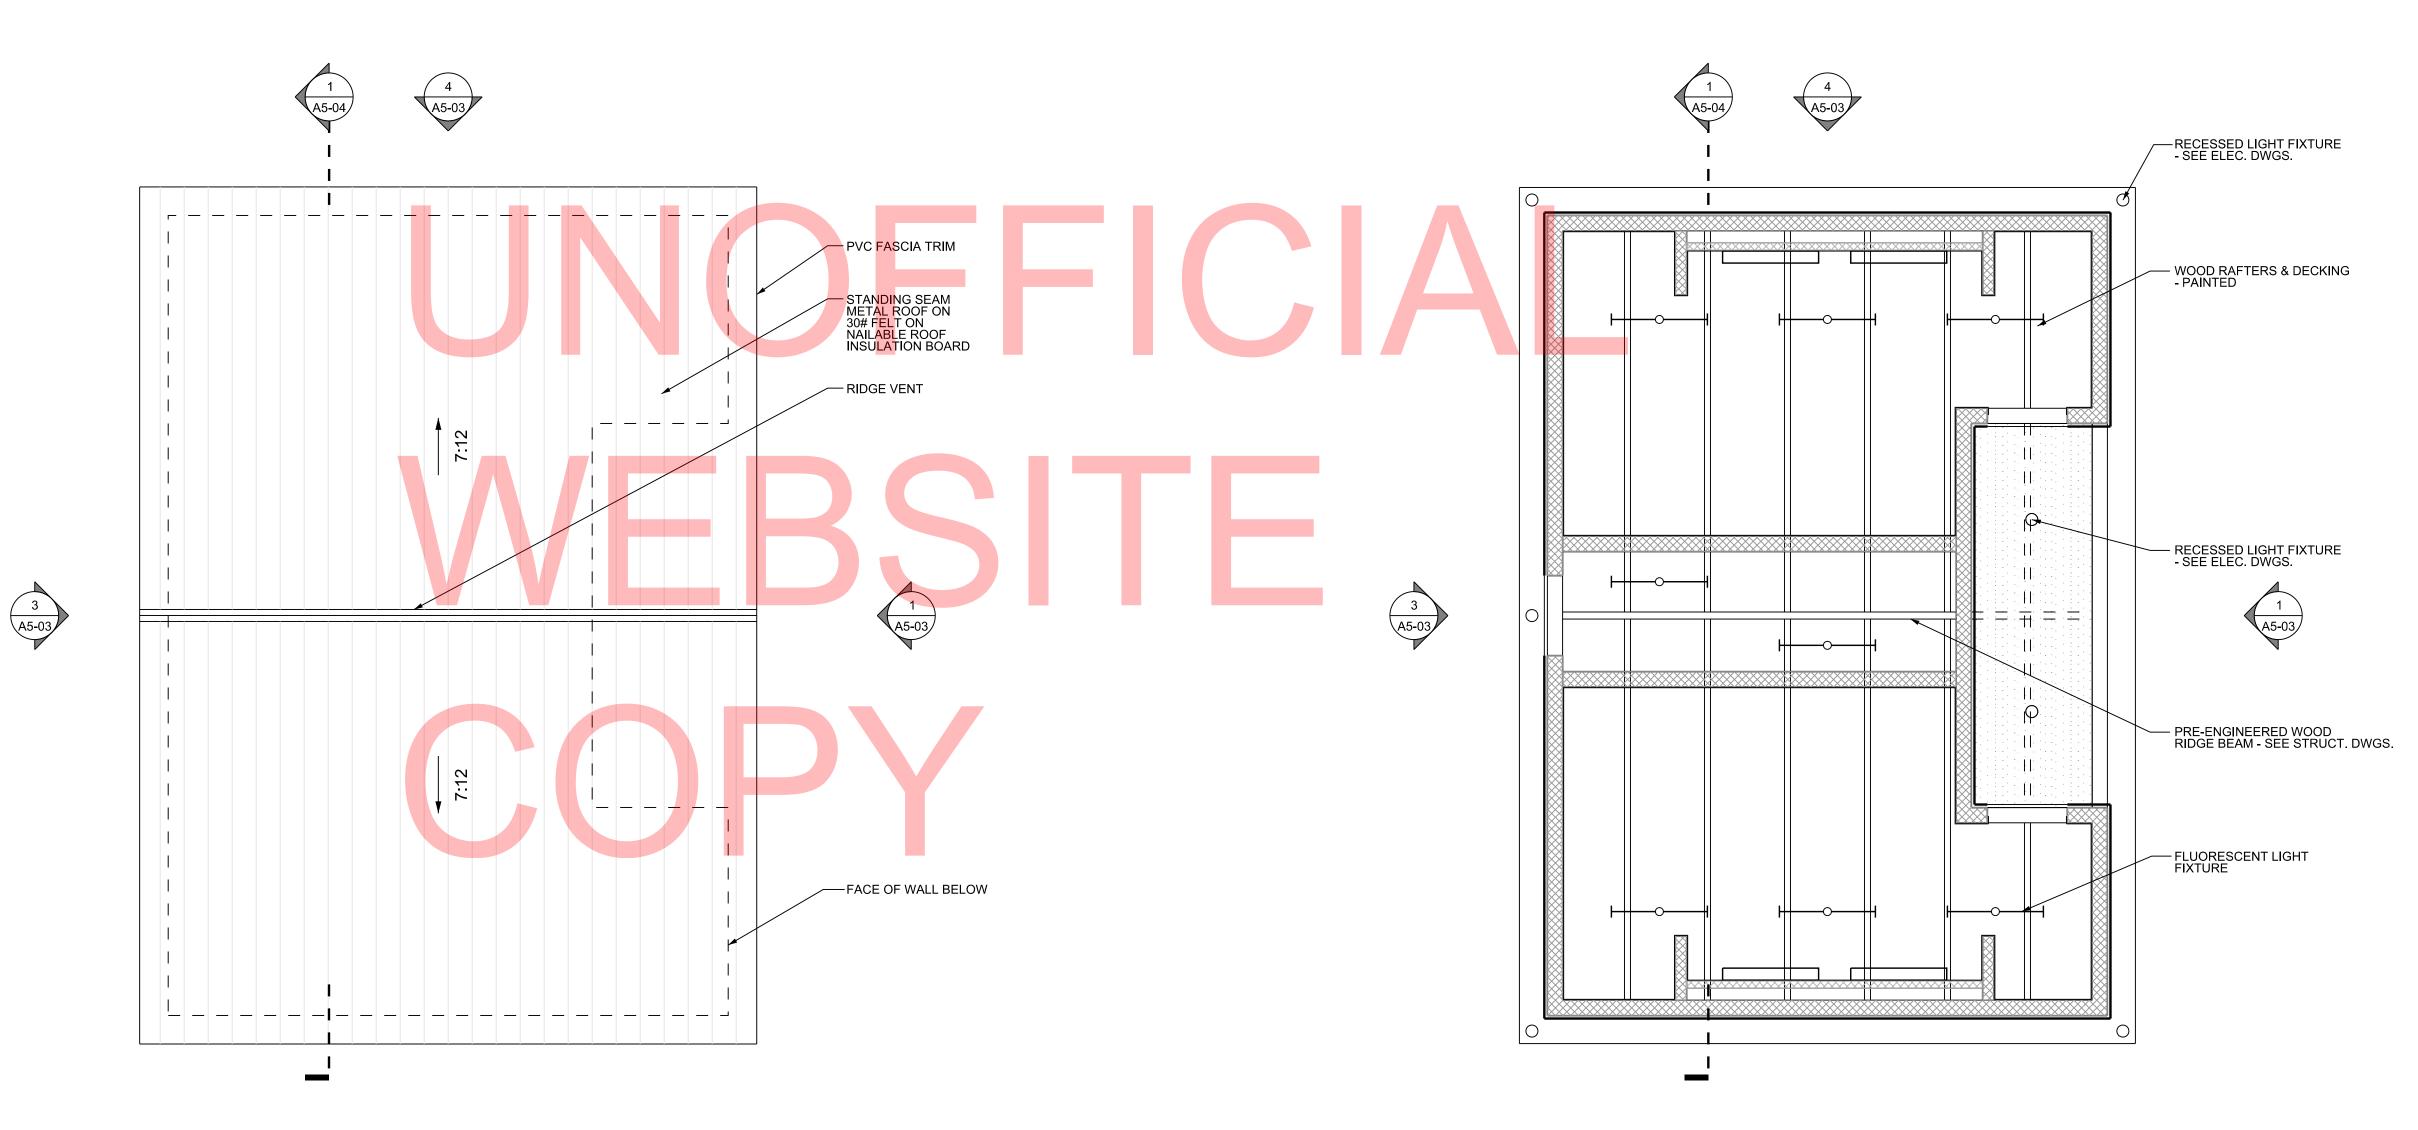






		ADDENDUMS	/ REVISIONS
DELAWARE DEPARTMENT OF TRANS	DELAWARE		
	DEPARTMENT OF TRANSPORTATION		



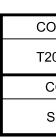


SCALE AS NOTED

### INDIAN RIVER INLET PARK ENHANCEMENTS




CONTRACT	BRIDGE NO.	Х		SHEET NO.
200507303			BATH HOUSE -	CD244
COUNTY	DRAWN BY:	JAA	BUILDING 5 PLANS	TOTAL SHTS.
SUSSEX	CHECKED BY:	WJS	A5-02	282

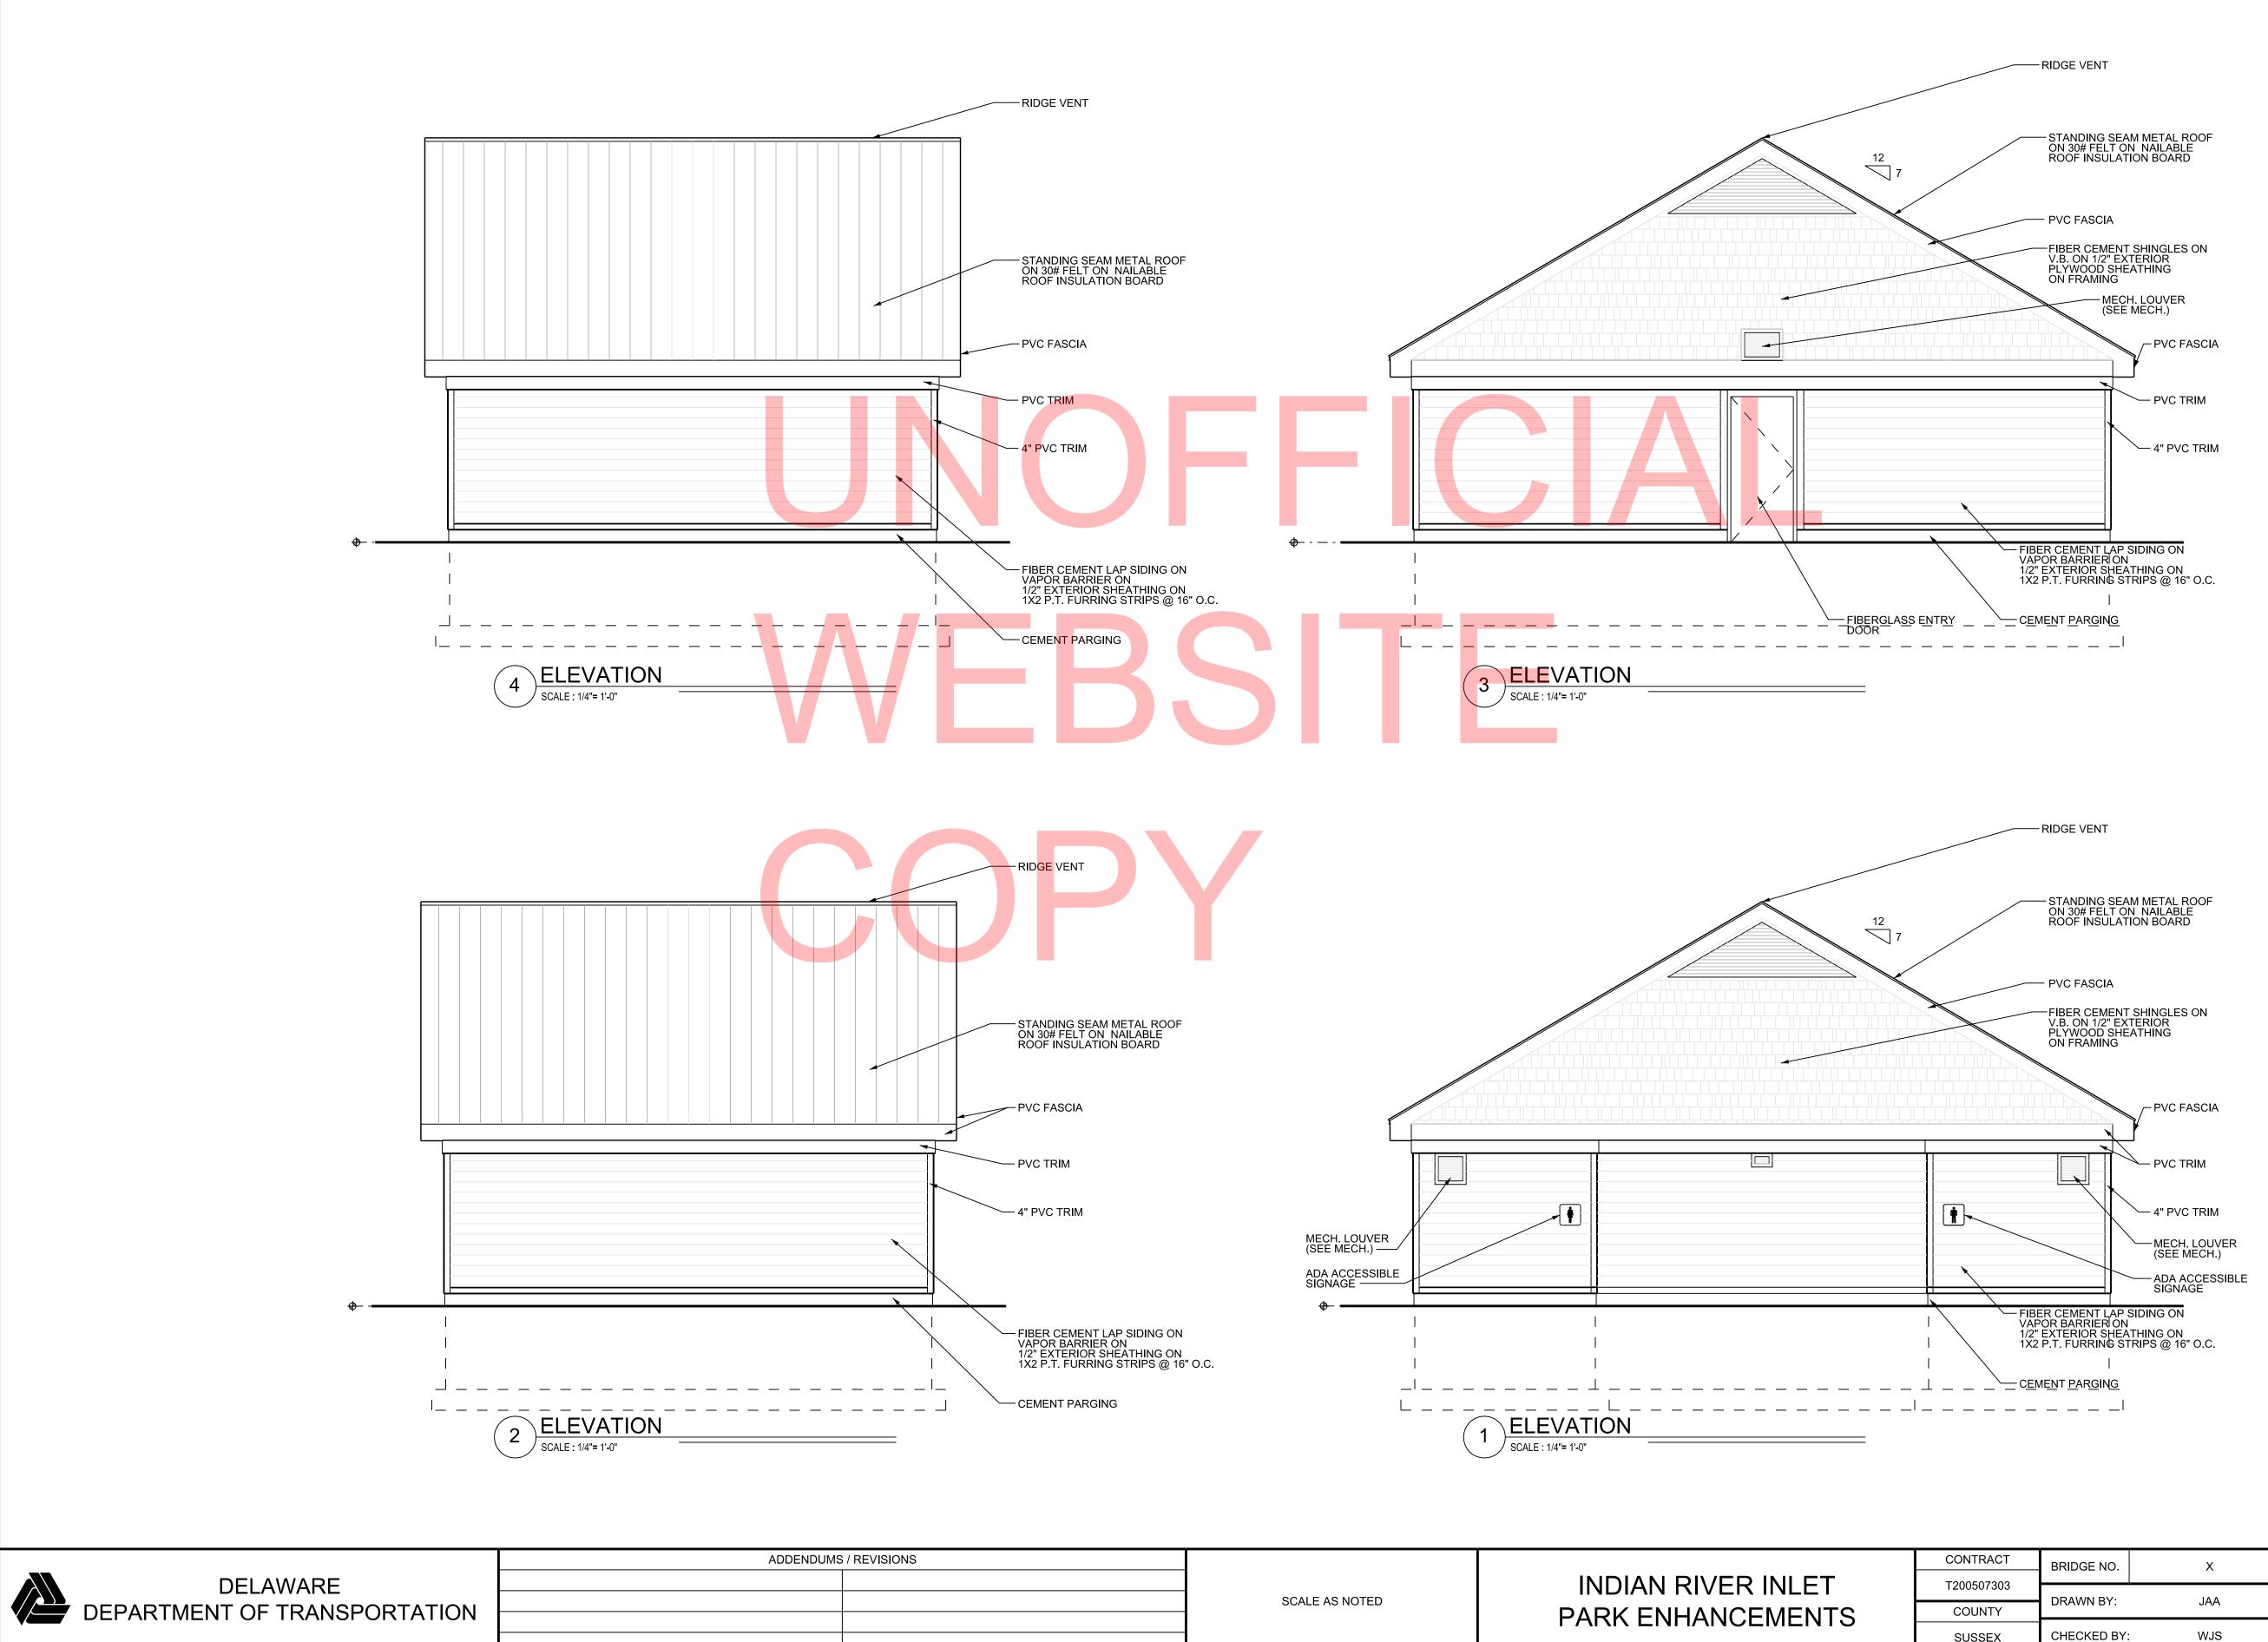


SCALE /	AS NOTE

## PARK ENHANCEMENTS

CONTRACT	BRIDGE NO.	Х			SHEET NO.
Г200507303		14.4	BATH HOUSE -		CD245
COUNTY	DRAWN BY:	JAA	BUILDING 5 EXTERIOR ELEVATIONS		TOTAL SHTS.
SUSSEX	CHECKED BY:	WJS		A5-03	282

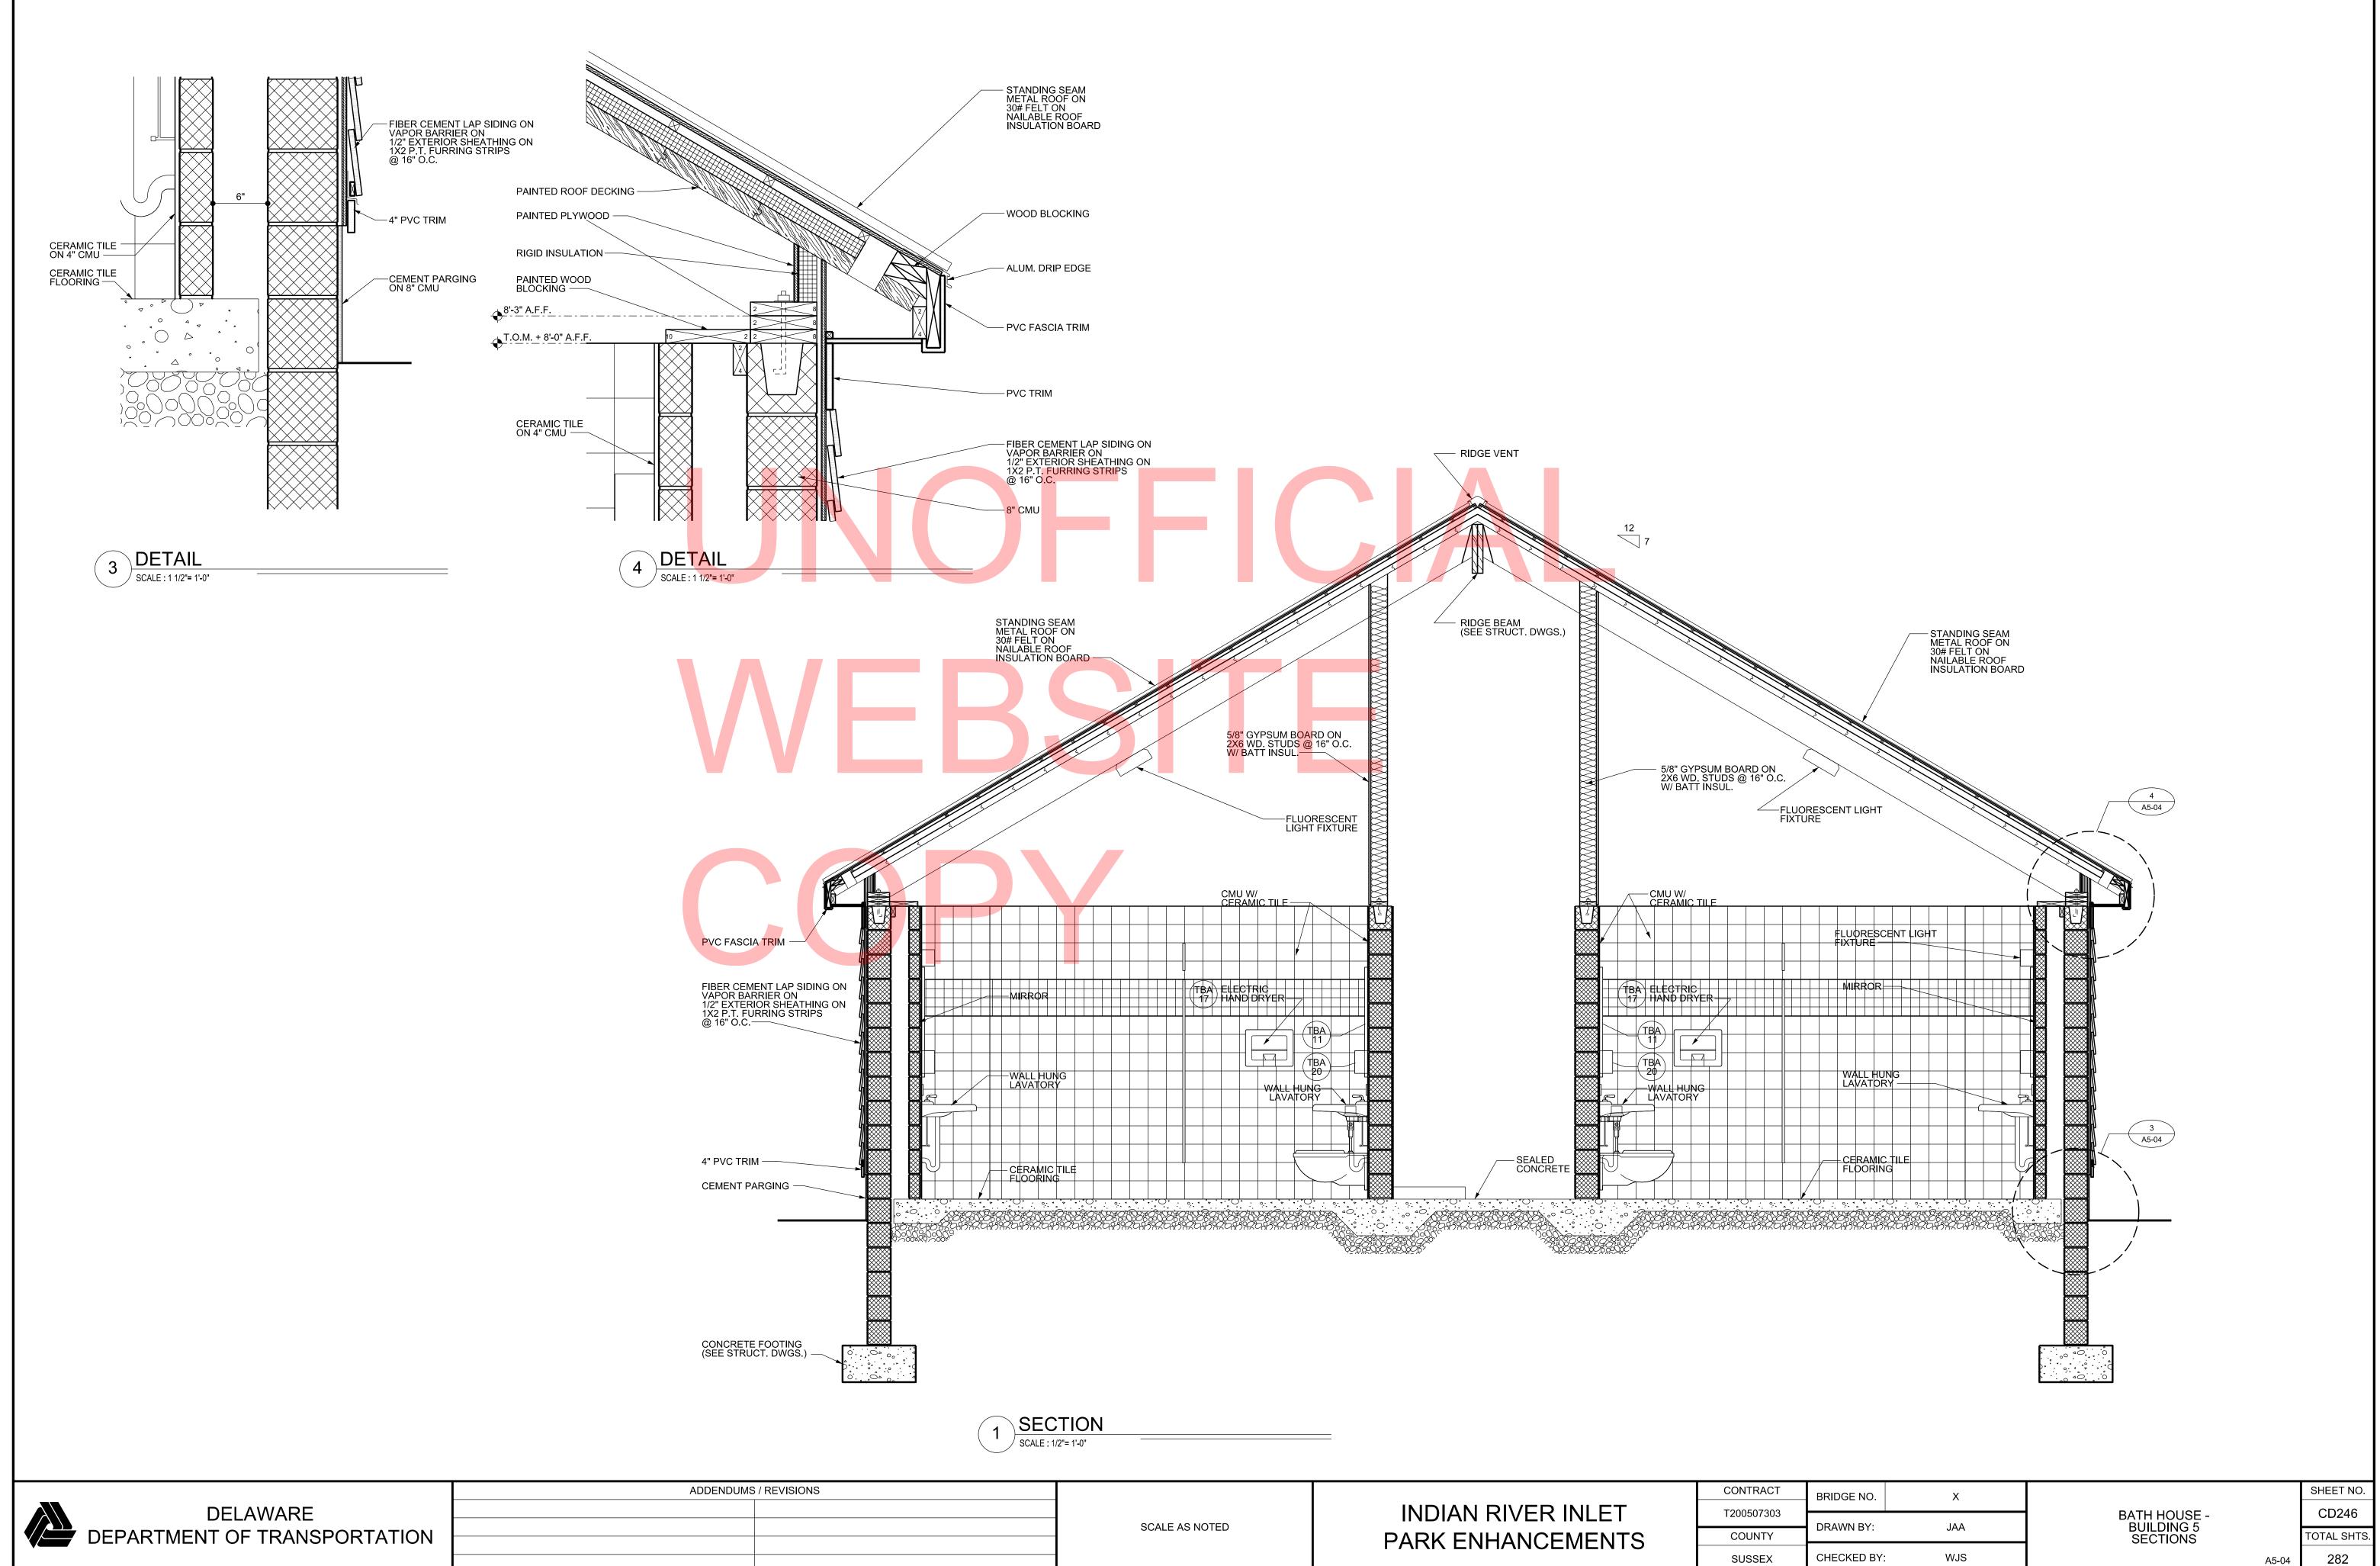



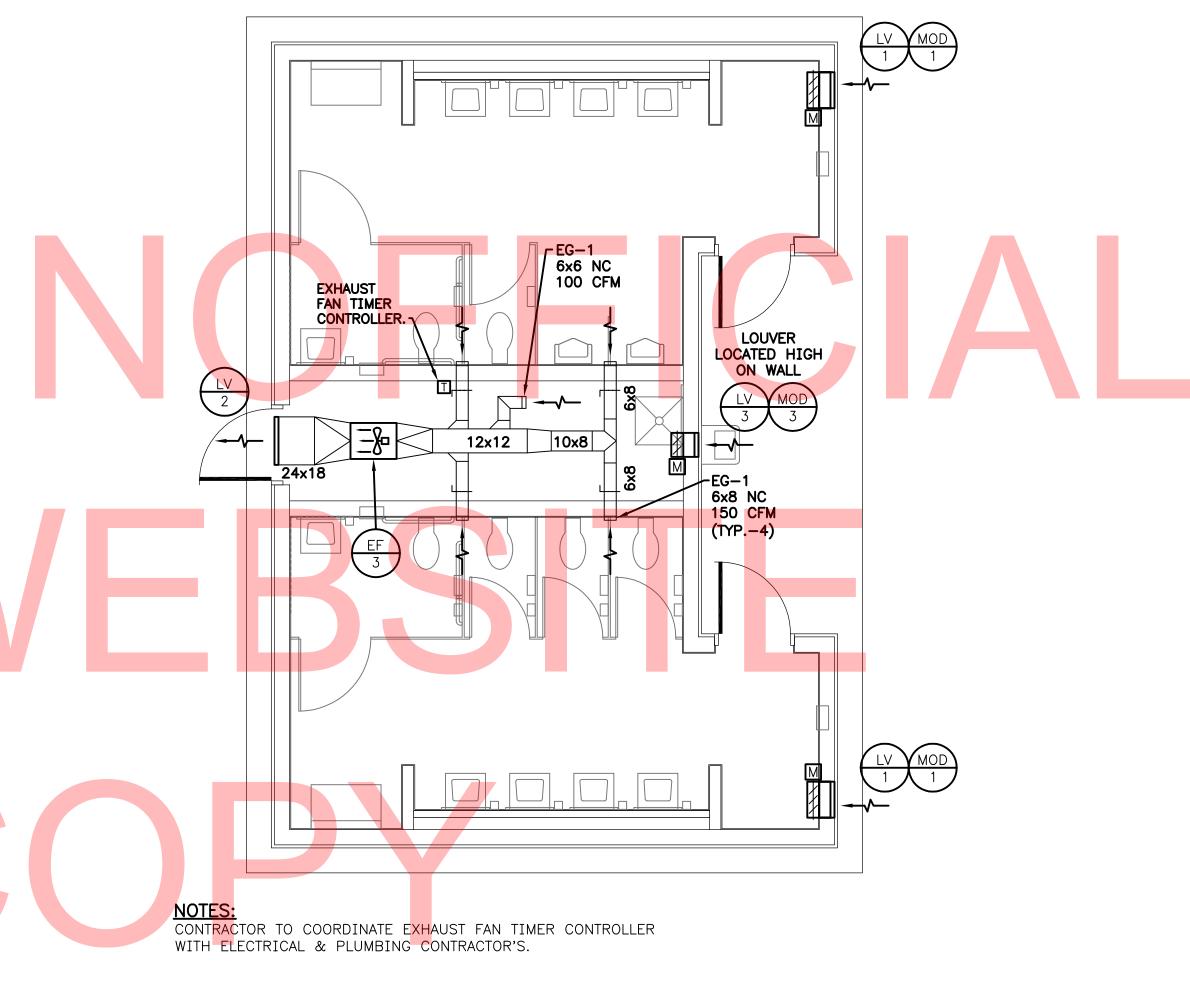



ADDENDUMS / REVISIONS


INDIAN RIVER INLET PARK ENHANCEMENTS

### CONTRACT T200507303 COUNTY SUSSEX

BRIDGE NO.	х
DRAWN BY:	MLF
CHECKED BY:	JRF


### BATH HOUSE **BUILDING 5** MECHANICAL PLANS

SHEET NO. CD247 TOTAL SHTS. CD282 M5-01

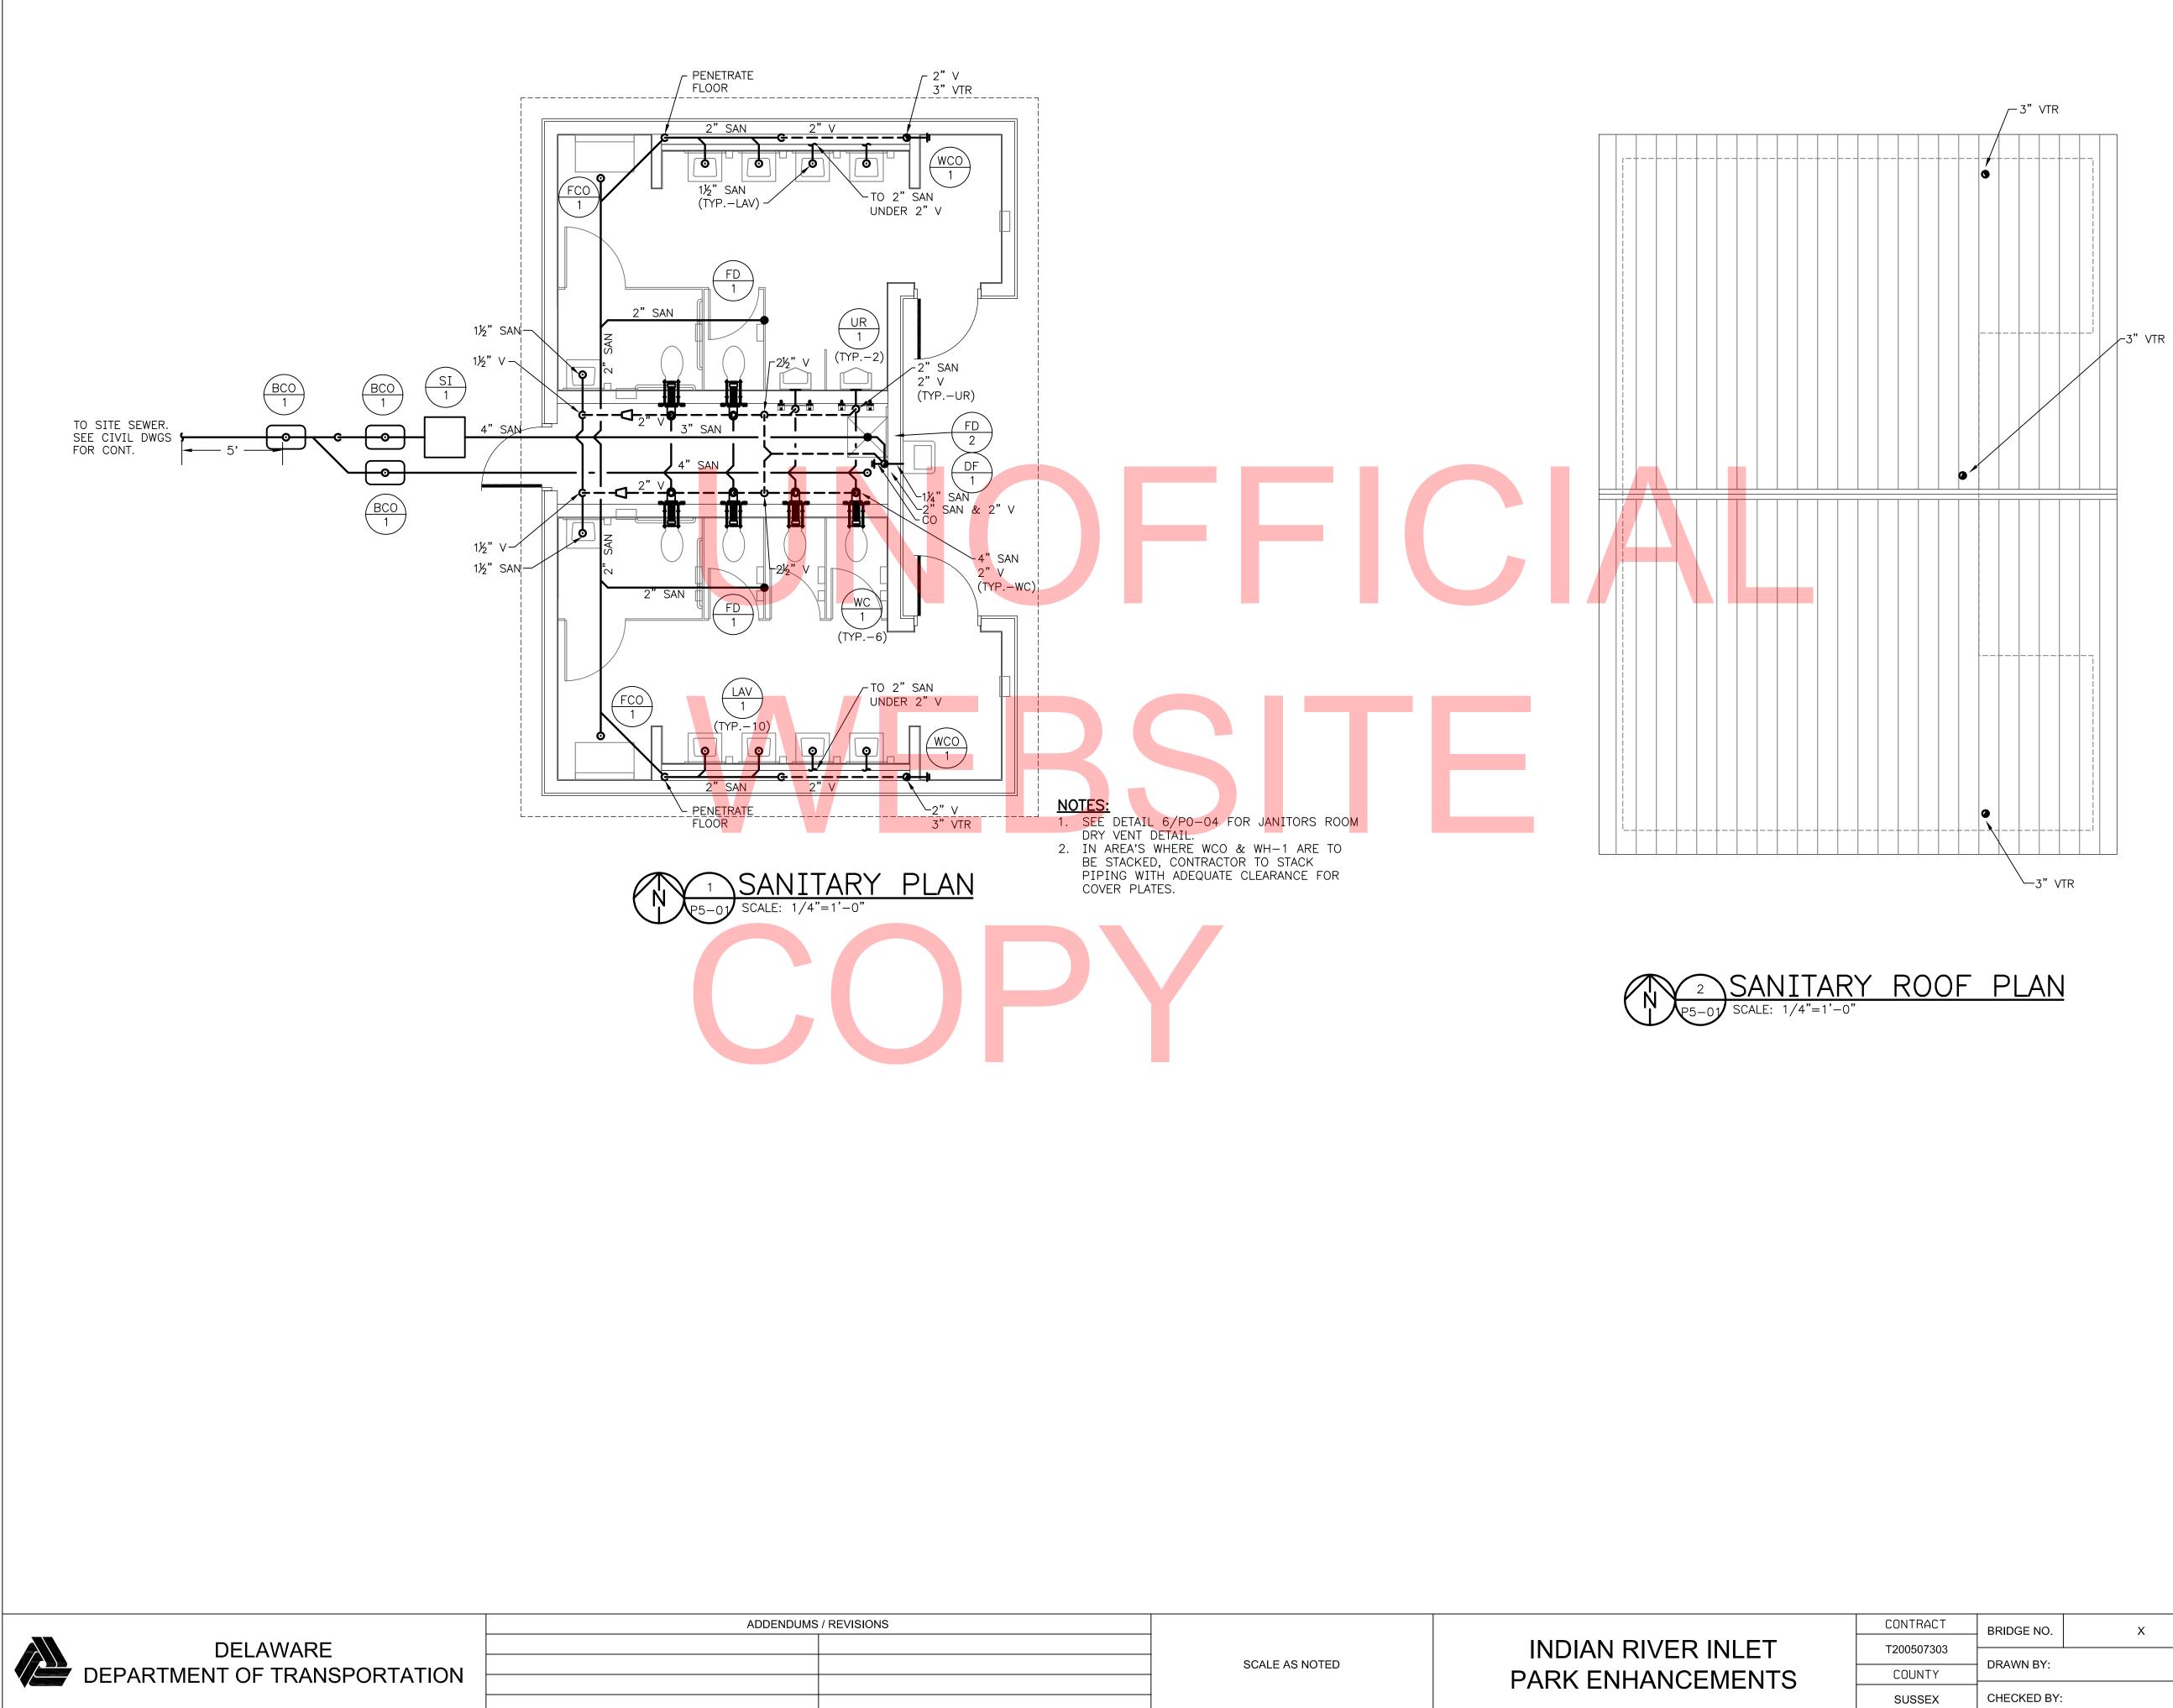

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	,
- ~ [	тот
-2)	
P5-01	(
•	F 2) P5-01

SHEET NO. CD248 OTAL SHTS. CD282

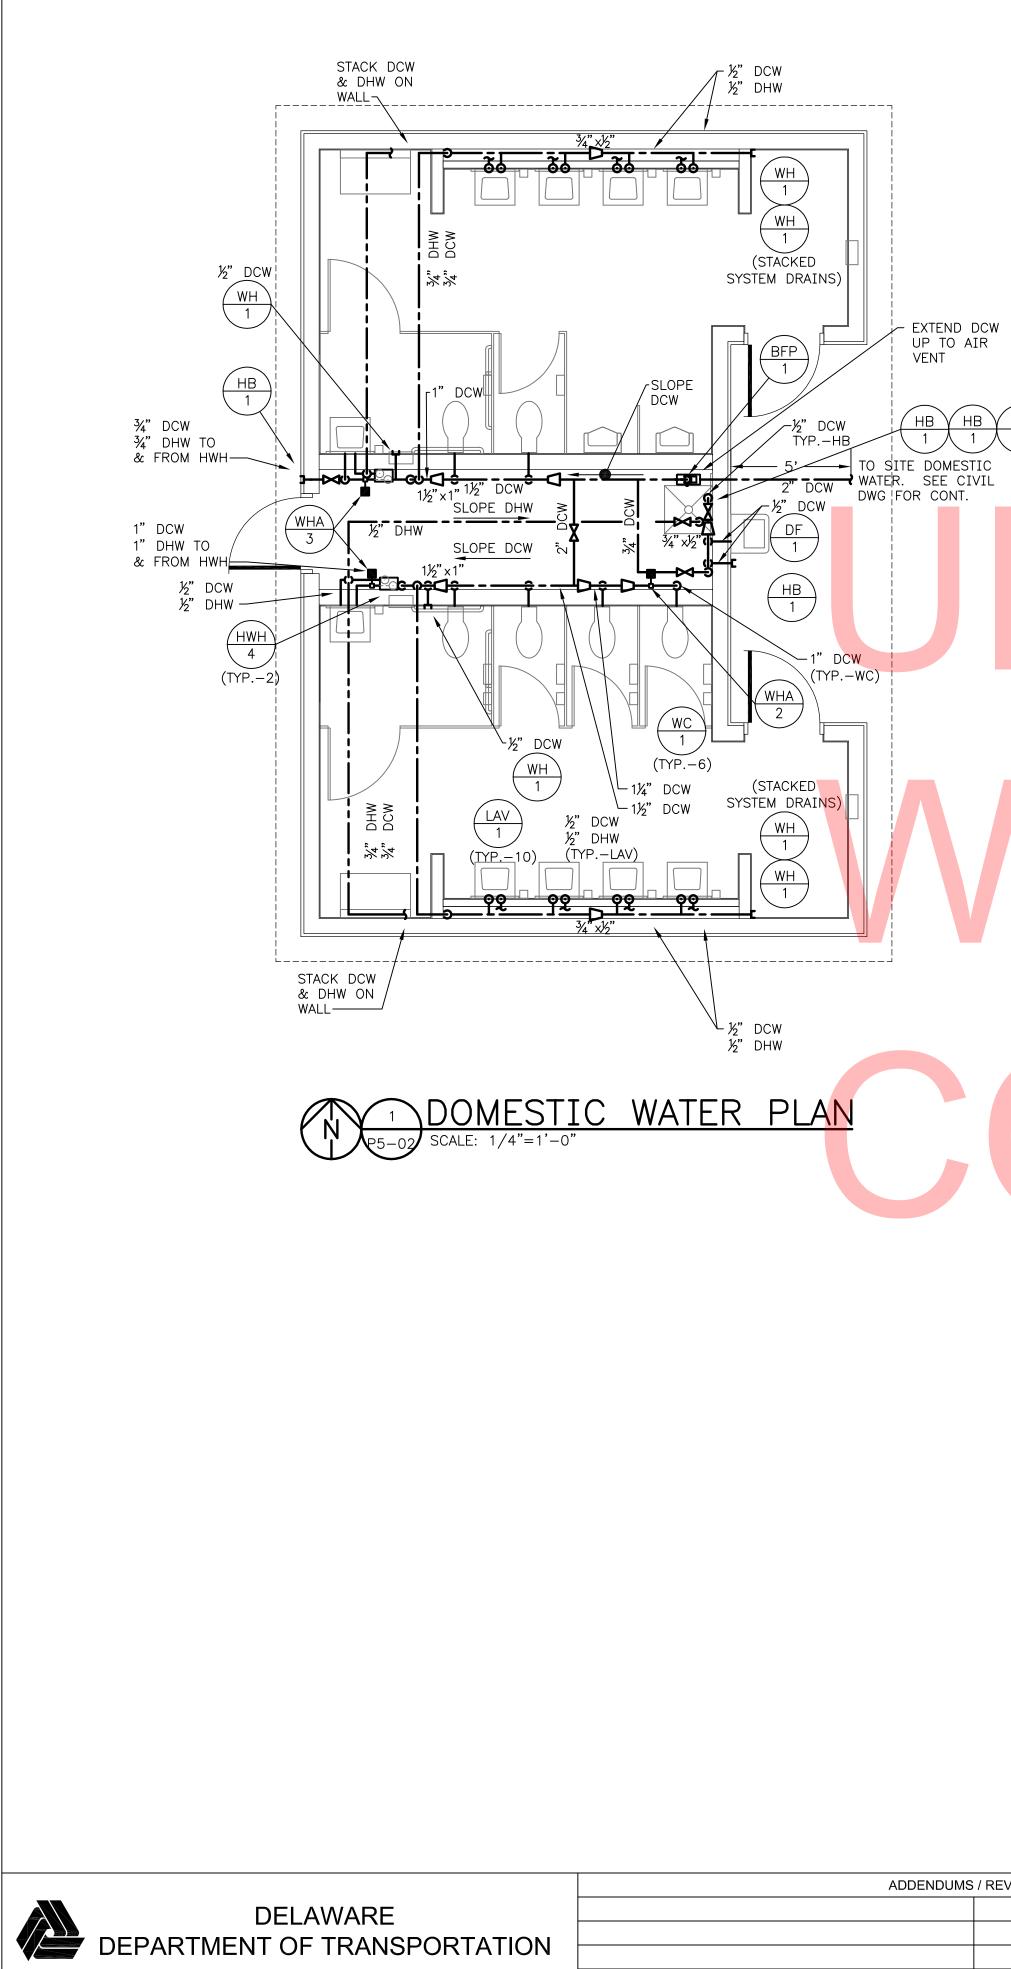

- DHW.
- 5. IN AREA'S WHERE WCO & WH-1 ARE TO BE STACKED, CONTRACTOR TO STACK PIPING WITH ADEQUATE CLEARANCE FOR COVER PLATES.

ADDENDUMS / REVISIONS

### INDIAN RIVER INLET PARK ENHANCEMENTS


NOTES:
1. REFER TO P0-01 FOR PLUMBING NOTES AND LEGEND
2. SLOPE ALL PIPING TOWARDS SYSTEM DRAIN.
3. CONTRACTOR TO PROVIDE SHUT OFF VALVE IN ALL FIXTURE BRANCHES. NOT SHOWN ON DRAWING FOR CLARITY.
4. CONTRACTOR TO MANIFOLD HWH'S TOGETHER FOR DCW AND DHW


CONTRACT T200507303 COUNTY SUSSEX


BRIDGE NO. Х MLF DRAWN BY: JRF CHECKED BY:


BATH HOUSE **BUILDING 5** PLUMBING PLANS (SHEET 2 OF 2) P5-02

SHEET NO. CD249 TOTAL SHTS. CD282

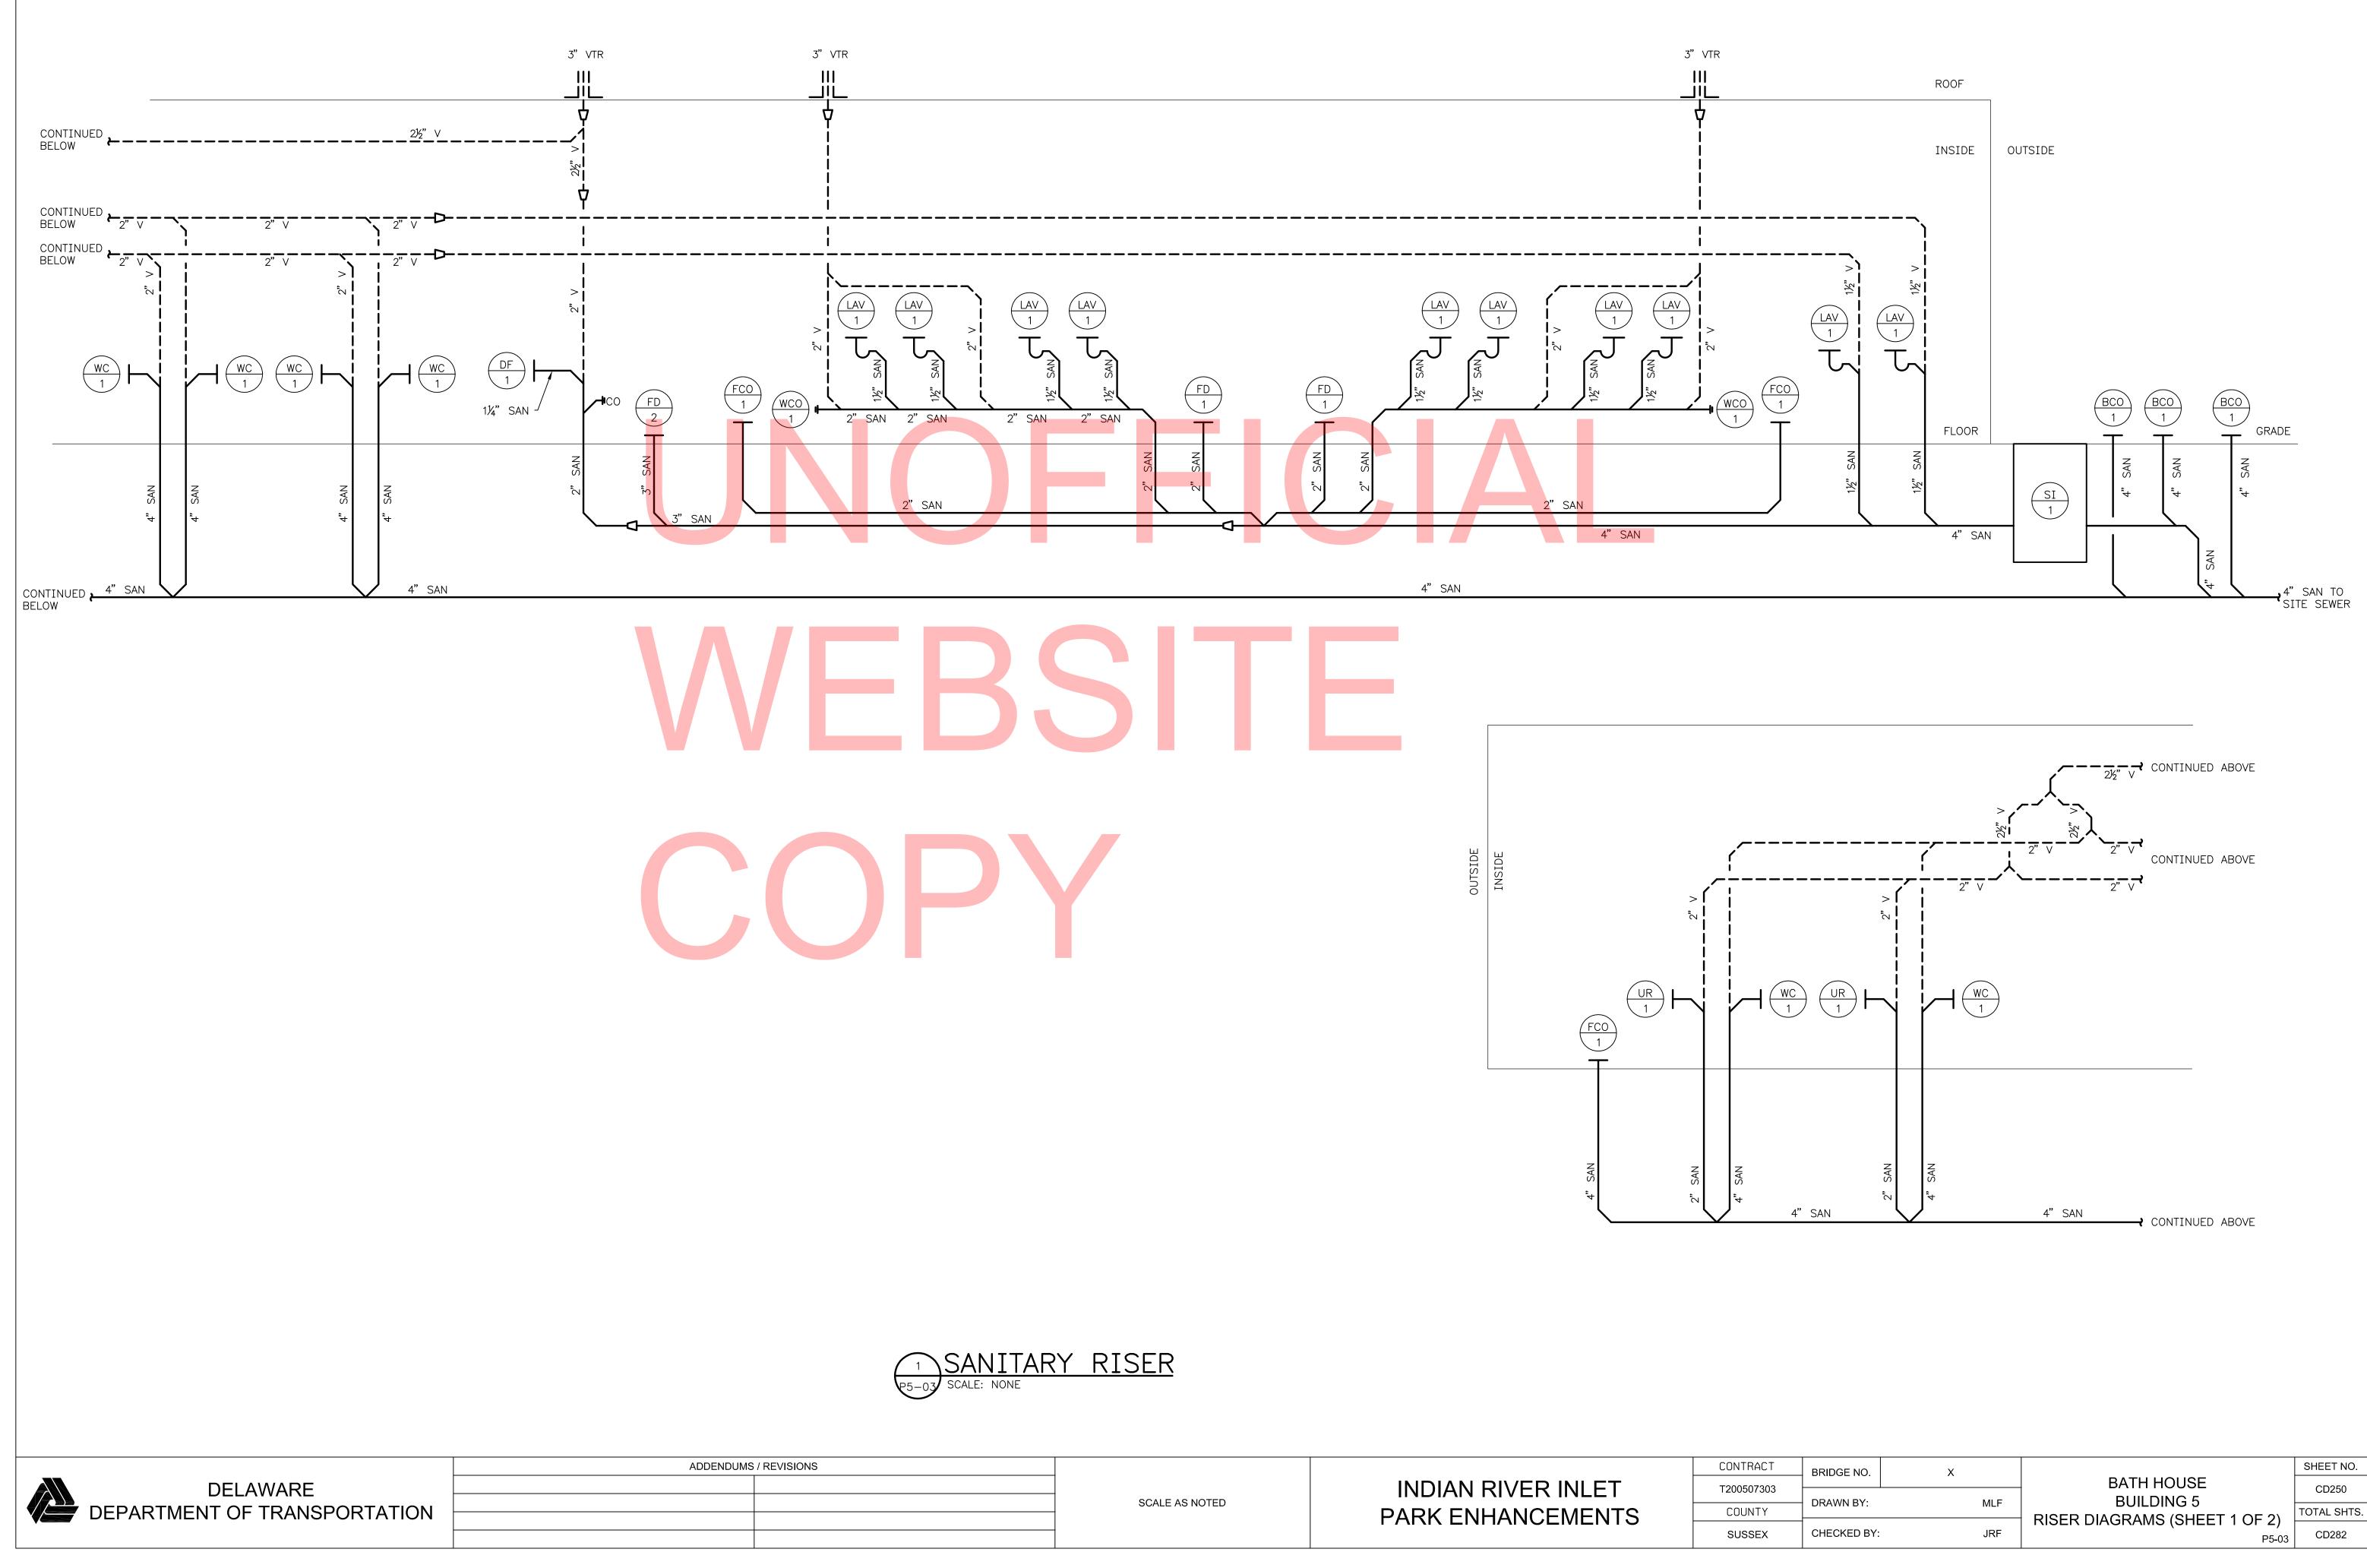

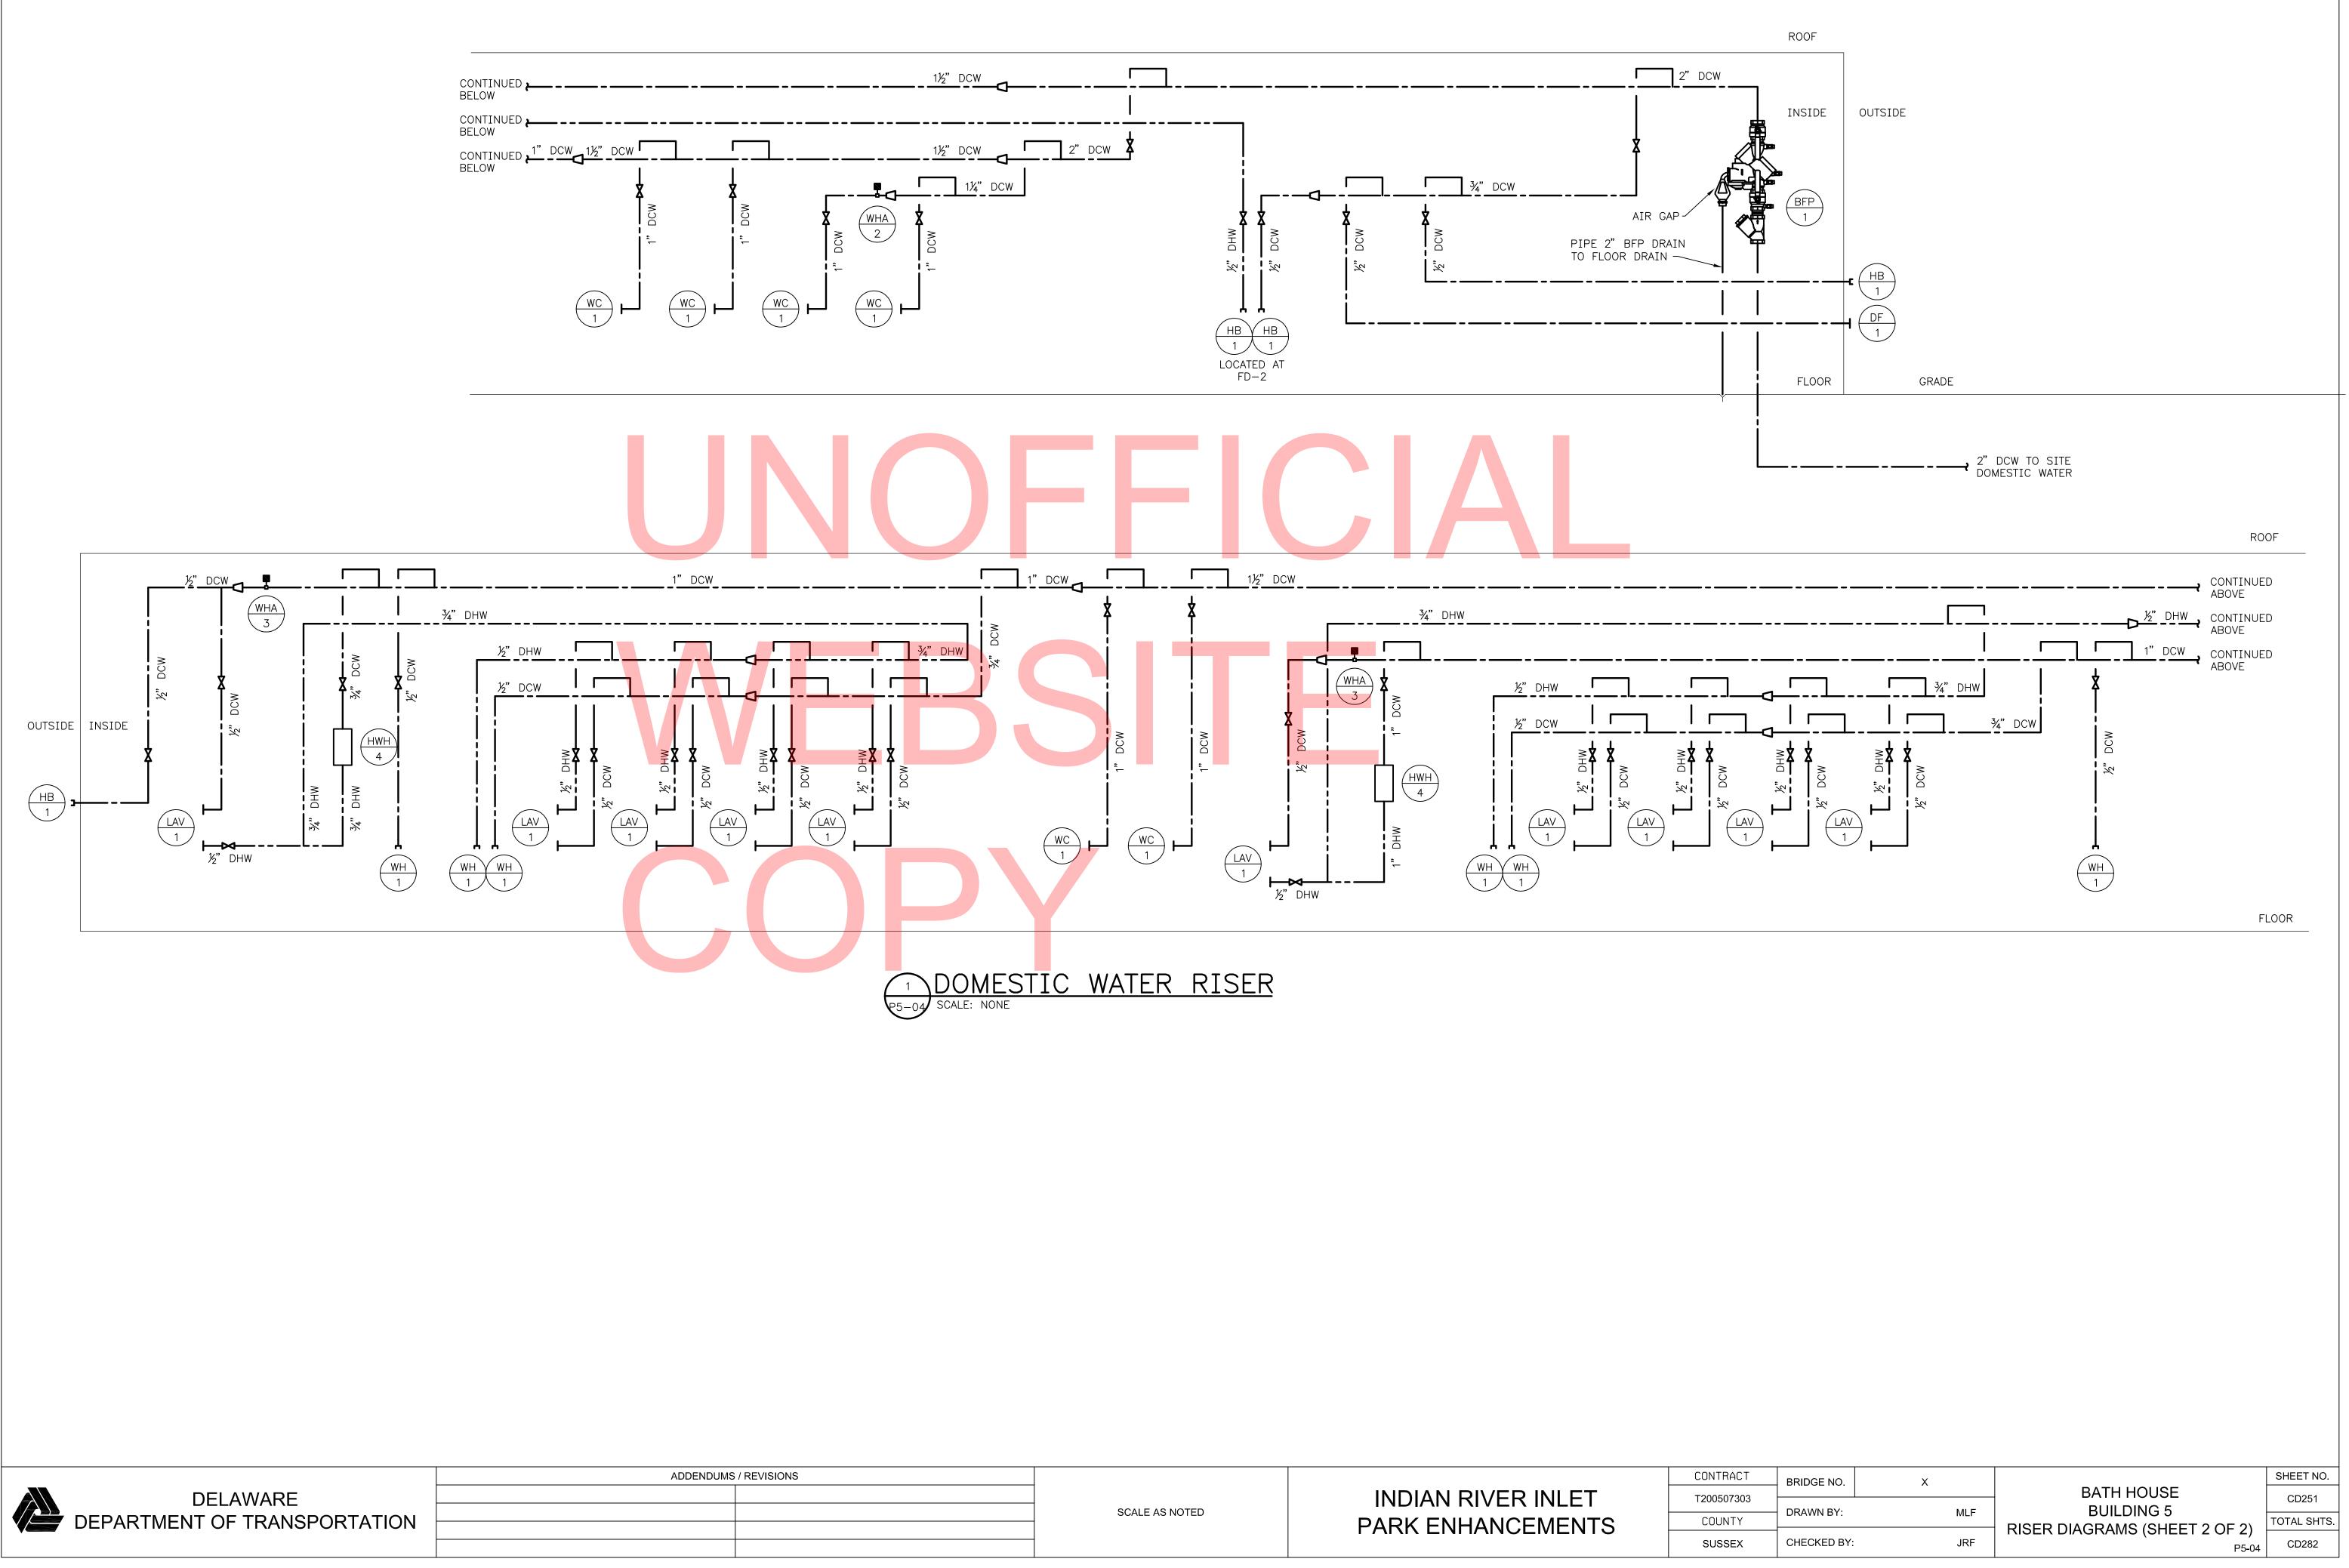

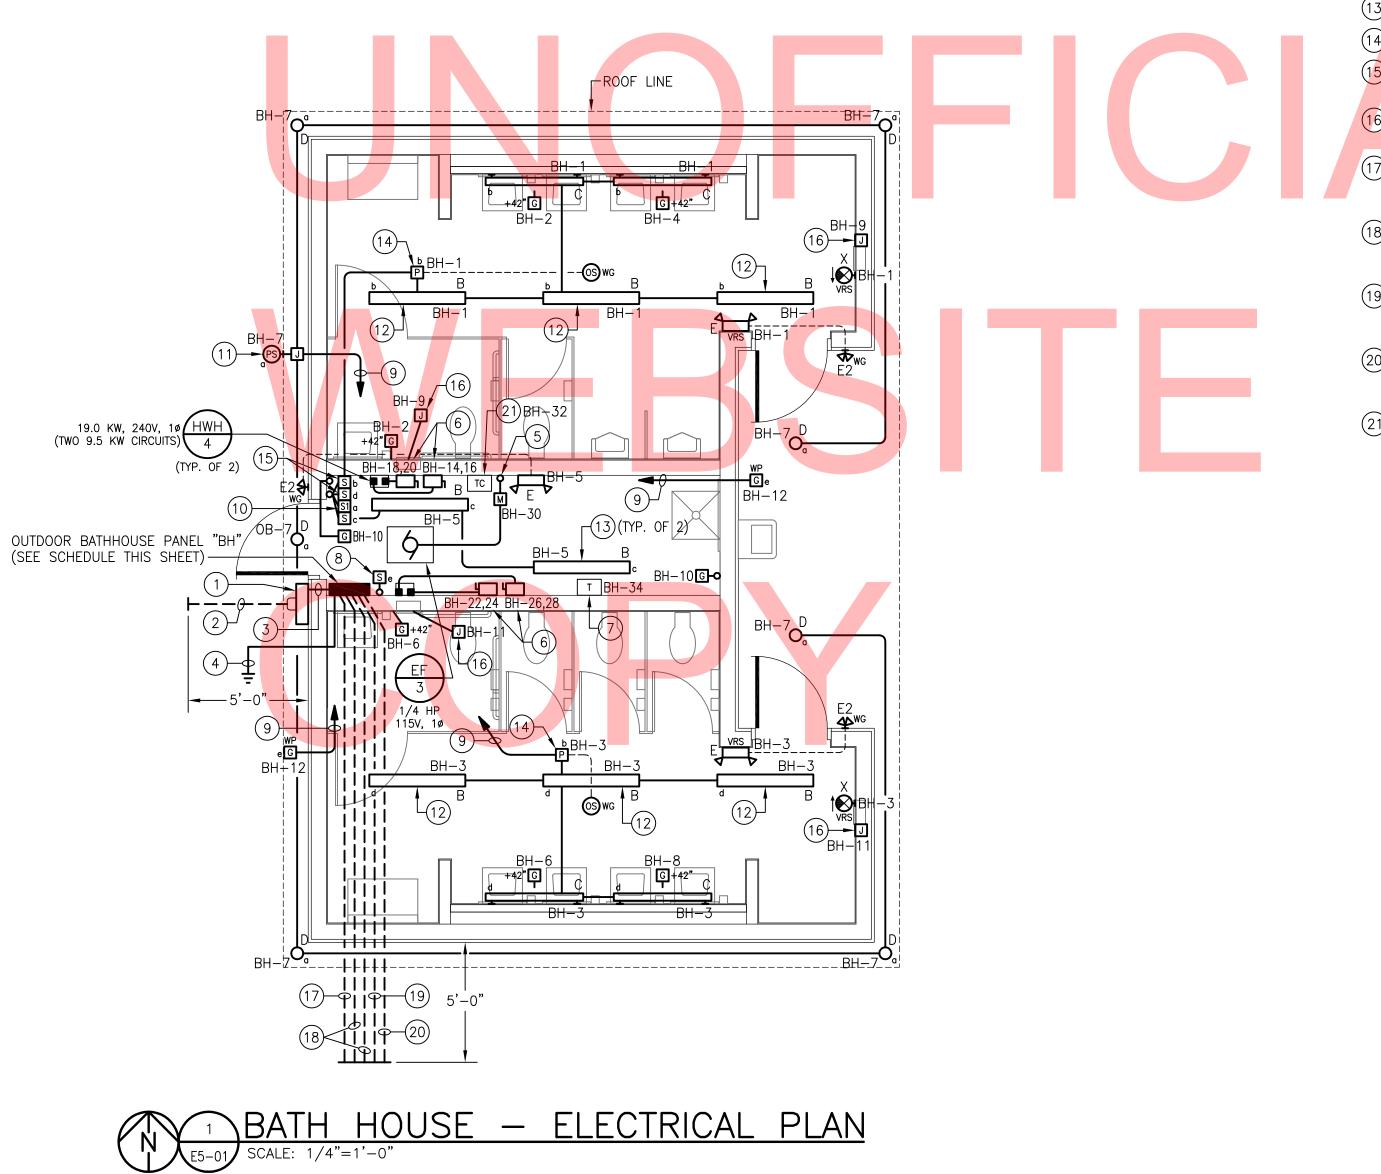

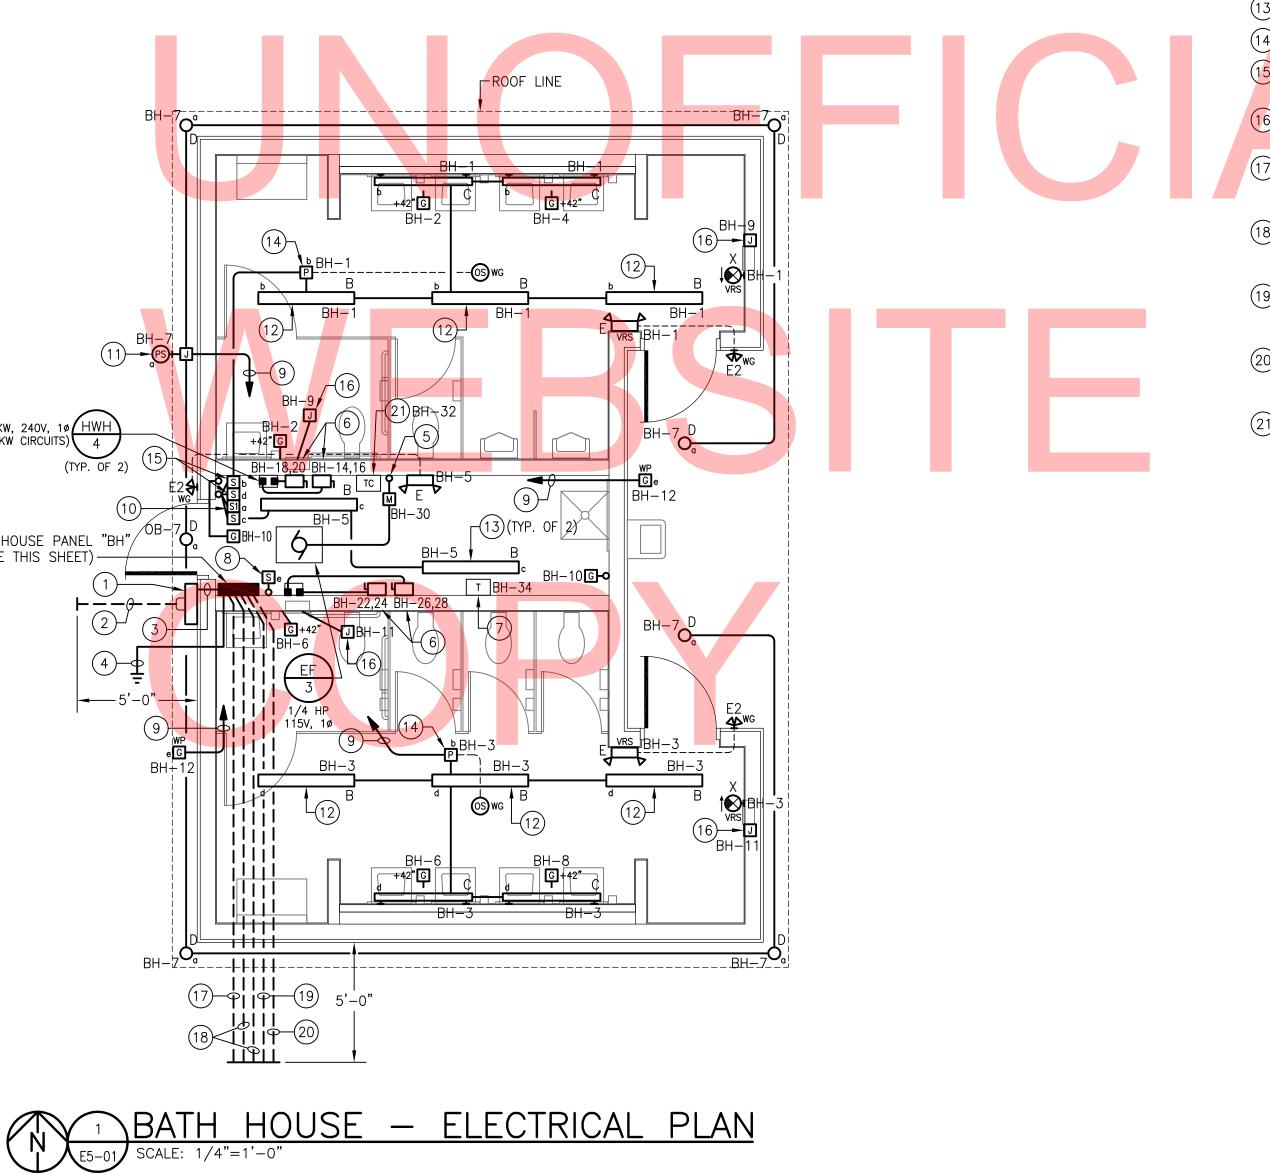



ADDENDUMS / REVISIONS

<u>St</u>	<u>HEET NOTES</u>
1	400A, 1ø, 3W METER SOCKE
2	(2) EMPTY 3" SCHEDULE 80 OTHERS). TOP OF CONDUITS BELOW FINISHED GRADE ("CA
3	(2) SETS OF 2"C: 3#3/0.
4	SEE DIAGRAM 3/E0-02 FOR
5	SEE EXHAUST FAN WIRING DI
6	ENCLOSED DISCONNECT SWIT SQUARE D CLASS 3110 "MD
7)	CONTROL POWER TRANSFORM ELECTRICAL CONTRACTOR. <u>NC</u>
8	MASTER SWITCH CONTROL FO
9	TO TOGGLE SWITCH BY CHAS
10	EXTERIOR LIGHTING MAINTENA
11	OUTDOOR PHOTOSENSOR FOR ROOF LINE FASCIA ON NORTH
12)	SECURE LIGHTING FIXTURE TO
13)	CHAIN-SUSPEND LIGHTING FI
14	POWER RELAY PACK WITH OC
15	MASTER-OFF SWITCHES FOR
16	JUNCTION BOX FOR HAND DI
17)	EMPTY 2-1/2" SCHEDULE 80 (CONDUCTORS PROVIDED BY TAPE IN BACKFILL 12" BELO
18	EMPTY 1" SCHEDULE 80 PVC TOP OF CONDUIT SHALL BE FINISHED GRADE ("CAUTION -
19	EMPTY 2" SCHEDULE 80 PVC (CONDUCTORS PROVIDED BY TAPE IN BACKFILL 12" BELO
20)	EMPTY 2" SCHEDULE 80 PVC

PANELBOARD "BH" SCHEDULE						
<u>FANLLD</u>		<u>\ L</u>			<u> </u>	
LOCATION:BATH HOUSE TYPE: 240/120V, 1ø, 3W						
SOURCE:UTILITY TRANSFORMER MAIN BREAKER: 400A						
DESCRIPTION	BRKR SIZE	CIR NO	$\mathbf{V}_{\phi} \mathbf{B}_{\phi}$	CIR NO	BRKR SIZE	DESCRIPTION
LTG – MEN'S ROOM	20A	1		2	20A	REC – MEN'S ROOM
LTG – WOMEN'S ROOM	20A	3		4	20A	REC – MEN'S ROOM
LTG – CHASE	20A	5		6	20A	REC – WOMEN'S ROOM
LTG – EXTERIOR	20A	7		8	20A	REC – WOMEN'S ROOM
HAND DRYERS (MEN'S)	20A	9		10	20A	REC – CHASE
HAND DRYERS (WOMEN'S)	20A	11		12	20A	REC – EXTERIOR
SPARE	20A	13		14	50A	INSTANTANEOUS WTR. HTR.
SPARE	20A	15		16	SUA	(MEN'S) – CIRC. #1
SPARE	20A	17		18	50A	INSTANTANEOUS WTR. HTR.
SPARE	20A	19		20	JUA	(MEN'S) – CIRC. #2
SPARE	20A	21		22	50A	INSTANTANEOUS WTR. HTR.
SPARE	20A	23		24	JUA	(WOMEN'S) - CIRC. #1
PREPARED SPACE	1	25	┥┥	26	50A	INSTANTANEOUS WTR. HTR.
PREPARED SPACE	-	27		28	JUA	(WOMEN'S) – CIRC. #2
PREPARED SPACE		29		30	15A	EXHAUST FAN
(RESERVED FOR PAVILION #4 LTG.)	20A	31		32	15A	EXH. FAN TIME CLOCK CONTROL
(RESERVED FOR PAVILION #4 REC'S.)	20A	33		34	20A	CONTROL POWER XFMR
(RESERVED FOR POST MTD. REC'S.)	20A	35		36	20A	SPARE
(RESERVED FOR POST MTD. REC'S.)	20A	37		38	20A	SPARE
(RESERVED FOR SITE LTG.)	20A	39		40	60A	(RESERVED FOR FEEDER TO
(RESERVED FOR SITE LTG.)	20A	41		42		ADMIN. CONTACT STATION)
PANEL NOTES:						
1. PANELBOARD ASSEMBLY SHALL BE SUITABLE FOR USE AS SERVICE EQUIPMENT.						
2. UL SHORT CIRCUIT CURRENT RATING OF PANELBOARD AND UL INTERRUPT RATINGS OF ALL CIRCUIT BREAKERS WITHIN PANELBOARD SHALL BE COORDINATED WITH						

INDIAN RIVER INLET PARK ENHANCEMENTS

KET PER UTILITY REQUIREMENTS (METER PROVIDED BY ELECTRIC UTILITY).

PVC UNDERGROUND CONDUIT STUB-OUTS WITH PULL STRINGS FOR ELECTRICAL SERVICE TO BUILDING (CONDUCTORS PROVIDED BY SHALL BE BURIED MINIMUM 36" BELOW FINISHED GRADE. PROVIDE CONTINUOUS DETECTABLE RED WARNING TAPE IN BACKFILL 12" AUTION – BURIED ELECTRIC LINE BELOW").

PANELBOARD GROUNDING AND BONDING DETAILS.

DIAGRAM 2/E0-02.

<u>TCH:</u> 60A/3P, 600V IN NEMA 4X POLYCARBONATE ENCLOSURE WITH ROTARY HANDLE PADLOCKABLE IN "OFF" POSITION (PROVIDE D" SERIES OR APPROVED EQUAL).

RMER (TRANSFORMER & LOW VOLTAGE CONTROL WIRING PROVIDED BY CONTROLS CONTRACTOR). PRIMARY CIRCUIT TO BE PROVIDED BY IOTE: TRANSFORMER TO BE PROVIDED WITH FACTORY-INSTALLED PRIMARY AND SECONDARY FUSE BLOCKS WITH FUSES AS REQUIRED. FOR EXTERIOR RECEPTACLE OUTLETS (PROVIDE LABEL).

ASE ENTRY DOOR.

VANCE SWITCH (PROVIDE LABEL). SEE EXTERIOR LIGHTING CONTROL WIRING DIAGRAM 1/E0-02.

OR CONTROL OF EXTERIOR LIGHTING FIXTURES (SEE EXTERIOR LIGHTING CONTROL WIRING DIAGRAM 1/E0-02 FOR DETAILS). MOUNT TO RTH SIDE OF BUILDING.

TO UNDERSIDE OF ROOF JOISTS.

FIXTURE 8'-0" A.F.F. EXACT LOCATION TO BE FIELD-COORDINATED WITH MECHANICAL PIPING & DUCTWORK (TYP. OF 2.

OCCUPANCY SENSORS FOR CONTROL OF BATHROOM LIGHTING FIXTURES. CONNECT PER MANUFACTURER'S WIRING INSTRUCTIONS. MEN'S & WOMEN'S ROOM LIGHTING FIXTURES (PROVIDE LABELS). CONNECT PER OCCUPANCY SENSOR MANUFACTURER'S WIRING

DRYER (510W, 120V, 10). FIELD-COORDINATE EXACT LOCATION AND PROVIDE ALL CIRCUITING TO HAND DRYER AS REQUIRED PER DRYER ION INSTRUCTIONS.

80 PVC UNDERGROUND CONDUIT STUB-OUT WITH PULL STRING FOR ELECTRICAL FEEDER TO ADMINISTRATION CONTACT STATION OTHERS). TOP OF CONDUIT SHALL BE BURIED MINIMUM 36" BELOW FINISHED GRADE. PROVIDE CONTINUOUS DETECTABLE RED WARNING OW FINISHED GRADE ("CAUTION – BURIED ELECTRIC LINE BELOW").

C UNDERGROUND CONDUIT STUB-OUT WITH PULL STRING FOR SITE LIGHTING BRANCH CIRCUIT (CONDUCTORS PROVIDED BY OTHERS). BURIED MINIMUM 36" BELOW FINISHED GRADE. PROVIDE CONTINUOUS DETECTABLE RED WARNING TAPE IN BACKFILL 12" BELOW - BURIED ELECTRIC LINE BELOW").

C UNDERGROUND CONDUIT STUB-OUT WITH PULL STRING FOR PAVILION #4 LIGHTING & RECEPTACLE BRANCH CIRCUIT(S) AS REQUIRED OTHERS). TOP OF CONDUIT SHALL BE BURIED MINIMUM 36" BELOW FINISHED GRADE. PROVIDE CONTINUOUS DETECTABLE RED WARNING OW FINISHED GRADE ("CAUTION - BURIED ELECTRIC LINE BELOW").

/C UNDERGROUND CONDUIT STUB-OUT WITH PULL STRING FOR POST-MOUNTED GFCI RECEPTACLE BRANCH CIRCUIT(S) AS REQUIRED (CONDUCTORS PROVIDED BY OTHERS). TOP OF CONDUIT SHALL BE BURIED MINIMUM 36" BELOW FINISHED GRADE. PROVIDE CONTINUOUS DETECTABLE RED WARNING TAPE IN BACKFILL 12" BELOW FINISHED GRADE ("CAUTION – BURIED ELECTRIC LINE BELOW").

(21) TIME CLOCK CONTROL FOR EXHAUST FAN EF/3 (TIME CLOCK & CONTROL WIRING TO EXHAUST FAN PROVIDED BY CONTROLS CONTRACTOR). POWER SUPPLY CIRCUIT TO BE PROVIDED BY ELECTRICAL CONTRACTOR.

AVAILABLE FAULT CURRENT AT PANELBOARD PRIOR TO PURCHASING EQUIPMENT. COORDINATE WITH ELECTRIC UTILITY AND SITE ENGINEER.


ALL CIRCUIT BREAKERS WITHIN PANELBOARD SHALL BE HACR RATED.

CONTRACT	BRIDGE NO.	Х	
T000507000			
T200507303			
COUNTY	DRAWN BY:	AHH	
SUSSEX	CHECKED BY:	JRF	


BATH HOUSE
<b>BUILDING 5</b>
ELECTRICAL PLAN

SHEET NO. CD252 TOTAL SHTS. CD282

E5-01

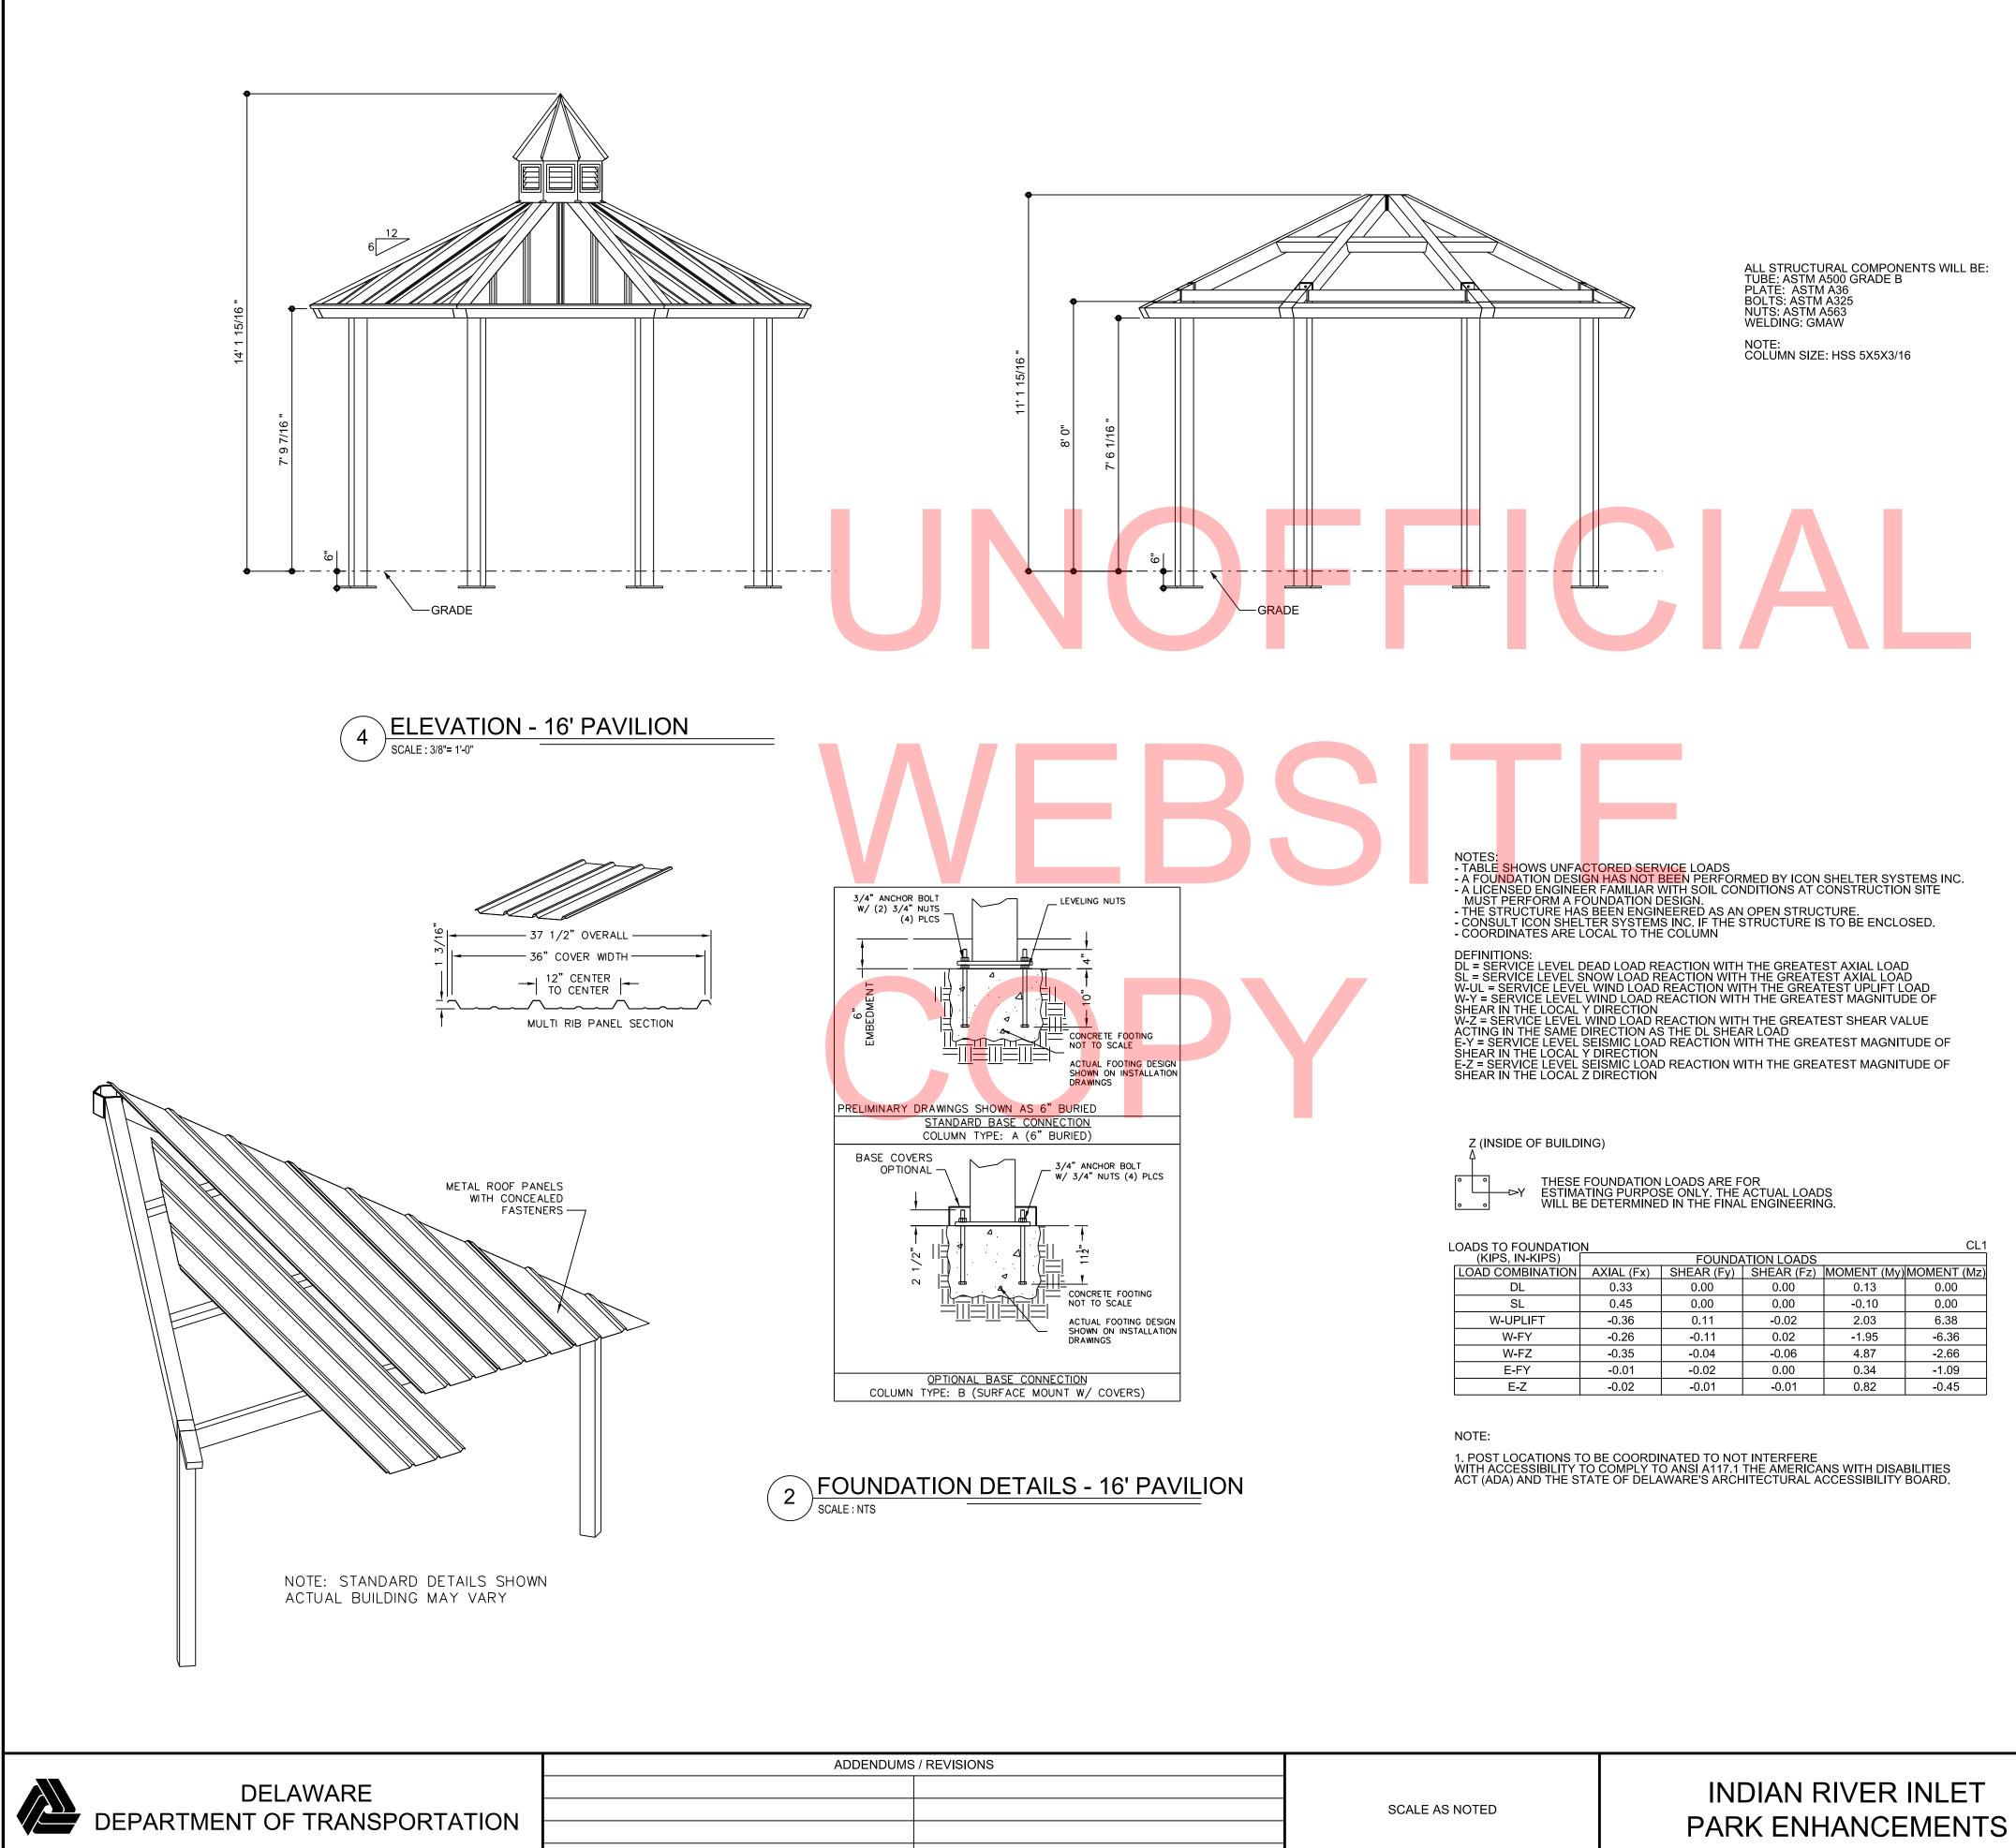

FOUNDATION LOADS				
AXIAL (Fx)	SHEAR (Fy)	SHEAR (Fz)	MOMENT (My)	MOMENT (Mz)
0.33	0.00	0.00	0.13	0.00
0.45	0.00	0.00	-0.10	0.00
-0.36	0.11	-0.02	2.03	6.38
-0.26	-0.11	0.02	-1.95	-6.36
-0.35	-0.04	-0.06	4.87	-2.66
-0.01	-0.02	0.00	0.34	-1.09
-0.02	-0.01	-0.01	0.82	-0.45
	0.33 0.45 -0.36 -0.26 -0.35 -0.01	AXIAL (Fx)         SHEAR (Fy)           0.33         0.00           0.45         0.00           -0.36         0.11           -0.26         -0.11           -0.35         -0.04           -0.01         -0.02	0.33         0.00         0.00           0.45         0.00         0.00           -0.36         0.11         -0.02           -0.26         -0.11         0.02           -0.35         -0.04         -0.06           -0.01         -0.02         0.00	AXIAL (Fx)         SHEAR (Fy)         SHEAR (Fz)         MOMENT (My)           0.33         0.00         0.00         0.13           0.45         0.00         0.00         -0.10           -0.36         0.11         -0.02         2.03           -0.26         -0.11         0.02         -1.95           -0.35         -0.04         -0.06         4.87           -0.01         -0.02         0.00         0.34

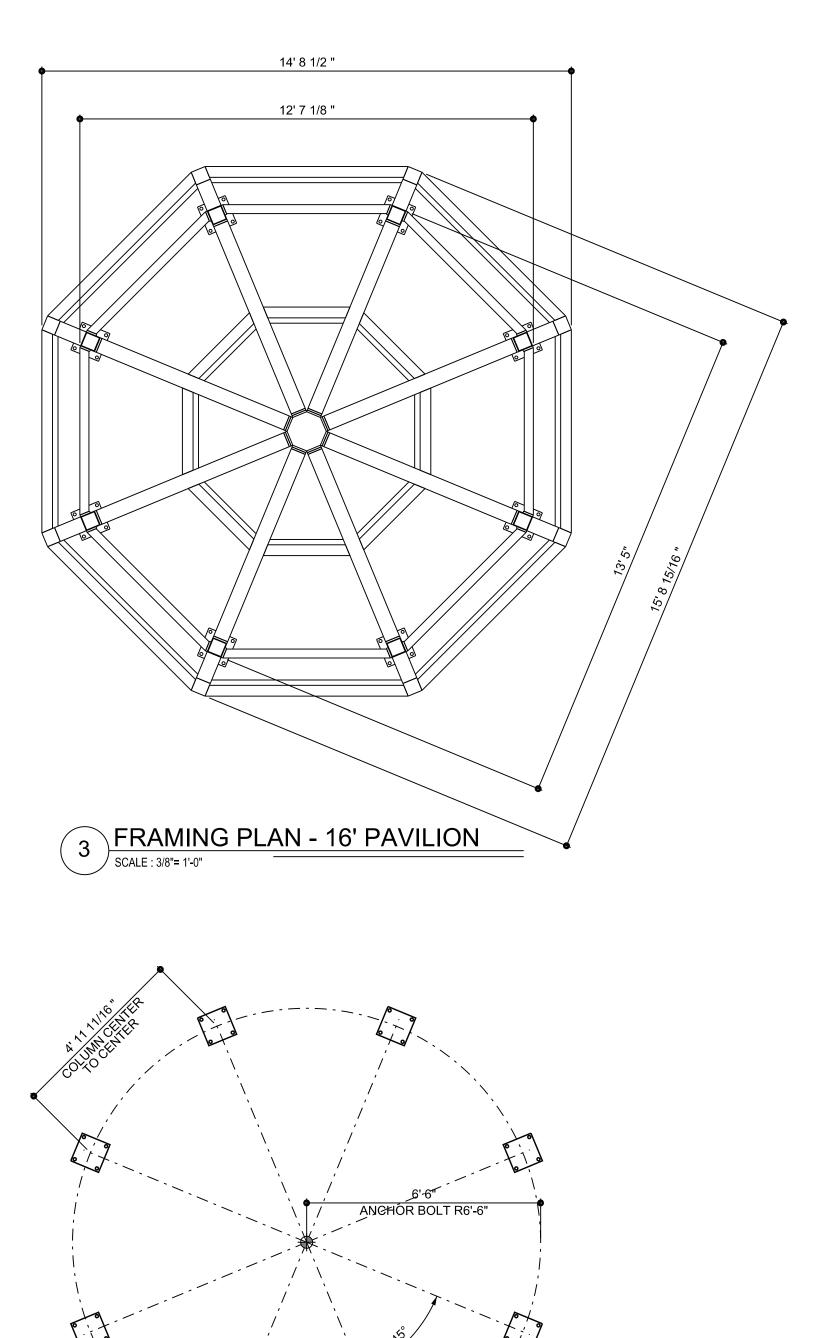

SCALE AS NOTED	

1


### FOUNDATION PLAN - 16' PAVILION / SCALE : 3/8"= 1'-0"

🕀 7B F.F.E. = 9.12 🕀 7C F.F.E. = 6.98

🕀 7D F.F.E. = 5.92

- - - -


CONTRACT	BRIDGE NO.	x			SHEET NO.
T200507303			16' SHADE PAVILION -		CD253
COUNTY	DRAWN BY:	JAA	BUILDING 7B, 7C, 7D		TOTAL SHTS.
SUSSEX	CHECKED BY:	WJS		A7-01	282

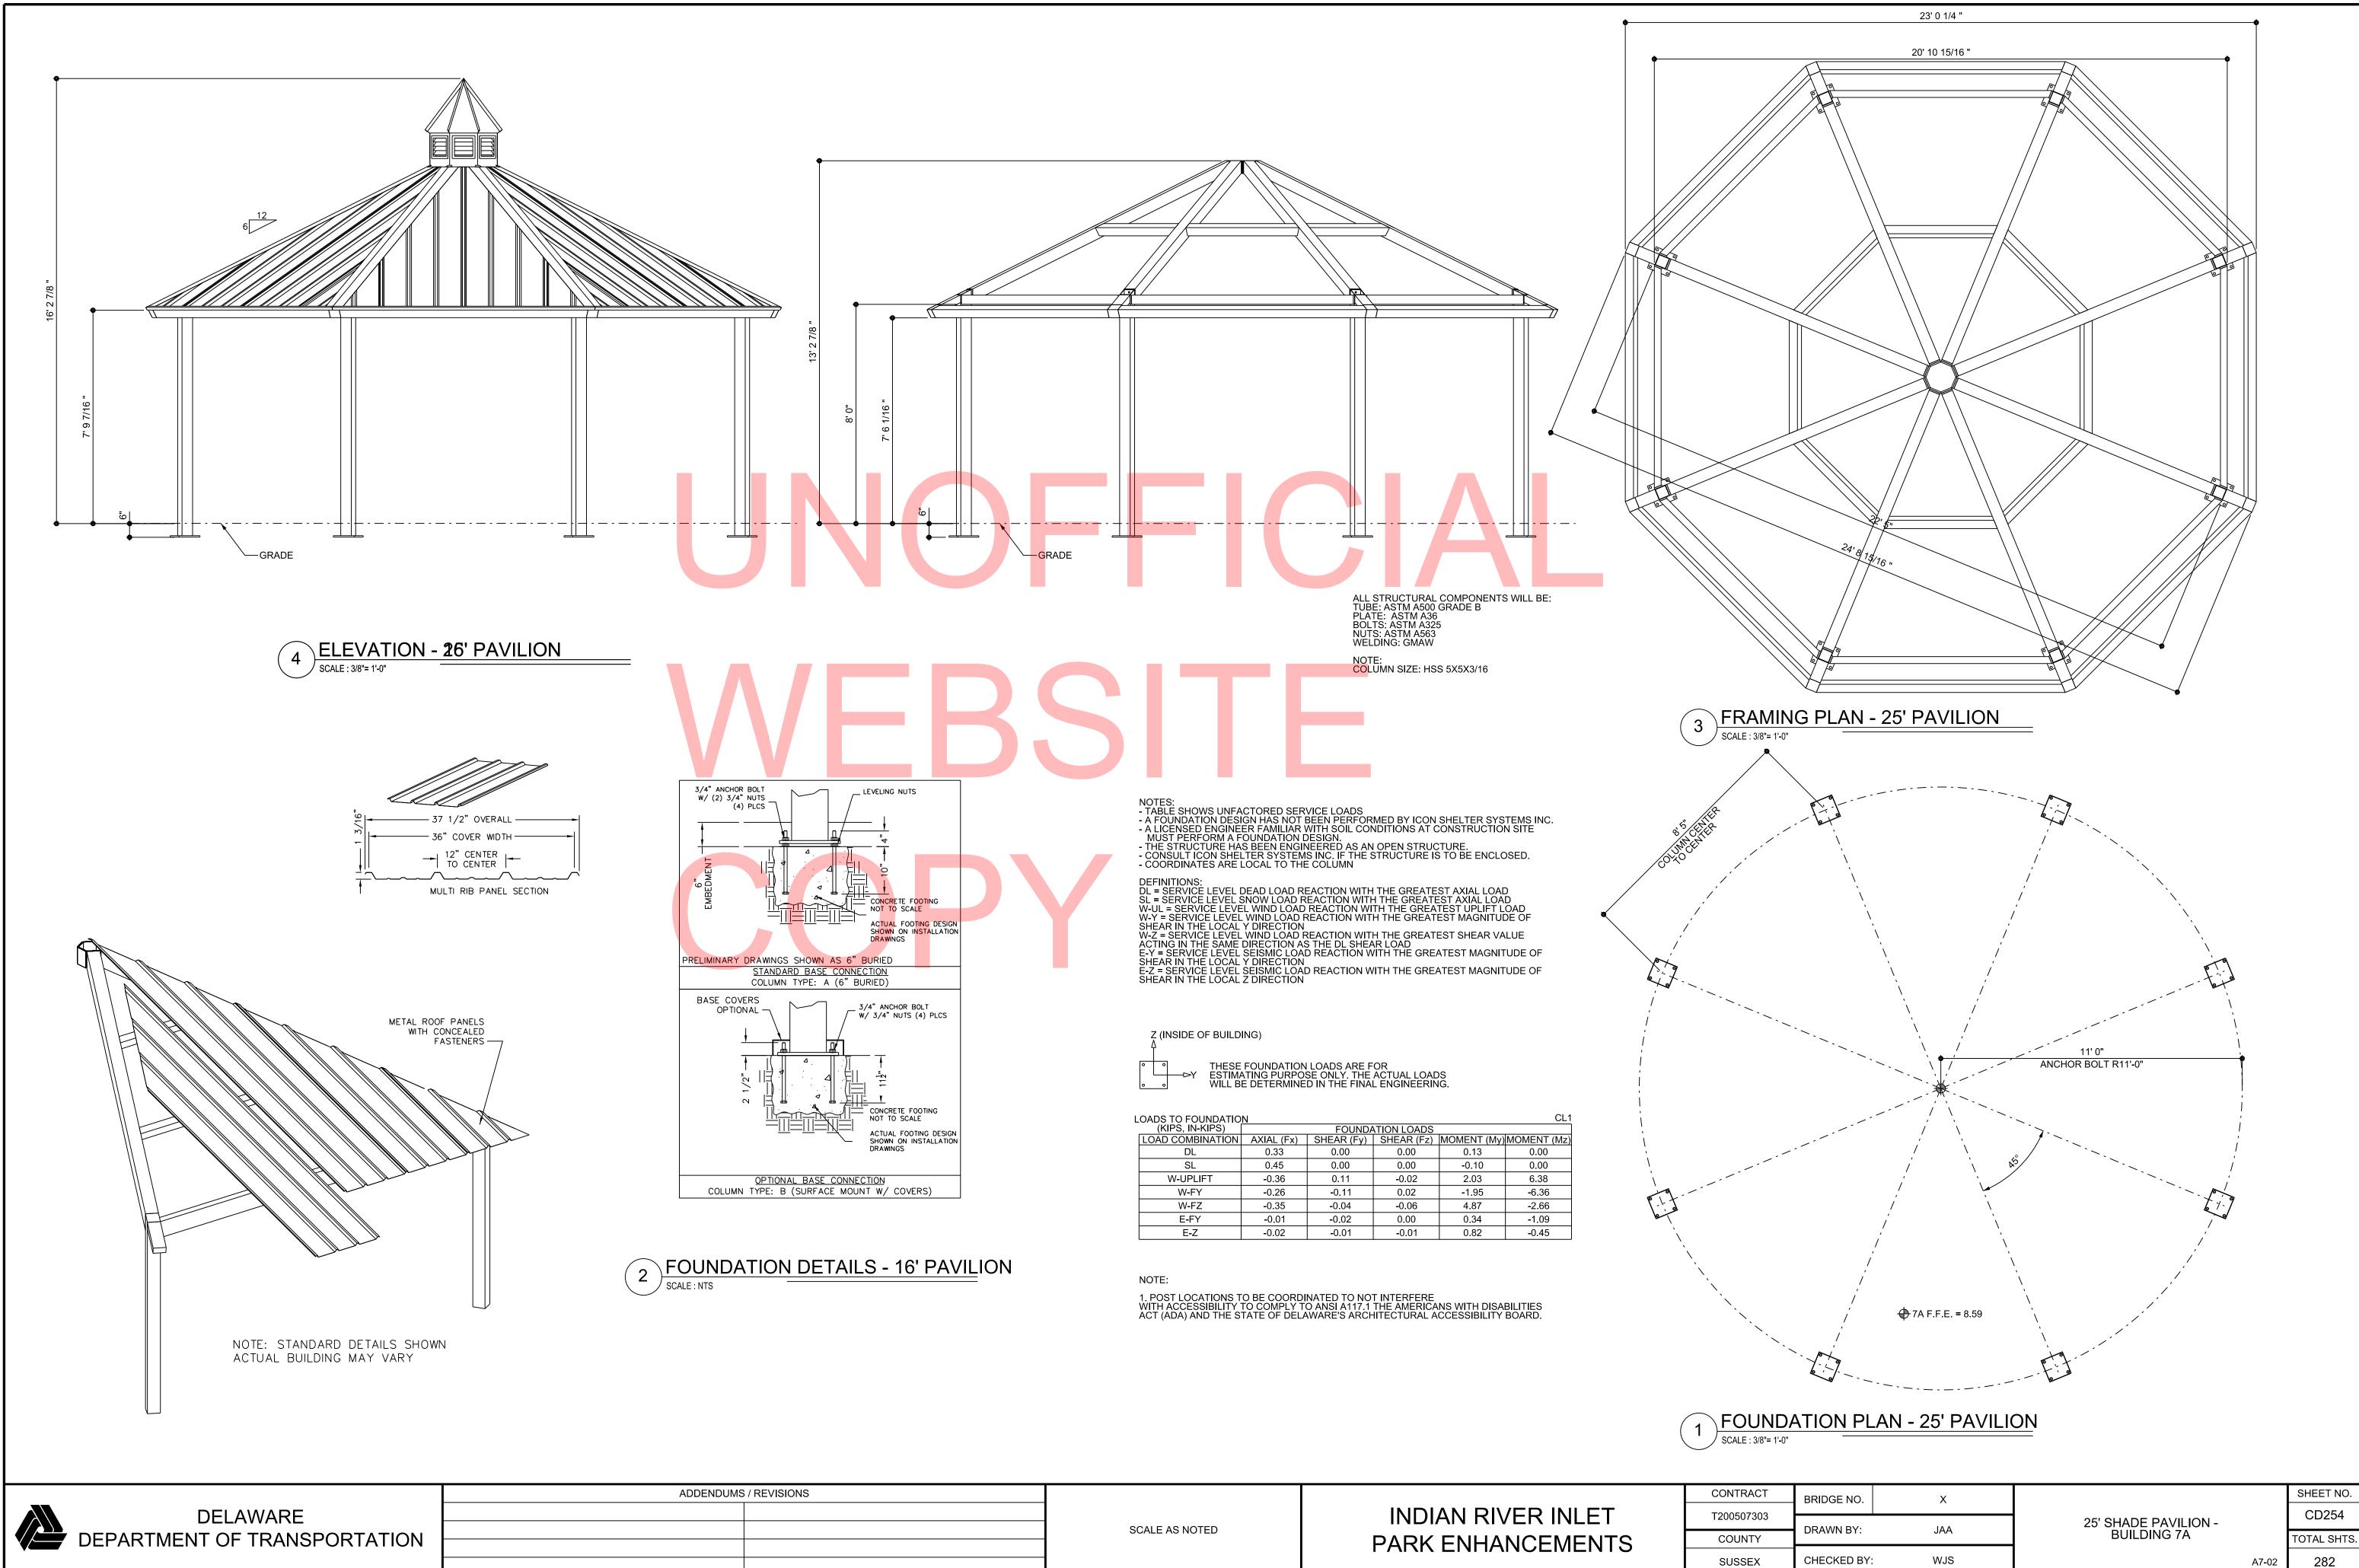

(KIPS, IN-KIPS)		FOUNDA	TION LOADS		
LOAD COMBINATION	AXIAL (Fx)	SHEAR (Fy)	SHEAR (Fz)	MOMENT (My)	MOMENT (Mz)
DL	0.33	0.00	0.00	0.13	0.00
SL	0.45	0.00	0.00	-0.10	0.00
W-UPLIFT	-0.36	0.11	-0.02	2.03	6.38
W-FY	-0.26	-0.11	0.02	-1.95	-6.36
W-FZ	-0.35	-0.04	-0.06	4.87	-2.66
E-FY	-0.01	-0.02	0.00	0.34	-1.09
E-Z	-0.02	-0.01	-0.01	0.82	-0.45

WJS CHECKED BY:

282

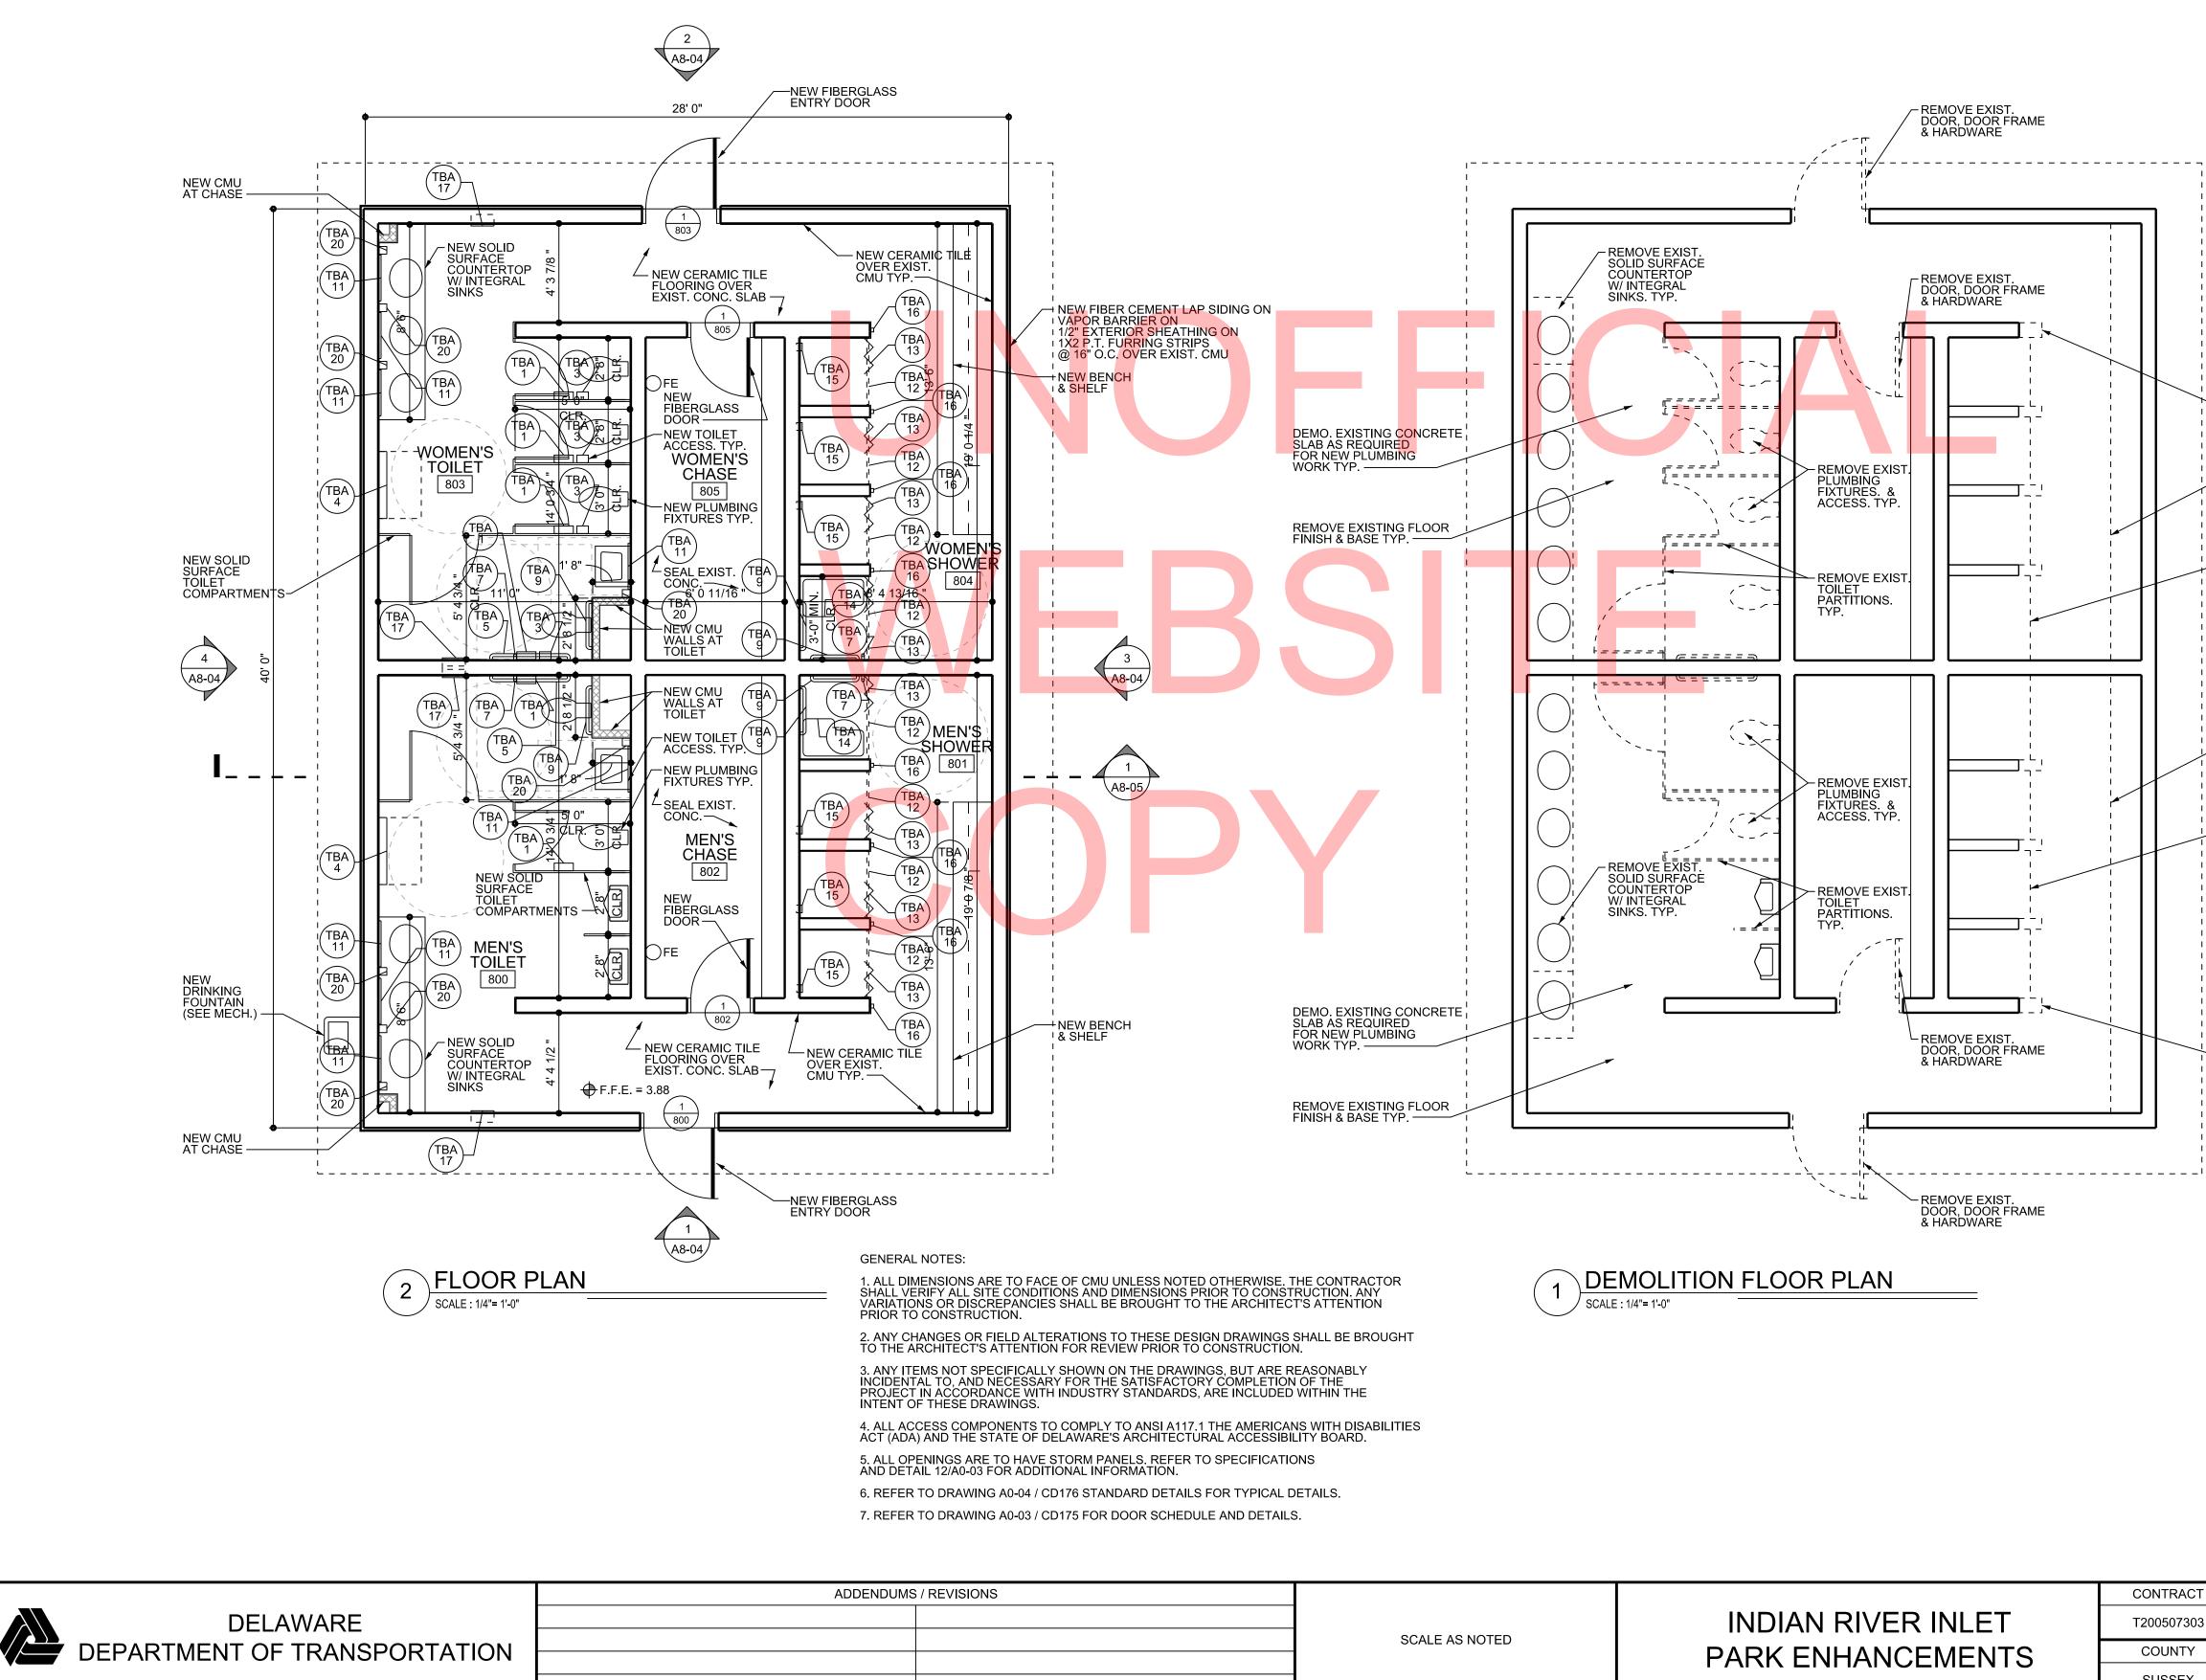

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- REMOVE 1'-0" OF EXIST. CMU WALL. TYP. AT ALL SHOWER STALLS.	

REMOVE EXIST. BENCH & SHELVING ABOVE

- REMOVE EXIST. SHOWER CURTAIN, CURTAIN ROD & SHOWER ACCESS. TYP. ALL SHOWER STALLS.

- REMOVE EXIST. BENCH & SHELVING ABOVE

- REMOVE EXIST. SHOWER CURTAIN, CURTAIN ROD & SHOWER ACCESS. TYP. ALL SHOWER STALLS.

- REMOVE 1'-0" OF EXIST. CMU WALL. TYP. AT ALL SHOWER STALLS.


ACCESSORIES LEGEND:  $\binom{\mathsf{TBA}}{1}$  TOILET TISSUE DISPENSER (TBA) 2 NOT USED  $\binom{\mathsf{TBA}}{3}$ SANITARY NAPKIN DISPOSAL - SURFACE MOUNTED  $\binom{\mathsf{TBA}}{4}$  DIAPER CHANGING STATION  $\binom{\mathsf{TBA}}{5}$  GRAB BAR, 42", STRAIGHT  $\binom{\mathsf{TBA}}{6}$  GRAB BAR, 36", STRAIGHT (TBA) GRAB BAR, 18", STRAIGHT  $\binom{\mathsf{TBA}}{8}$  GRAB BAR, 48", STRAIGHT (TBA) 9 GRAB BAR, 24", STRAIGHT (TBA) 10) GRAB BAR, 16", STRAIGHT  $\binom{\mathsf{TBA}}{11}$  MIRROR UNIT, 24" X 36"  $\begin{pmatrix} TBA \\ 12 \end{pmatrix}$ SHOWER CURTAIN ROD (TBA) SHOWER CURTAIN (TBA) FOLDING SHOWER SEAT (TBA) 15 SOAP DISH (TBA) 16 ROB HOOK  $\binom{\mathsf{TBA}}{\mathsf{17}}$  WARM-AIR HAND DRYER (TBA) 18) UNDERLAVATORY GUARD (TBA) 19) MOP AND BROOM HOLDER (TBA) SOAP DISPENSER

(TBA) CLOTHES HOOK

 $\smile$ 

CONTRACT	BRIDGE NO.	Х		SHEET NO.
200507303			EXIST. SOUTHEAST BATH HOUSE -	CD255
COUNTY	DRAWN BY:	JAA	BUILDING 8 PLANS	TOTAL SHTS.
SUSSEX	CHECKED BY:	WJS	A8-01	282



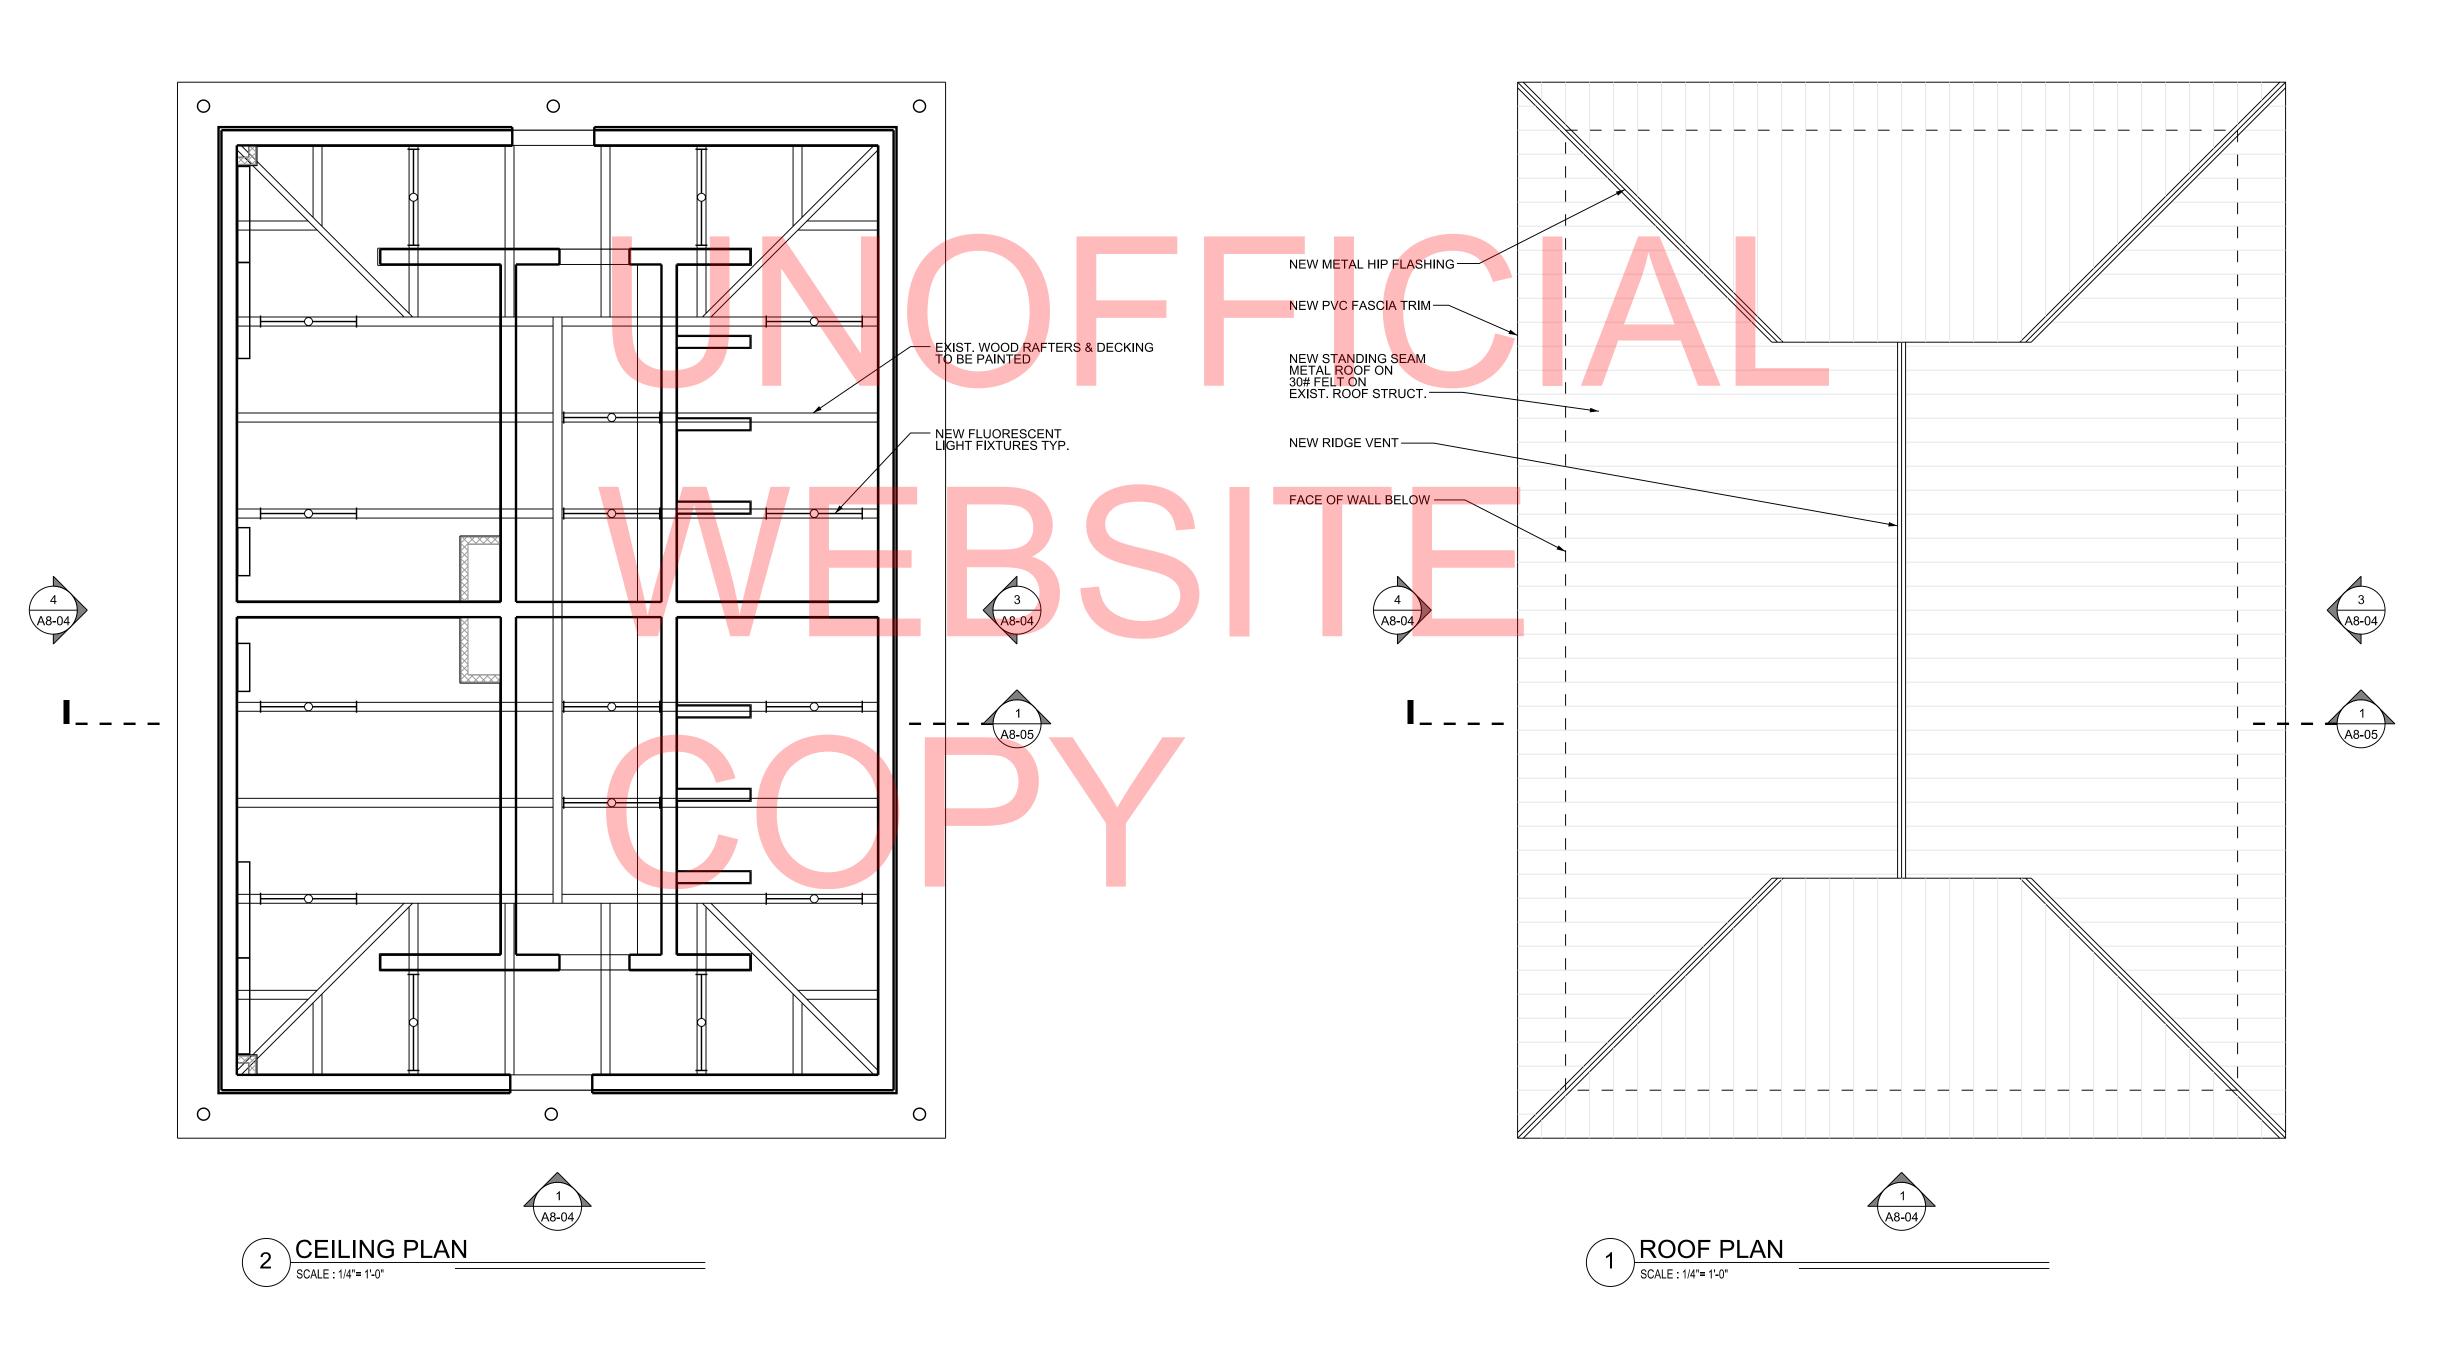


	ADDENDUMS	/ REVISIONS
DELAWARE		
DEPARTMENT OF TRANSPORTATION		
DEPARTIVIENT OF TRAINSPORTATION		



SCALE AS NOTED	INDIAN RIVER INLET PARK ENHANCEMENTS


CONTRACT	BRIDGE NO.	Х		SHEET NO.	
T200507303			EXIST. SOUTHEAST BATH HOUSE -	CD256	
COUNTY	DRAWN BY:	JAA	BUILDING 8 PLANS	TOTAL SHTS.	
SUSSEX	CHECKED BY:	WJS	A8-02	282	

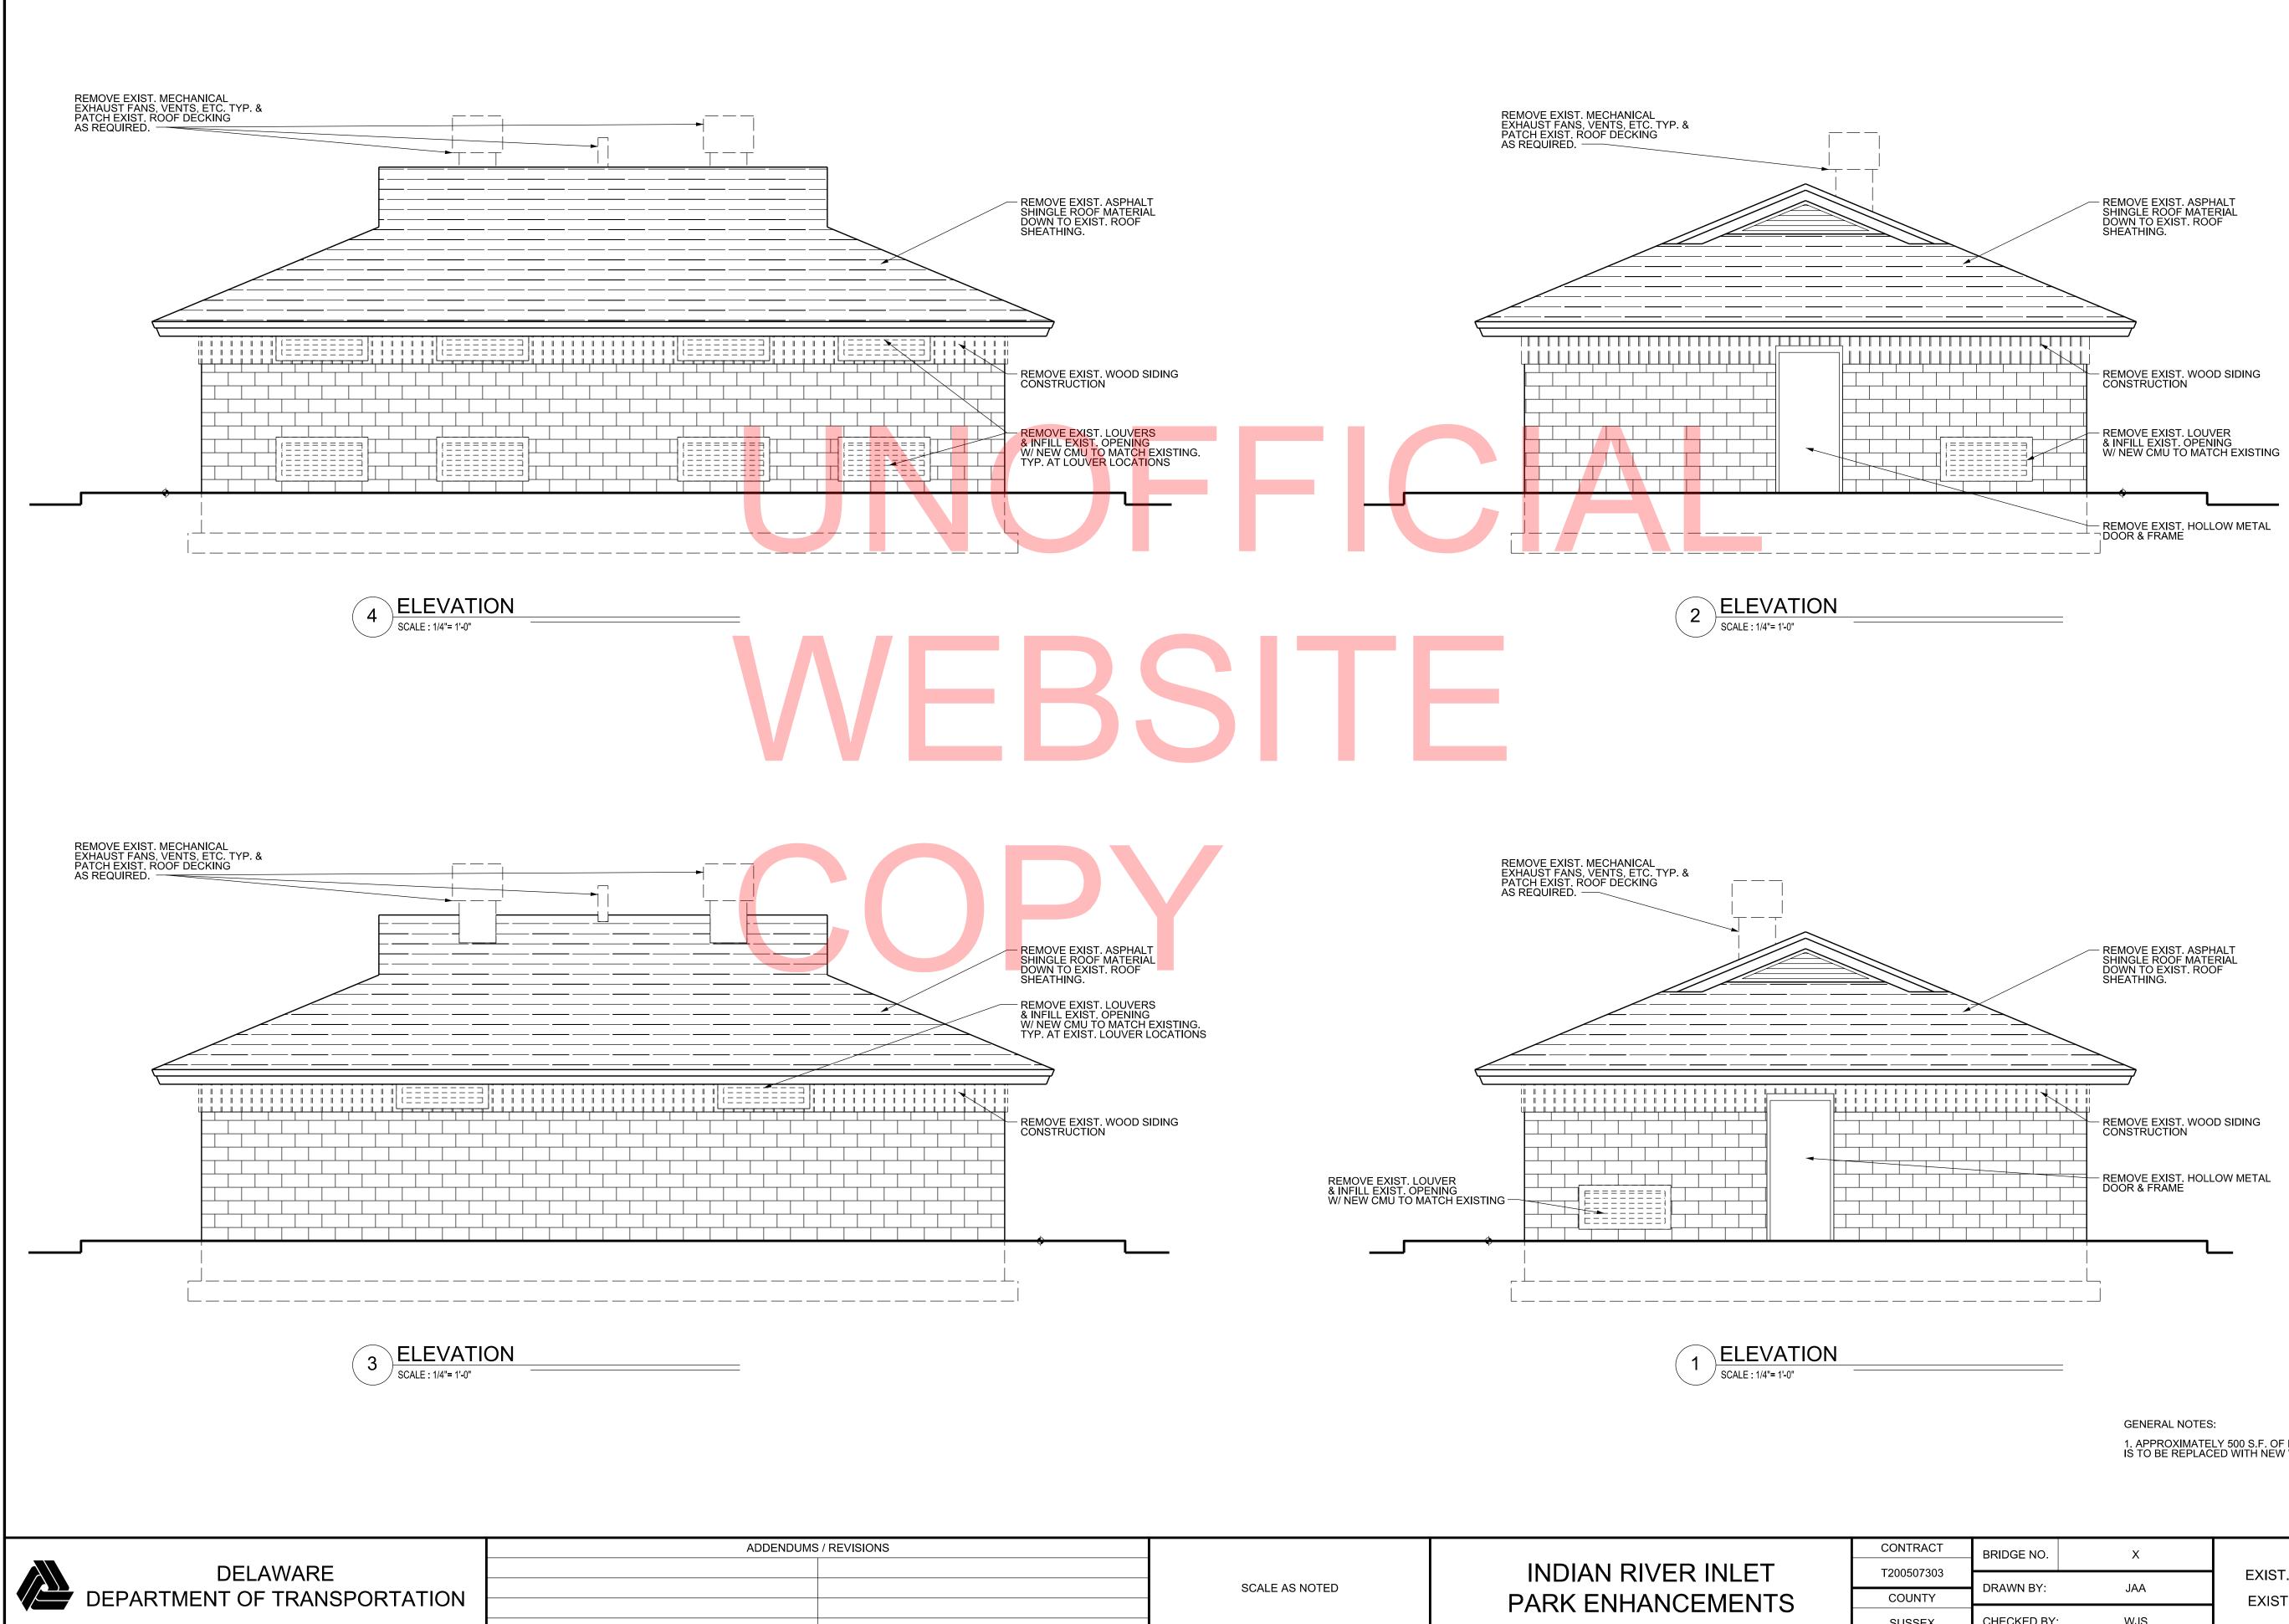

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1. APPROXIMATELY 500 S.F. OF EXISTING DETERIORATED WOOD ROOF DECKING IS TO BE REPLACED WITH NEW WOOD ROOF DECKING TO MATCH EXISTING.


CONTRACT	BRIDGE NO.	Х		SHEET NO.
T200507303			EXIST. SOUTHEAST BATH HOUSE -	CD257
	DRAWN BY:	JAA	BUILDING 8	
COUNTY	Broand Br.	0, 0 (	EXISTING EXTERIOR ELEVATIONS	TOTAL SHTS.
SUSSEX	CHECKED BY:	WJS	A8-03	282

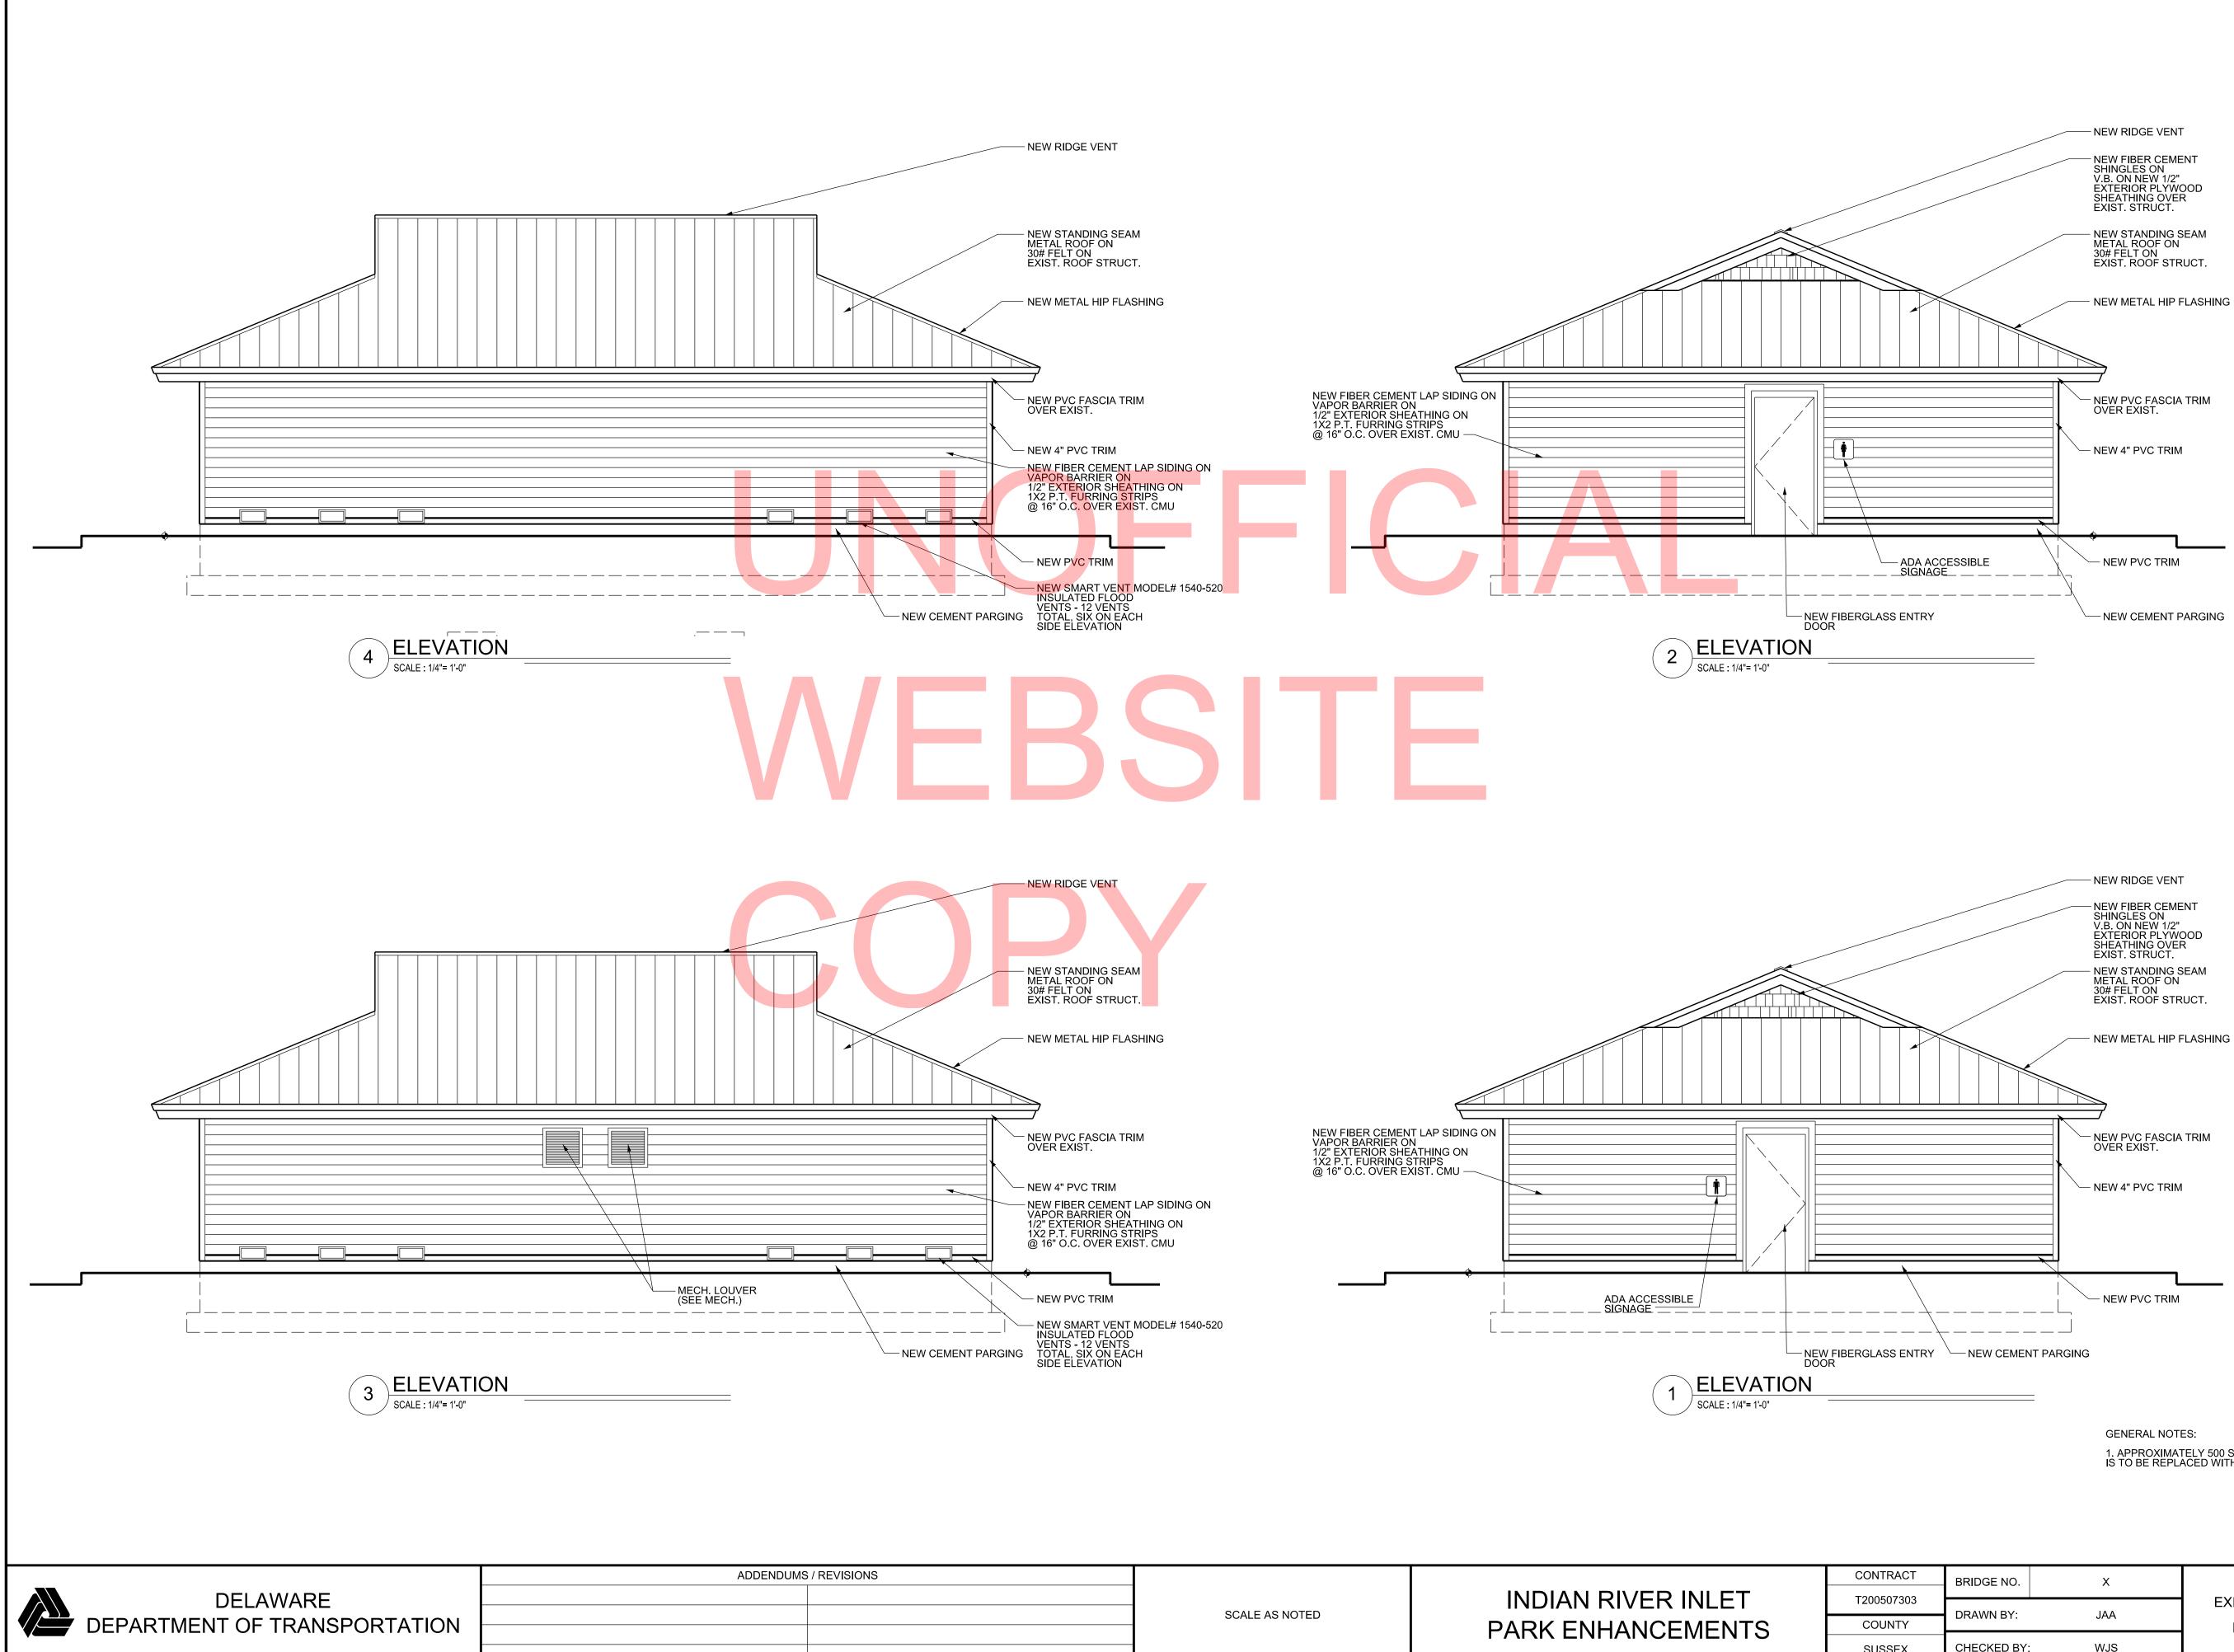


-D	INDIAN RIVER INLET	Т2
ΞD	PARK ENHANCEMENTS	C

1. APPROXIMATELY 500 S.F. OF EXISTING DETERIORATED WOOD ROOF DECKING IS TO BE REPLACED WITH NEW WOOD ROOF DECKING TO MATCH EXISTING.

DRAWN BY: JAA BUILDING 8					
DRAWN BY: JAA BUILDING 8	CONTRACT	BRIDGE NO.	Х		SHEET NO.
	Г200507303				CD258
	COUNTY	DRAWN BY:	JAA	BUILDING 8 NEW EXTERIOR ELEVATIONS	TOTAL SHTS.
SUSSEX CHECKED BY: WJS A8-04 282	SUSSEX	CHECKED BY:	WJS	A8-04	282

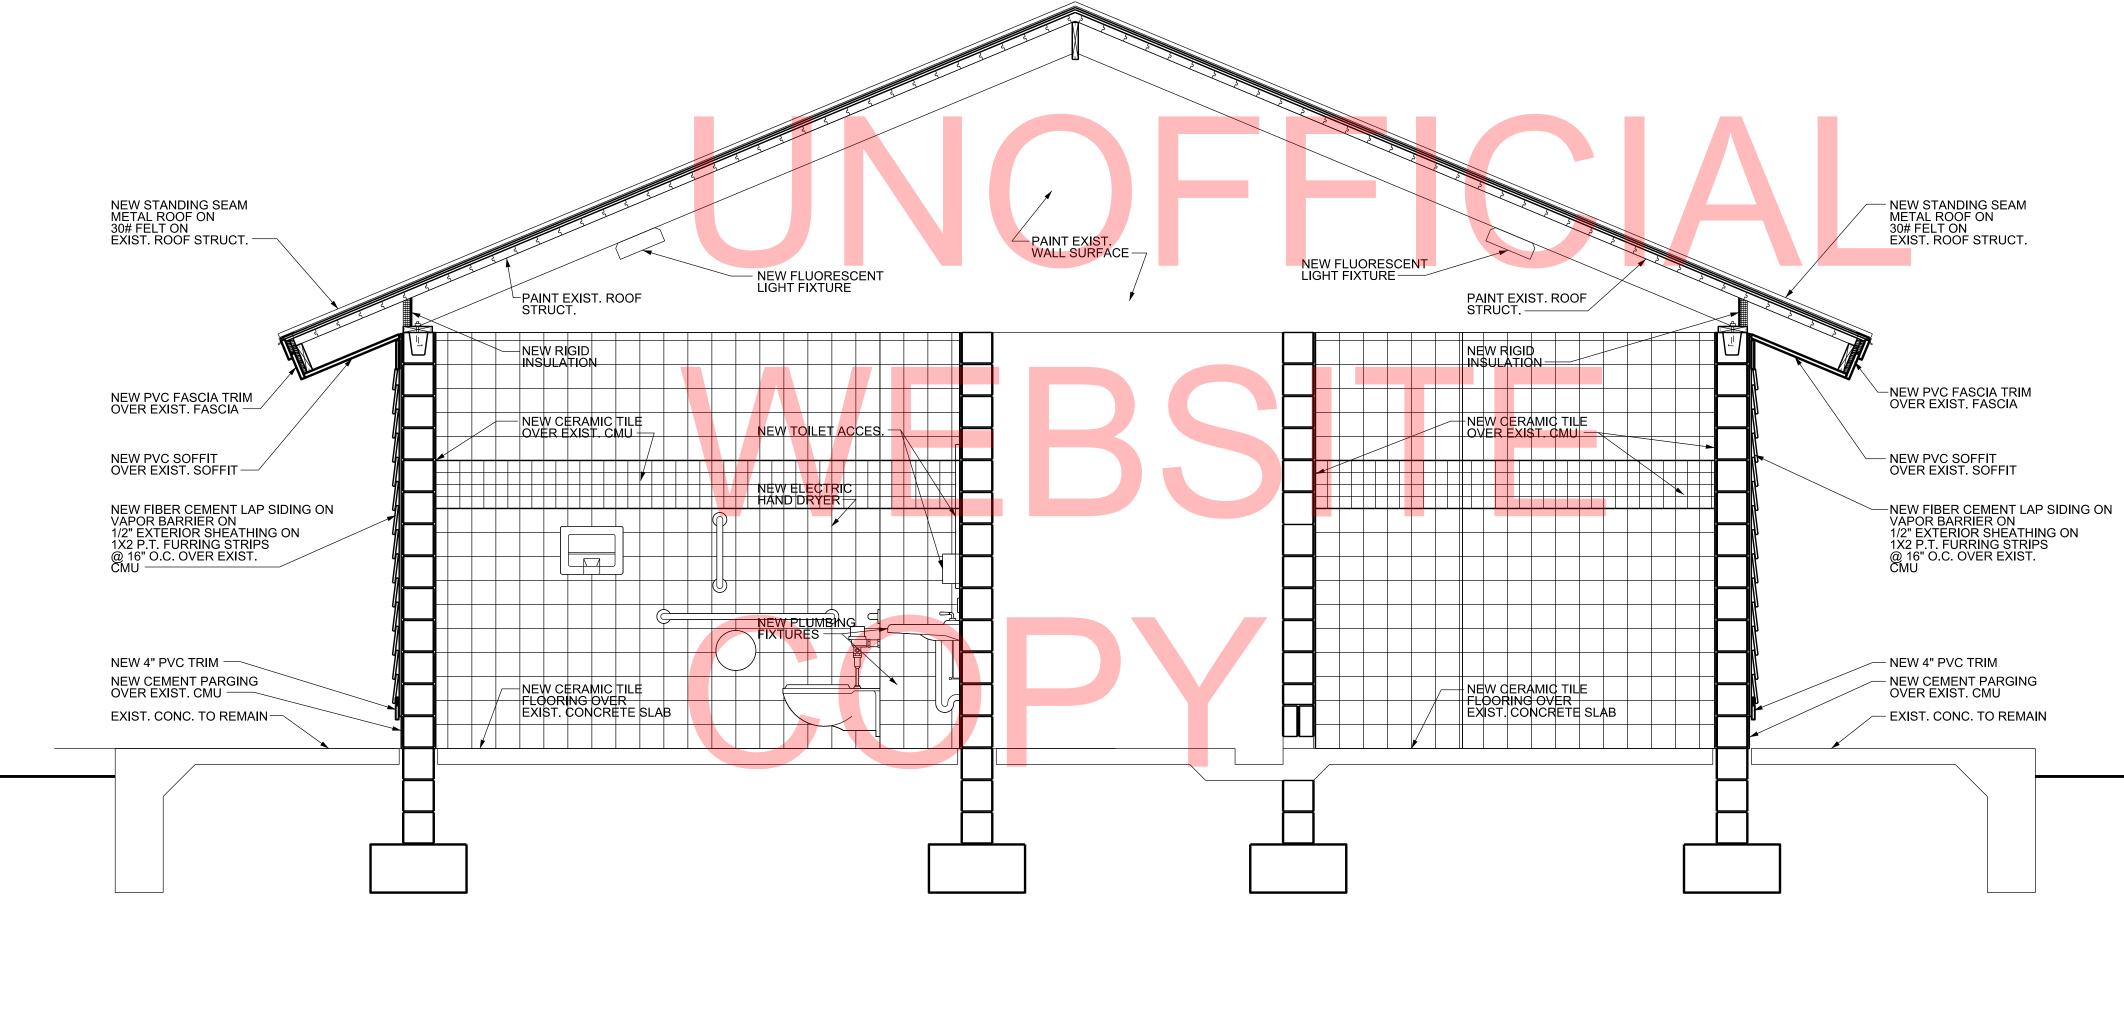


SECTION	
SCALE : 1/2"= 1'-0"	

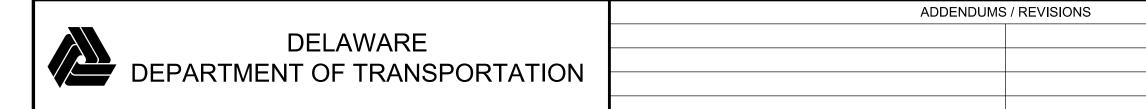

INDIAN RIVER INLET
PARK ENHANCEMENTS

SCALE AS NOTED

ONTRACT	BRIDGE NO.	Х		SHEET NO.
200507303			EXIST. SOUTHEAST BATH HOUSE -	CD259
COUNTY	DRAWN BY:	JAA	BUILDING 8 BUILDING SECTION	TOTAL SHTS
SUSSEX	CHECKED BY:	WJS	A8-05	282

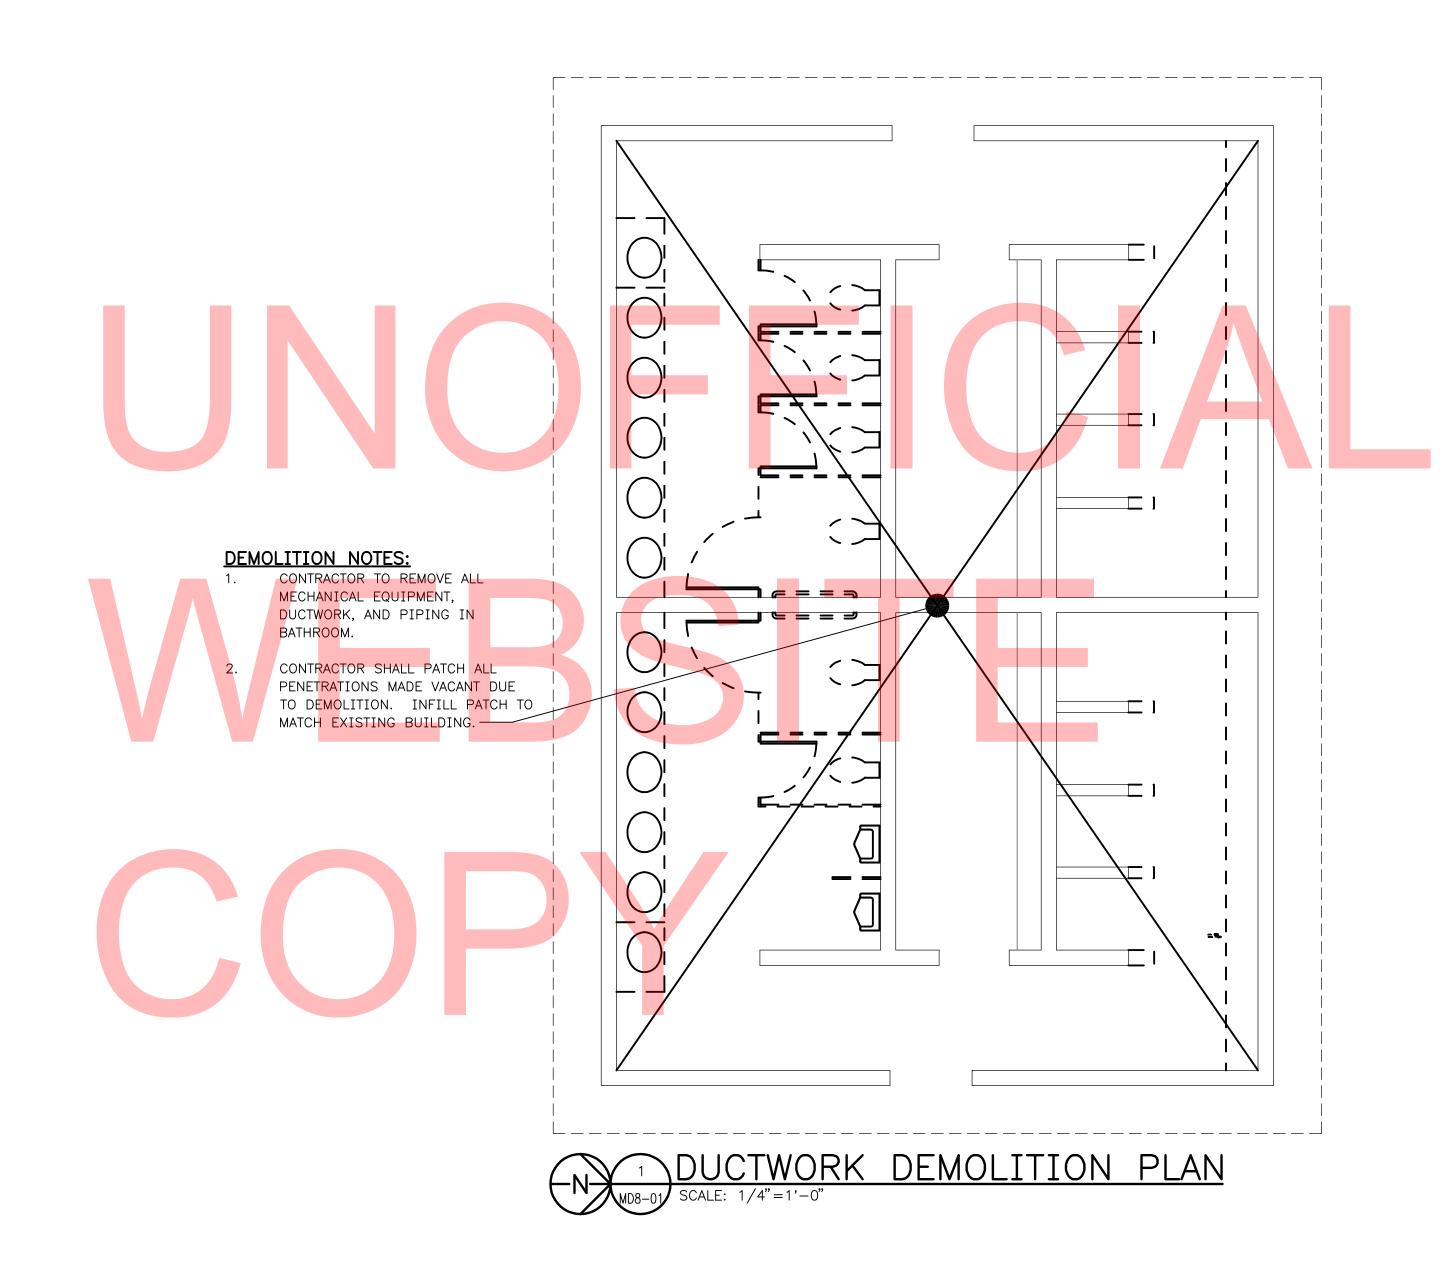



ADDENDUMS / REVISIONS


INDIAN RIVER INLET PARK ENHANCEMENTS CONTRACT T200507303 COUNTY SUSSEX

BRIDGE NO. Х MLF DRAWN BY: CHECKED BY: JRF


EXIST. SOUTHEAST BATH HOUSE **BUILDING 8** MECHANICAL DEMOLITION PLAN MD8-01

SHEET NO. CD260

TOTAL SHTS. CD282

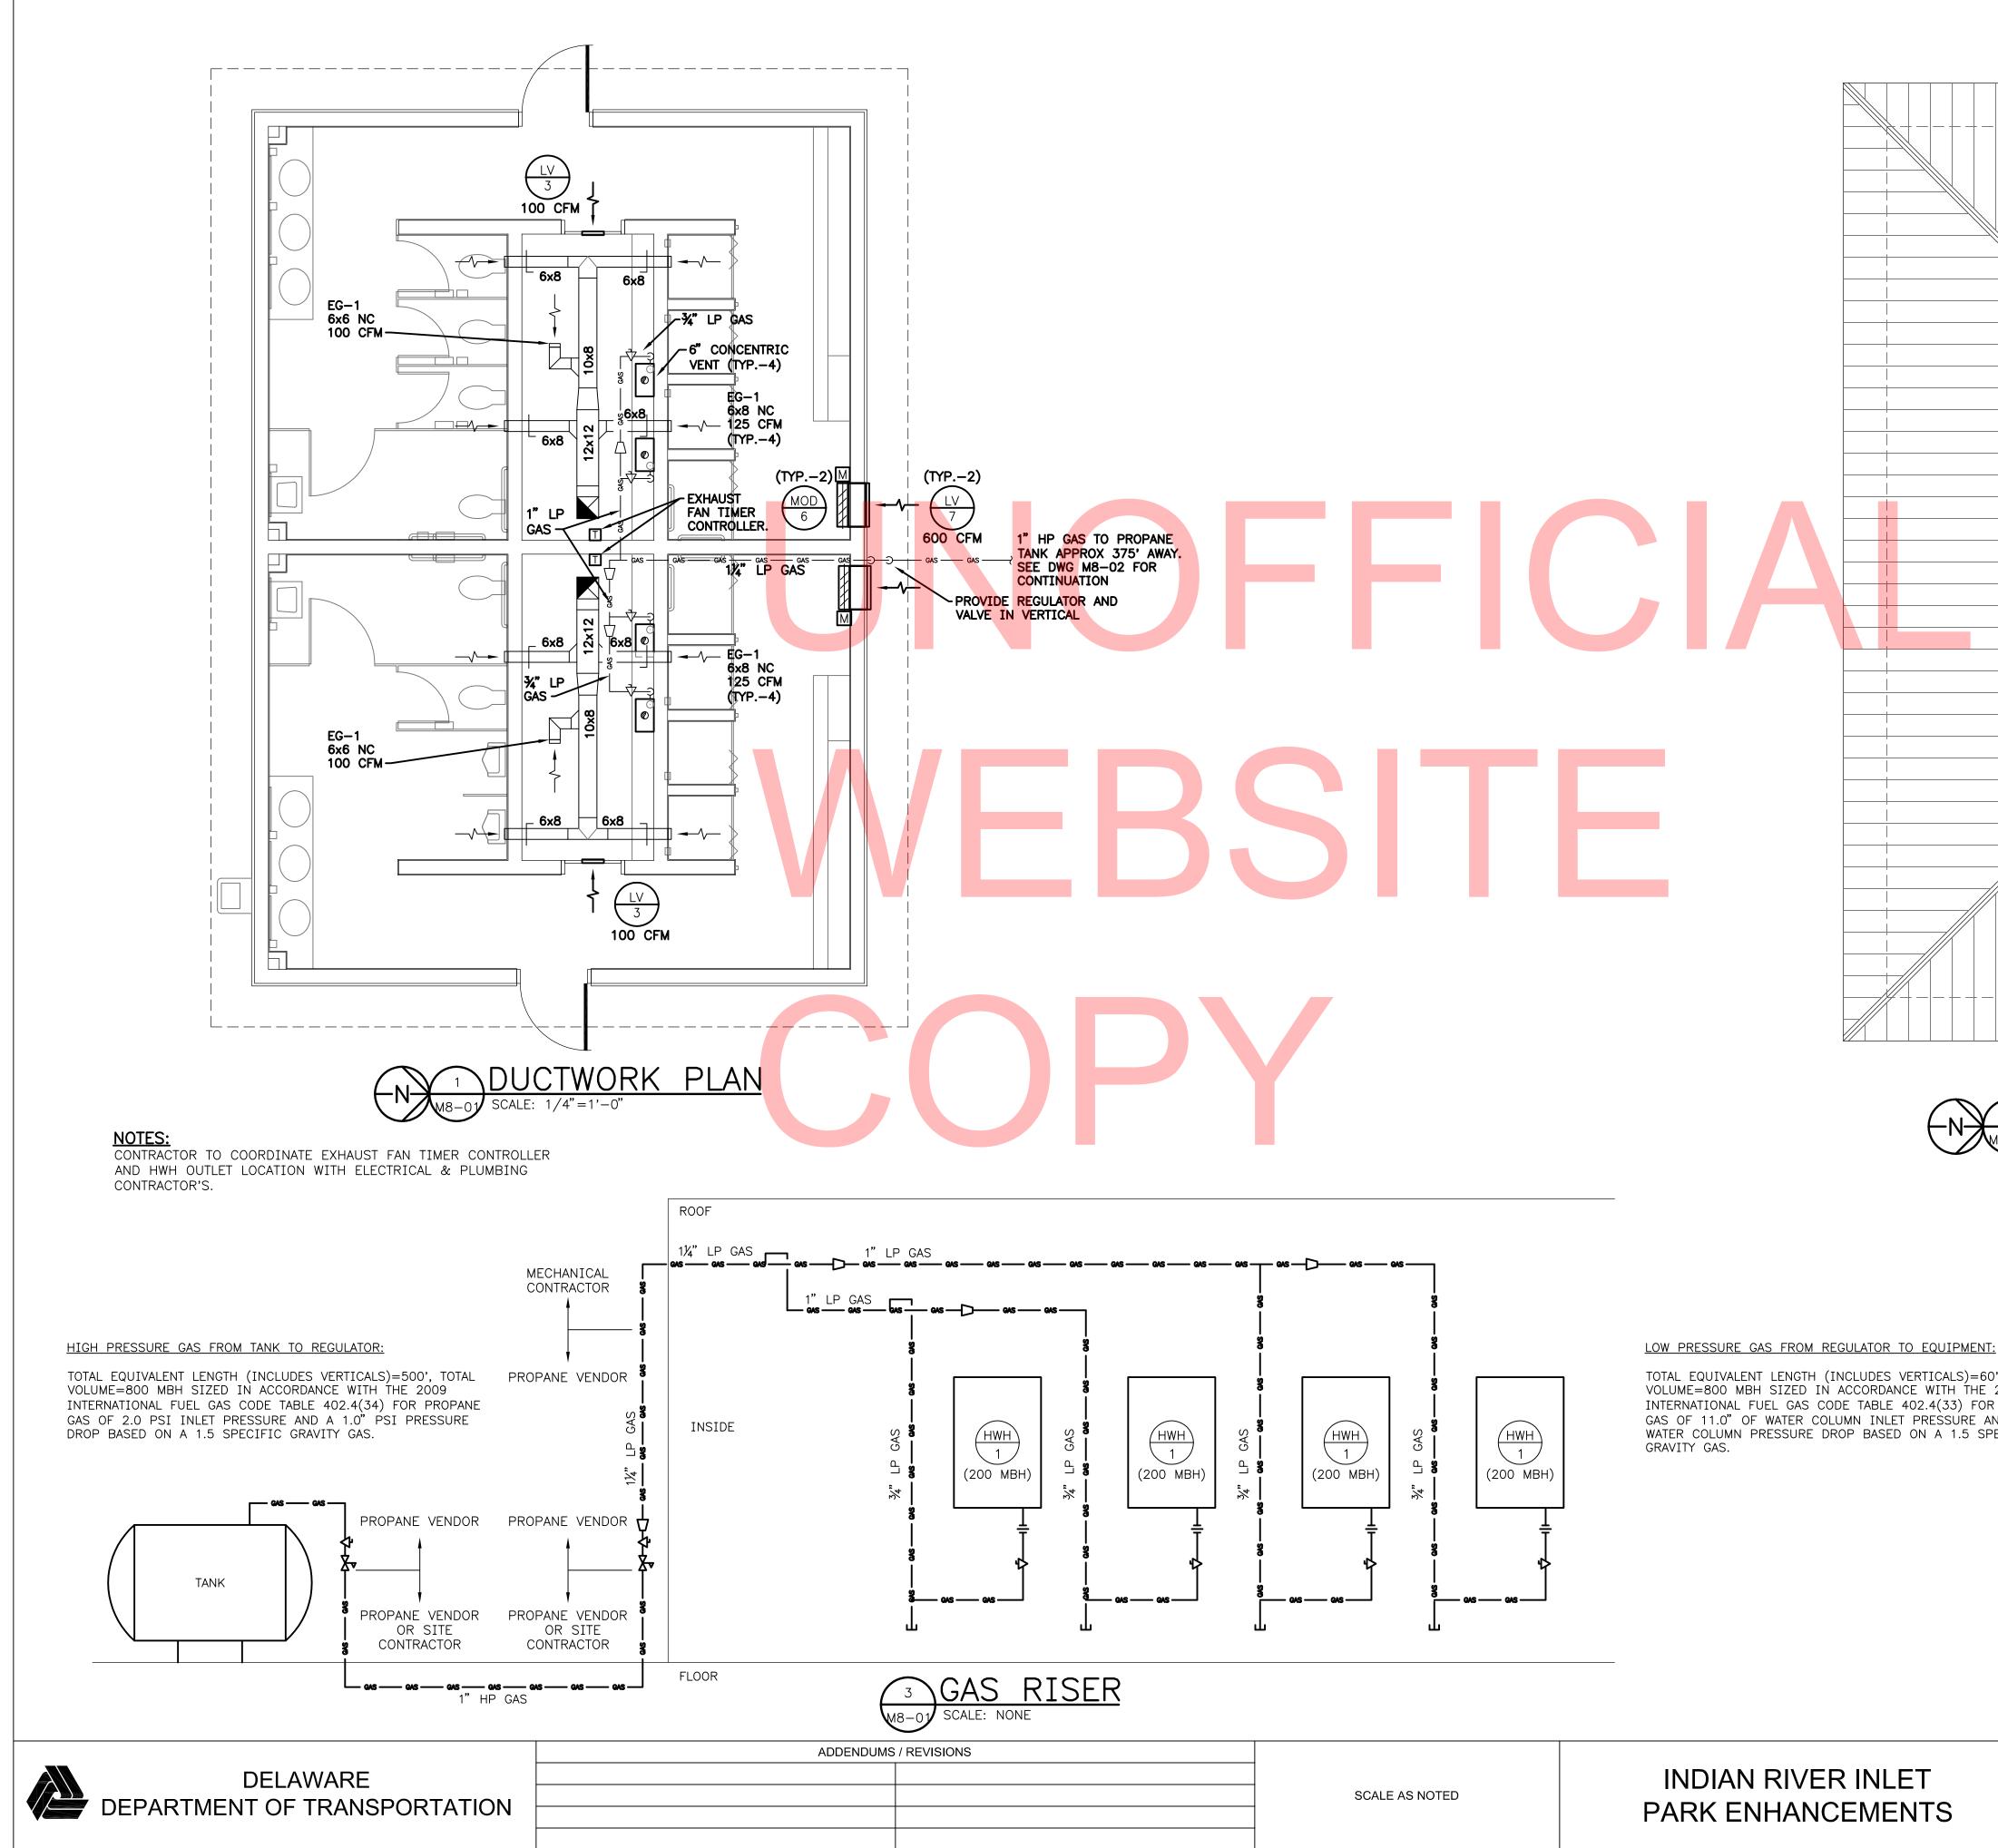

TOTAL EQUIVALENT LENGTH (INCLUDES VERTICALS)=60', TOTAL VOLUME=800 MBH SIZED IN ACCORDANCE WITH THE 2009 INTERNATIONAL FUEL GAS CODE TABLE 402.4(33) FOR PROPANE GAS OF 11.0" OF WATER COLUMN INLET PRESSURE AND A 0.5" OF WATER COLUMN PRESSURE DROP BASED ON A 1.5 SPECIFIC

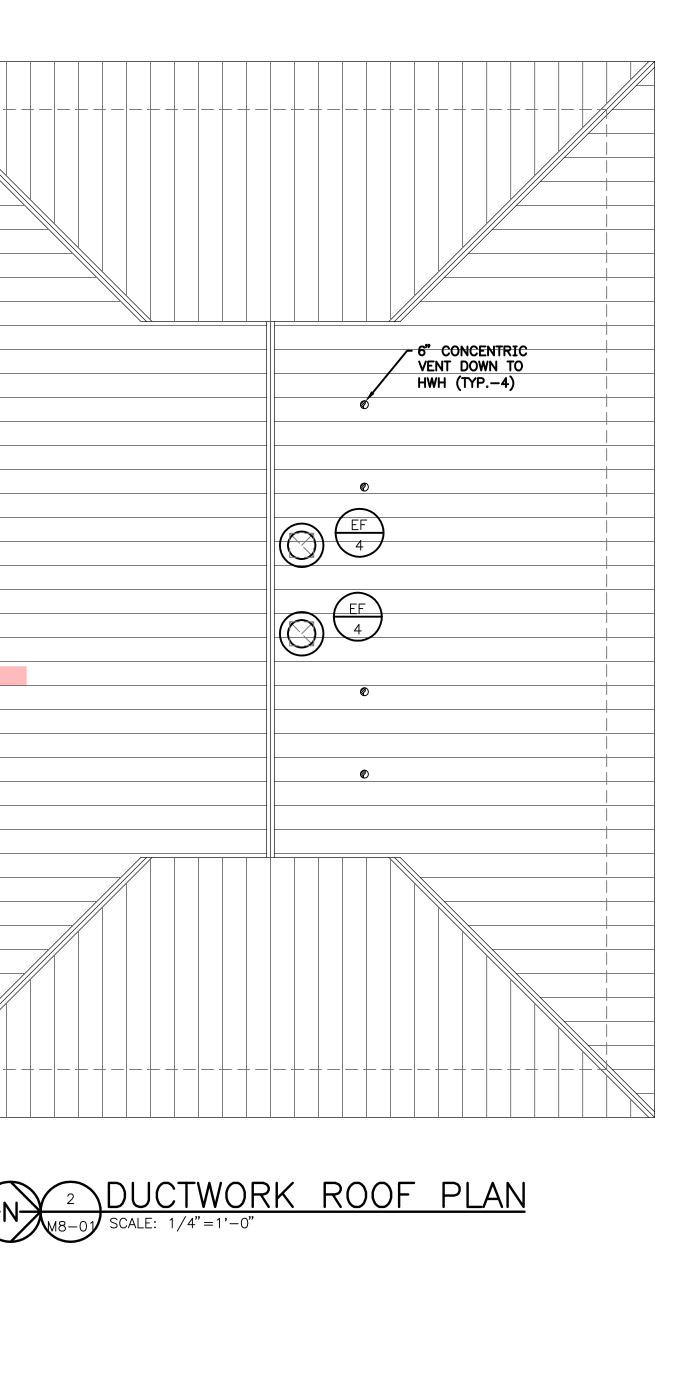


CONTRACT T200507303 COUNTY SUSSEX


BRIDGE NO. Х MLF DRAWN BY: JRF CHECKED BY:


EXIST. SOUTHEAST BATH HOUSE **BUILDING 8** MECHANICAL PLANS & DIAGRAMS M8-01

SHEET NO. CD261

TOTAL SHTS. CD282

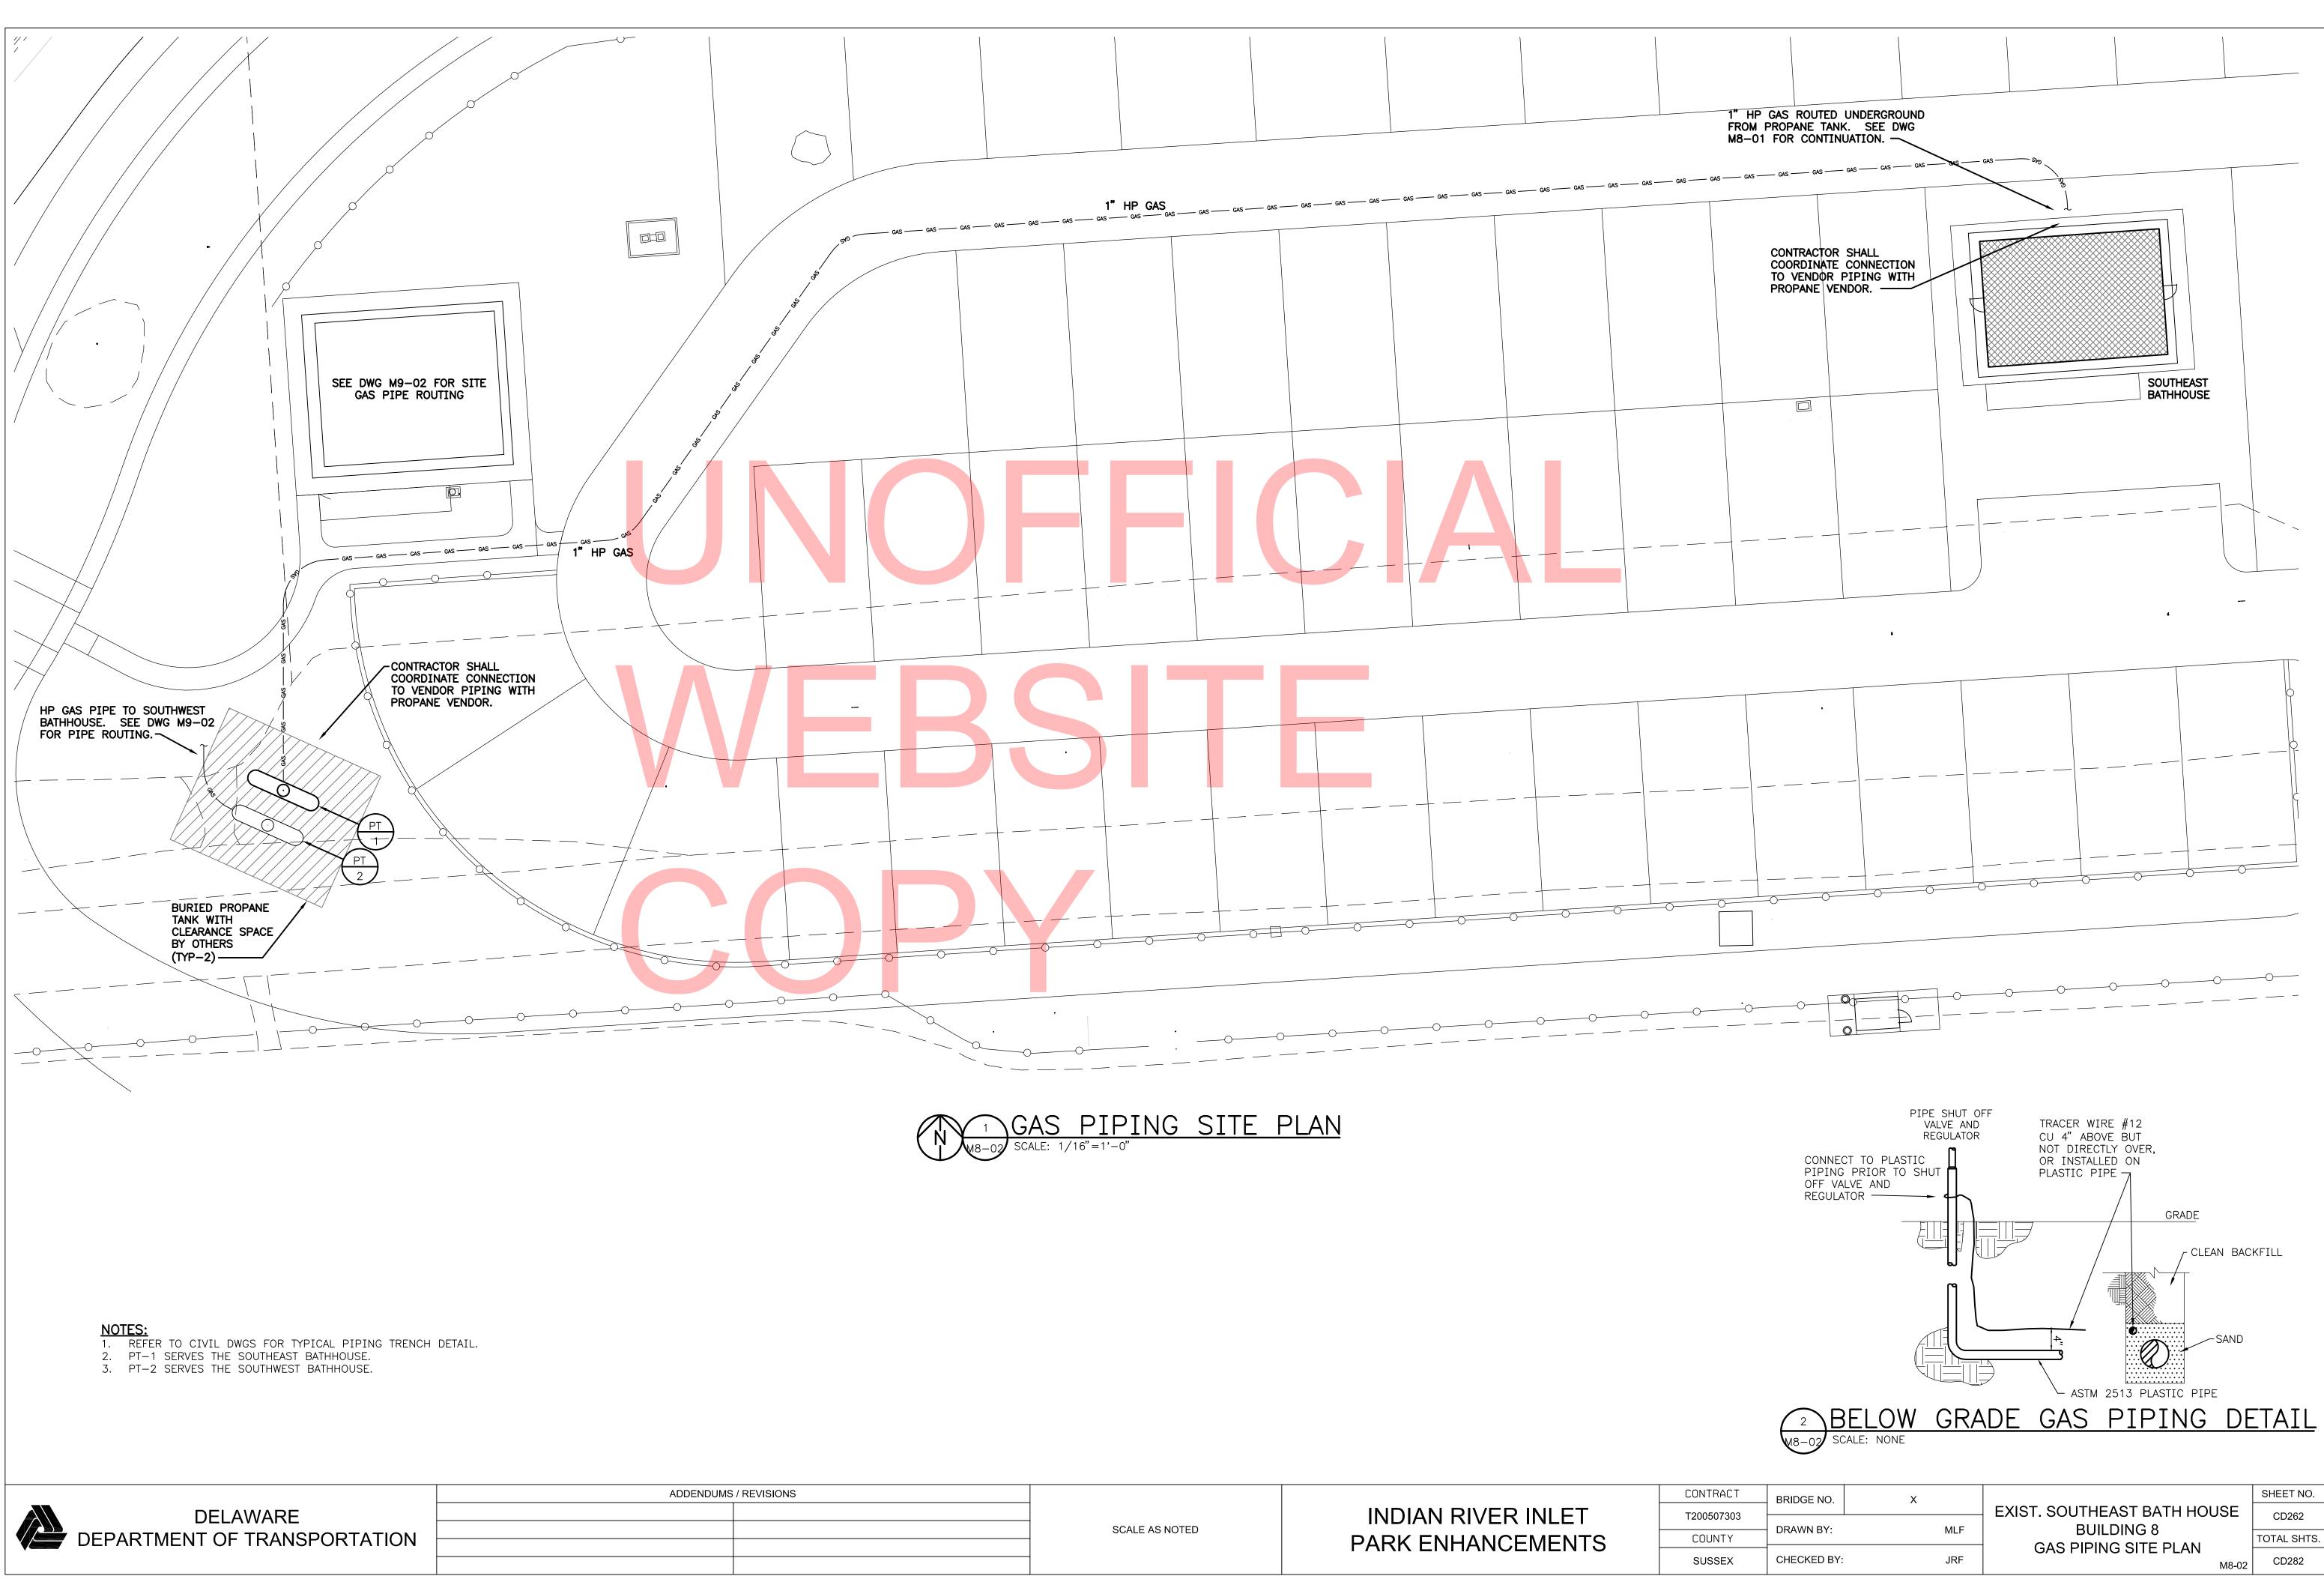

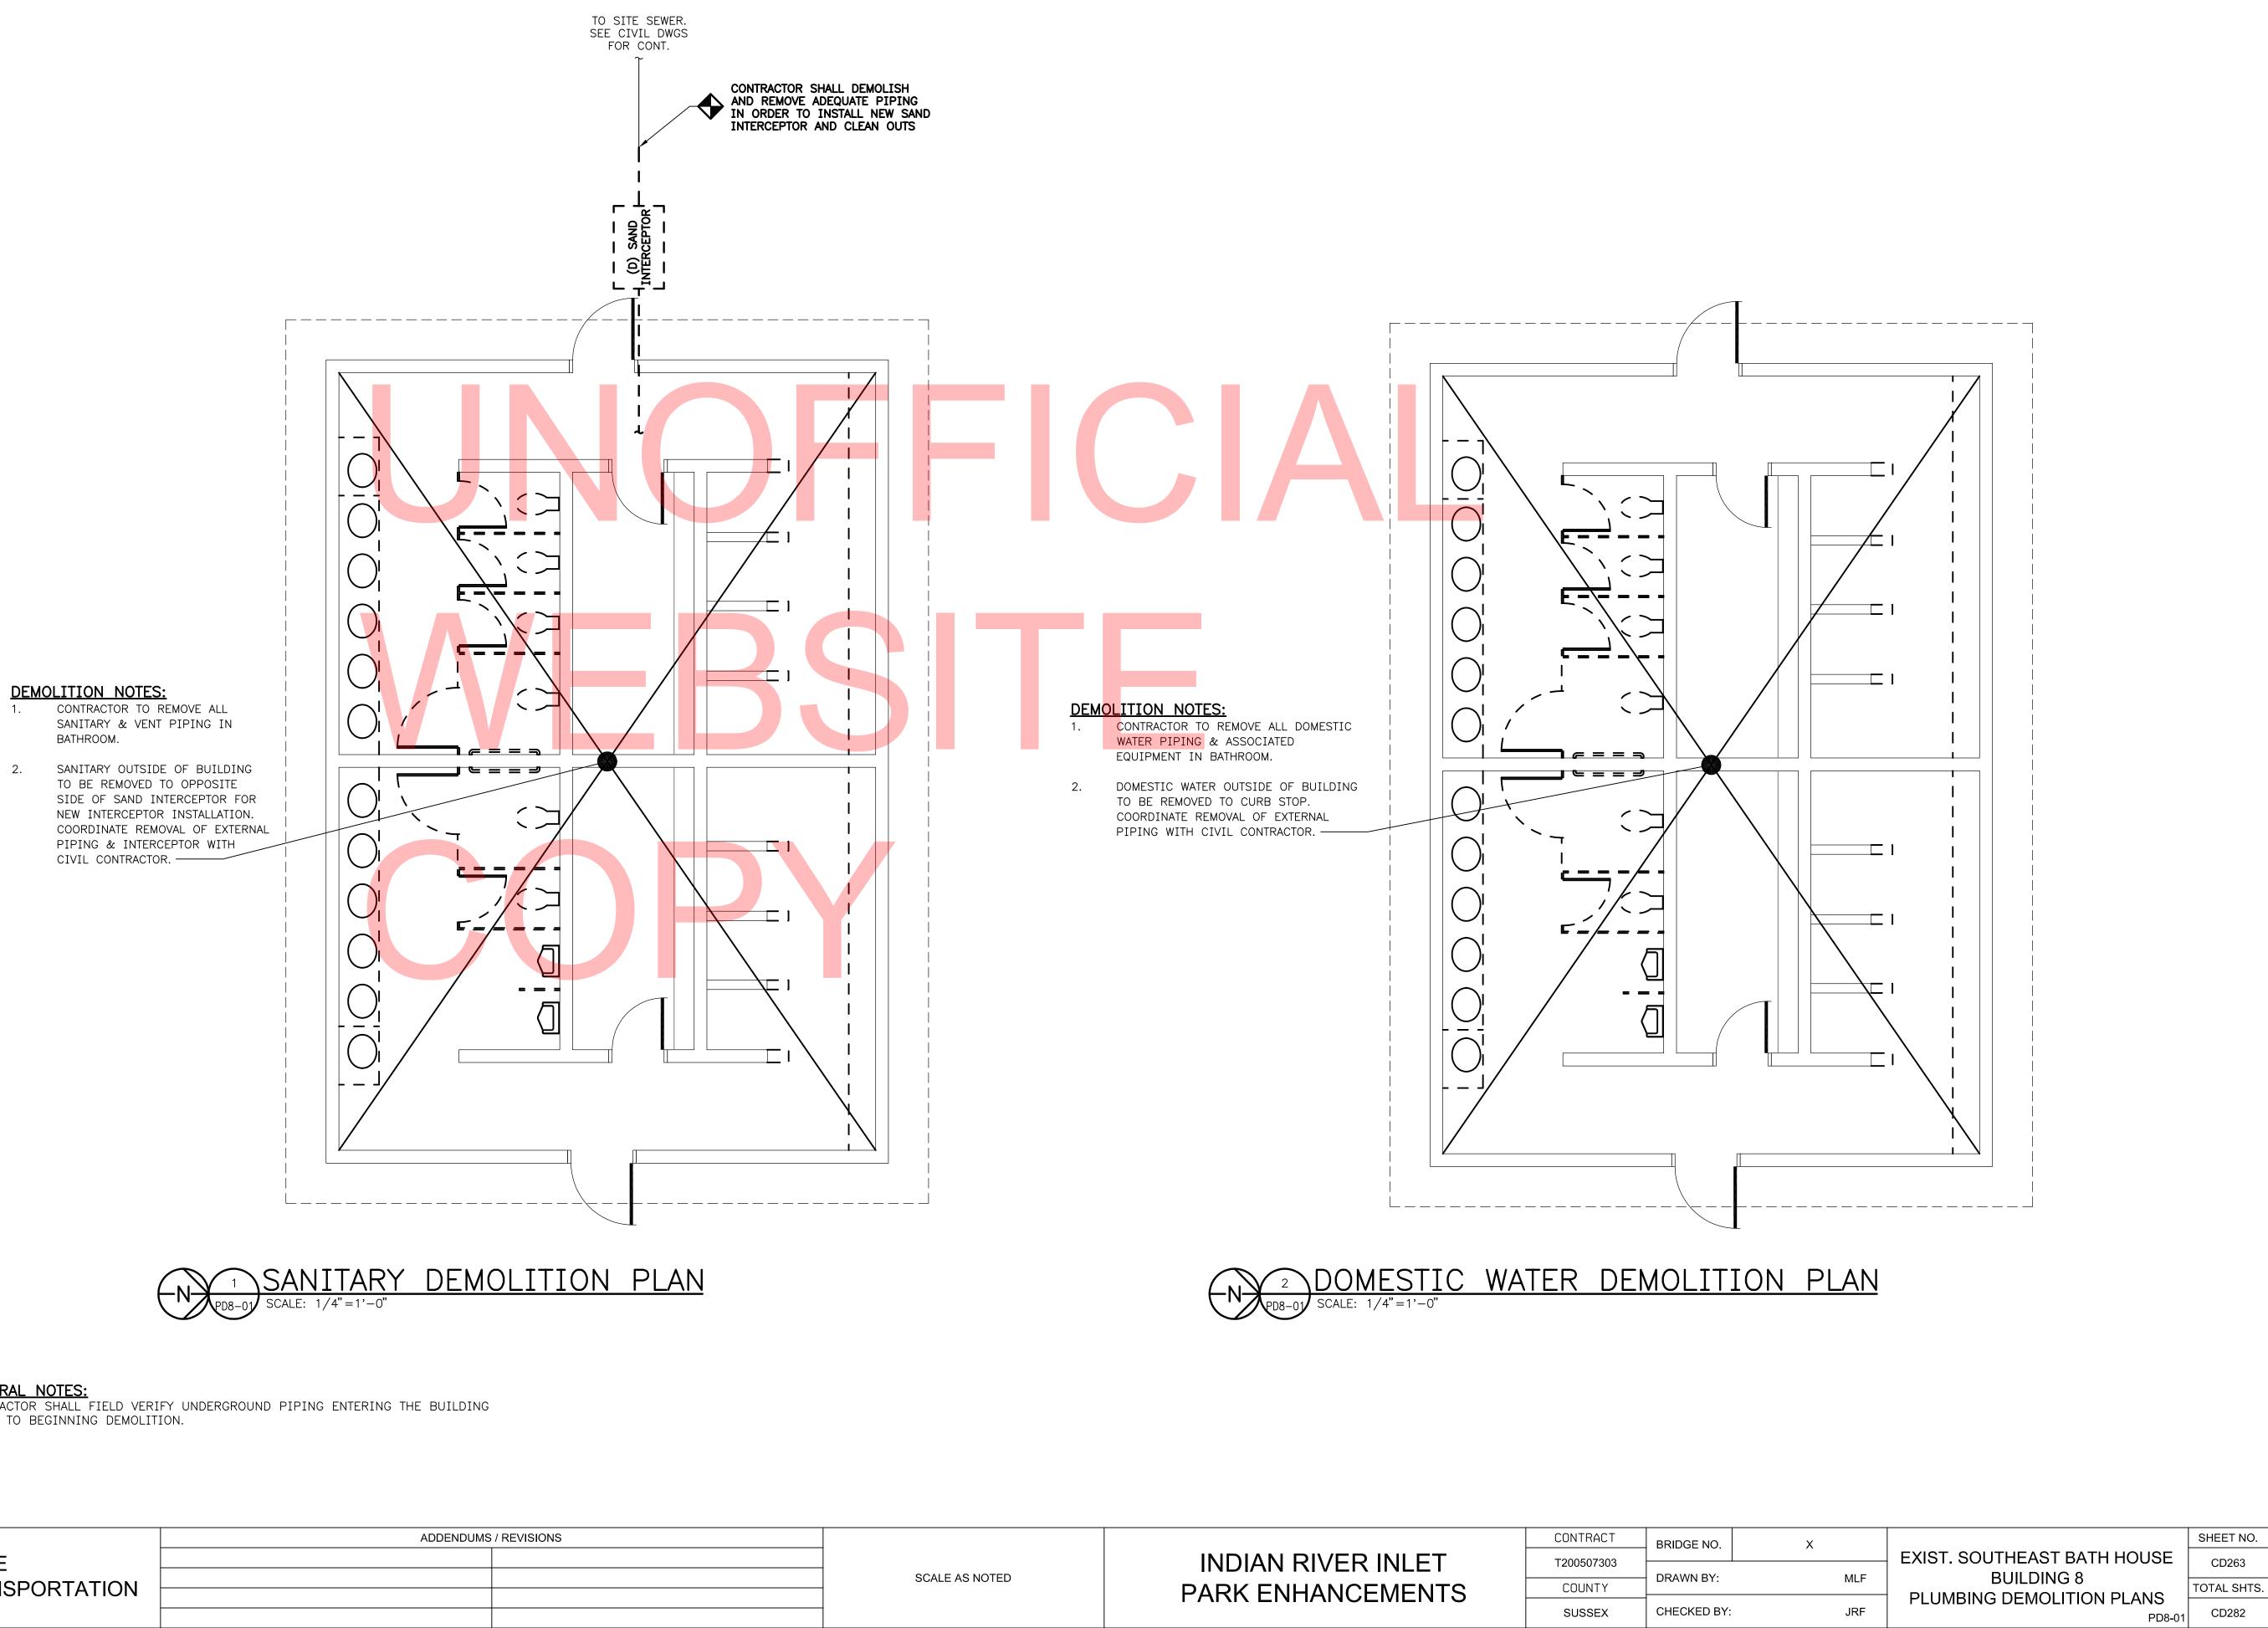


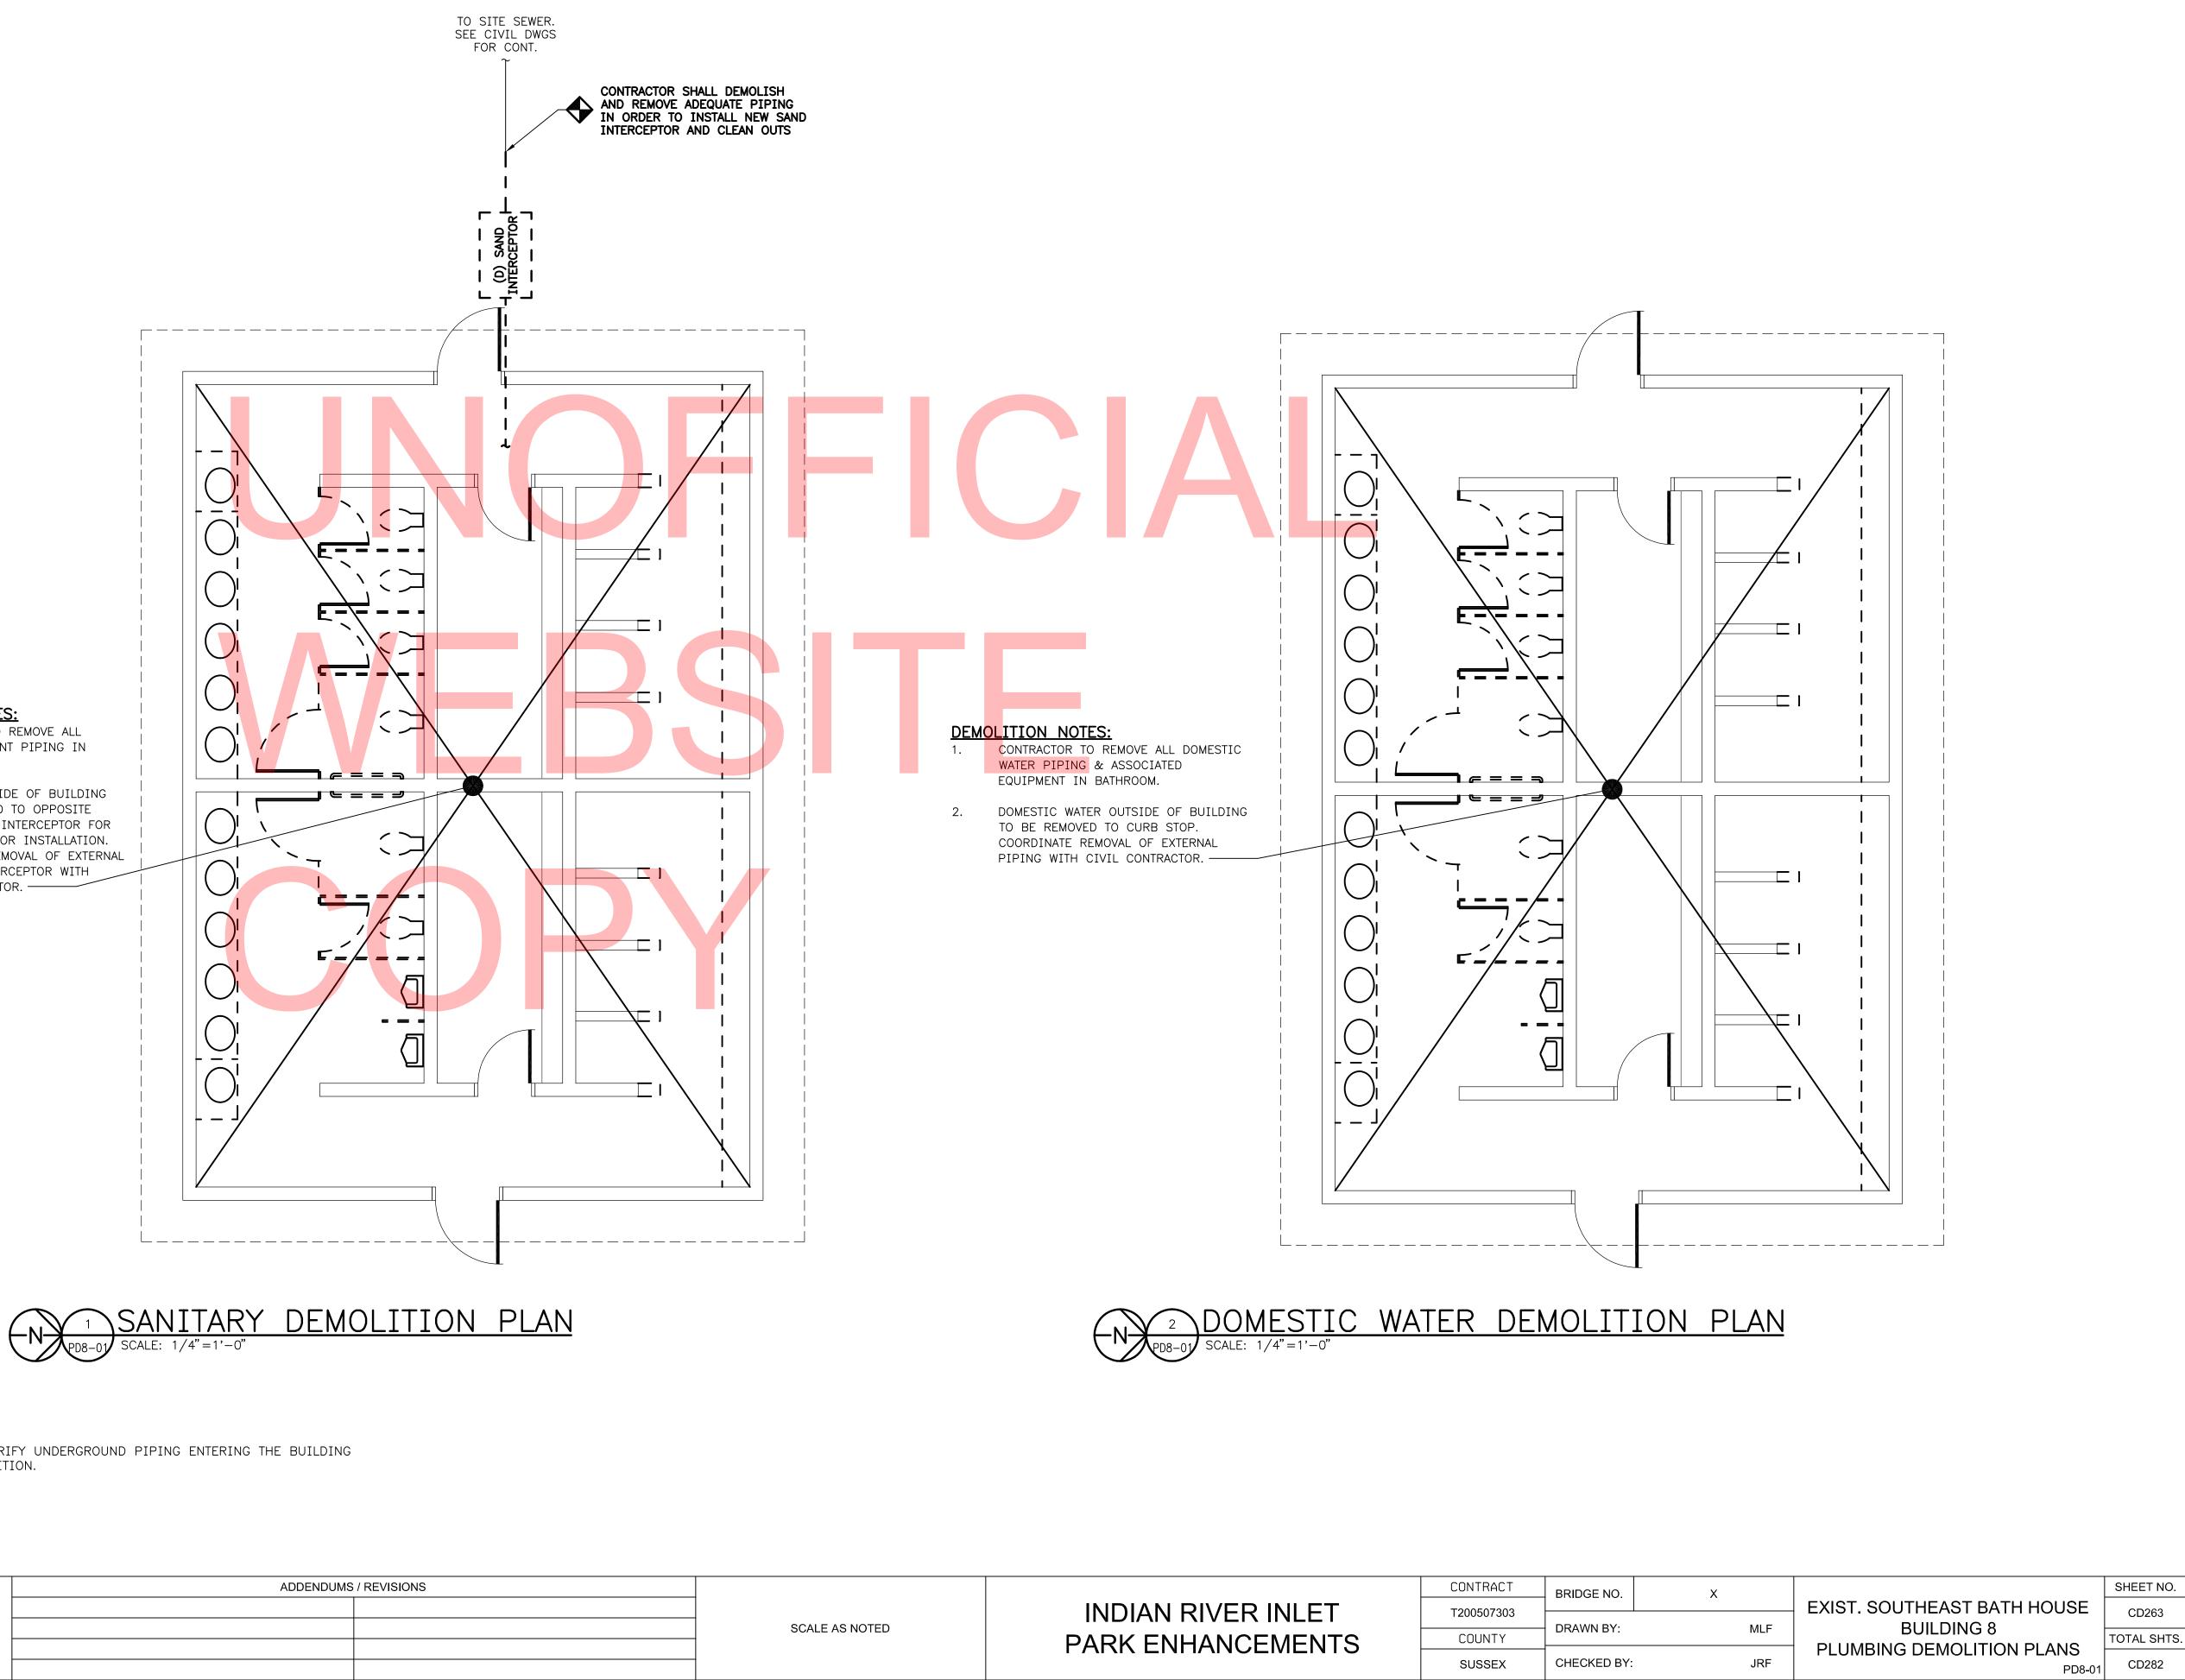



**GENERAL NOTES:** CONTRACTOR SHALL FIELD VERIFY UNDERGROUND PIPING ENTERING THE BUILDING PRIOR TO BEGINNING DEMOLITION.



DELAWARE DEPARTMENT OF TRANSPORTATION

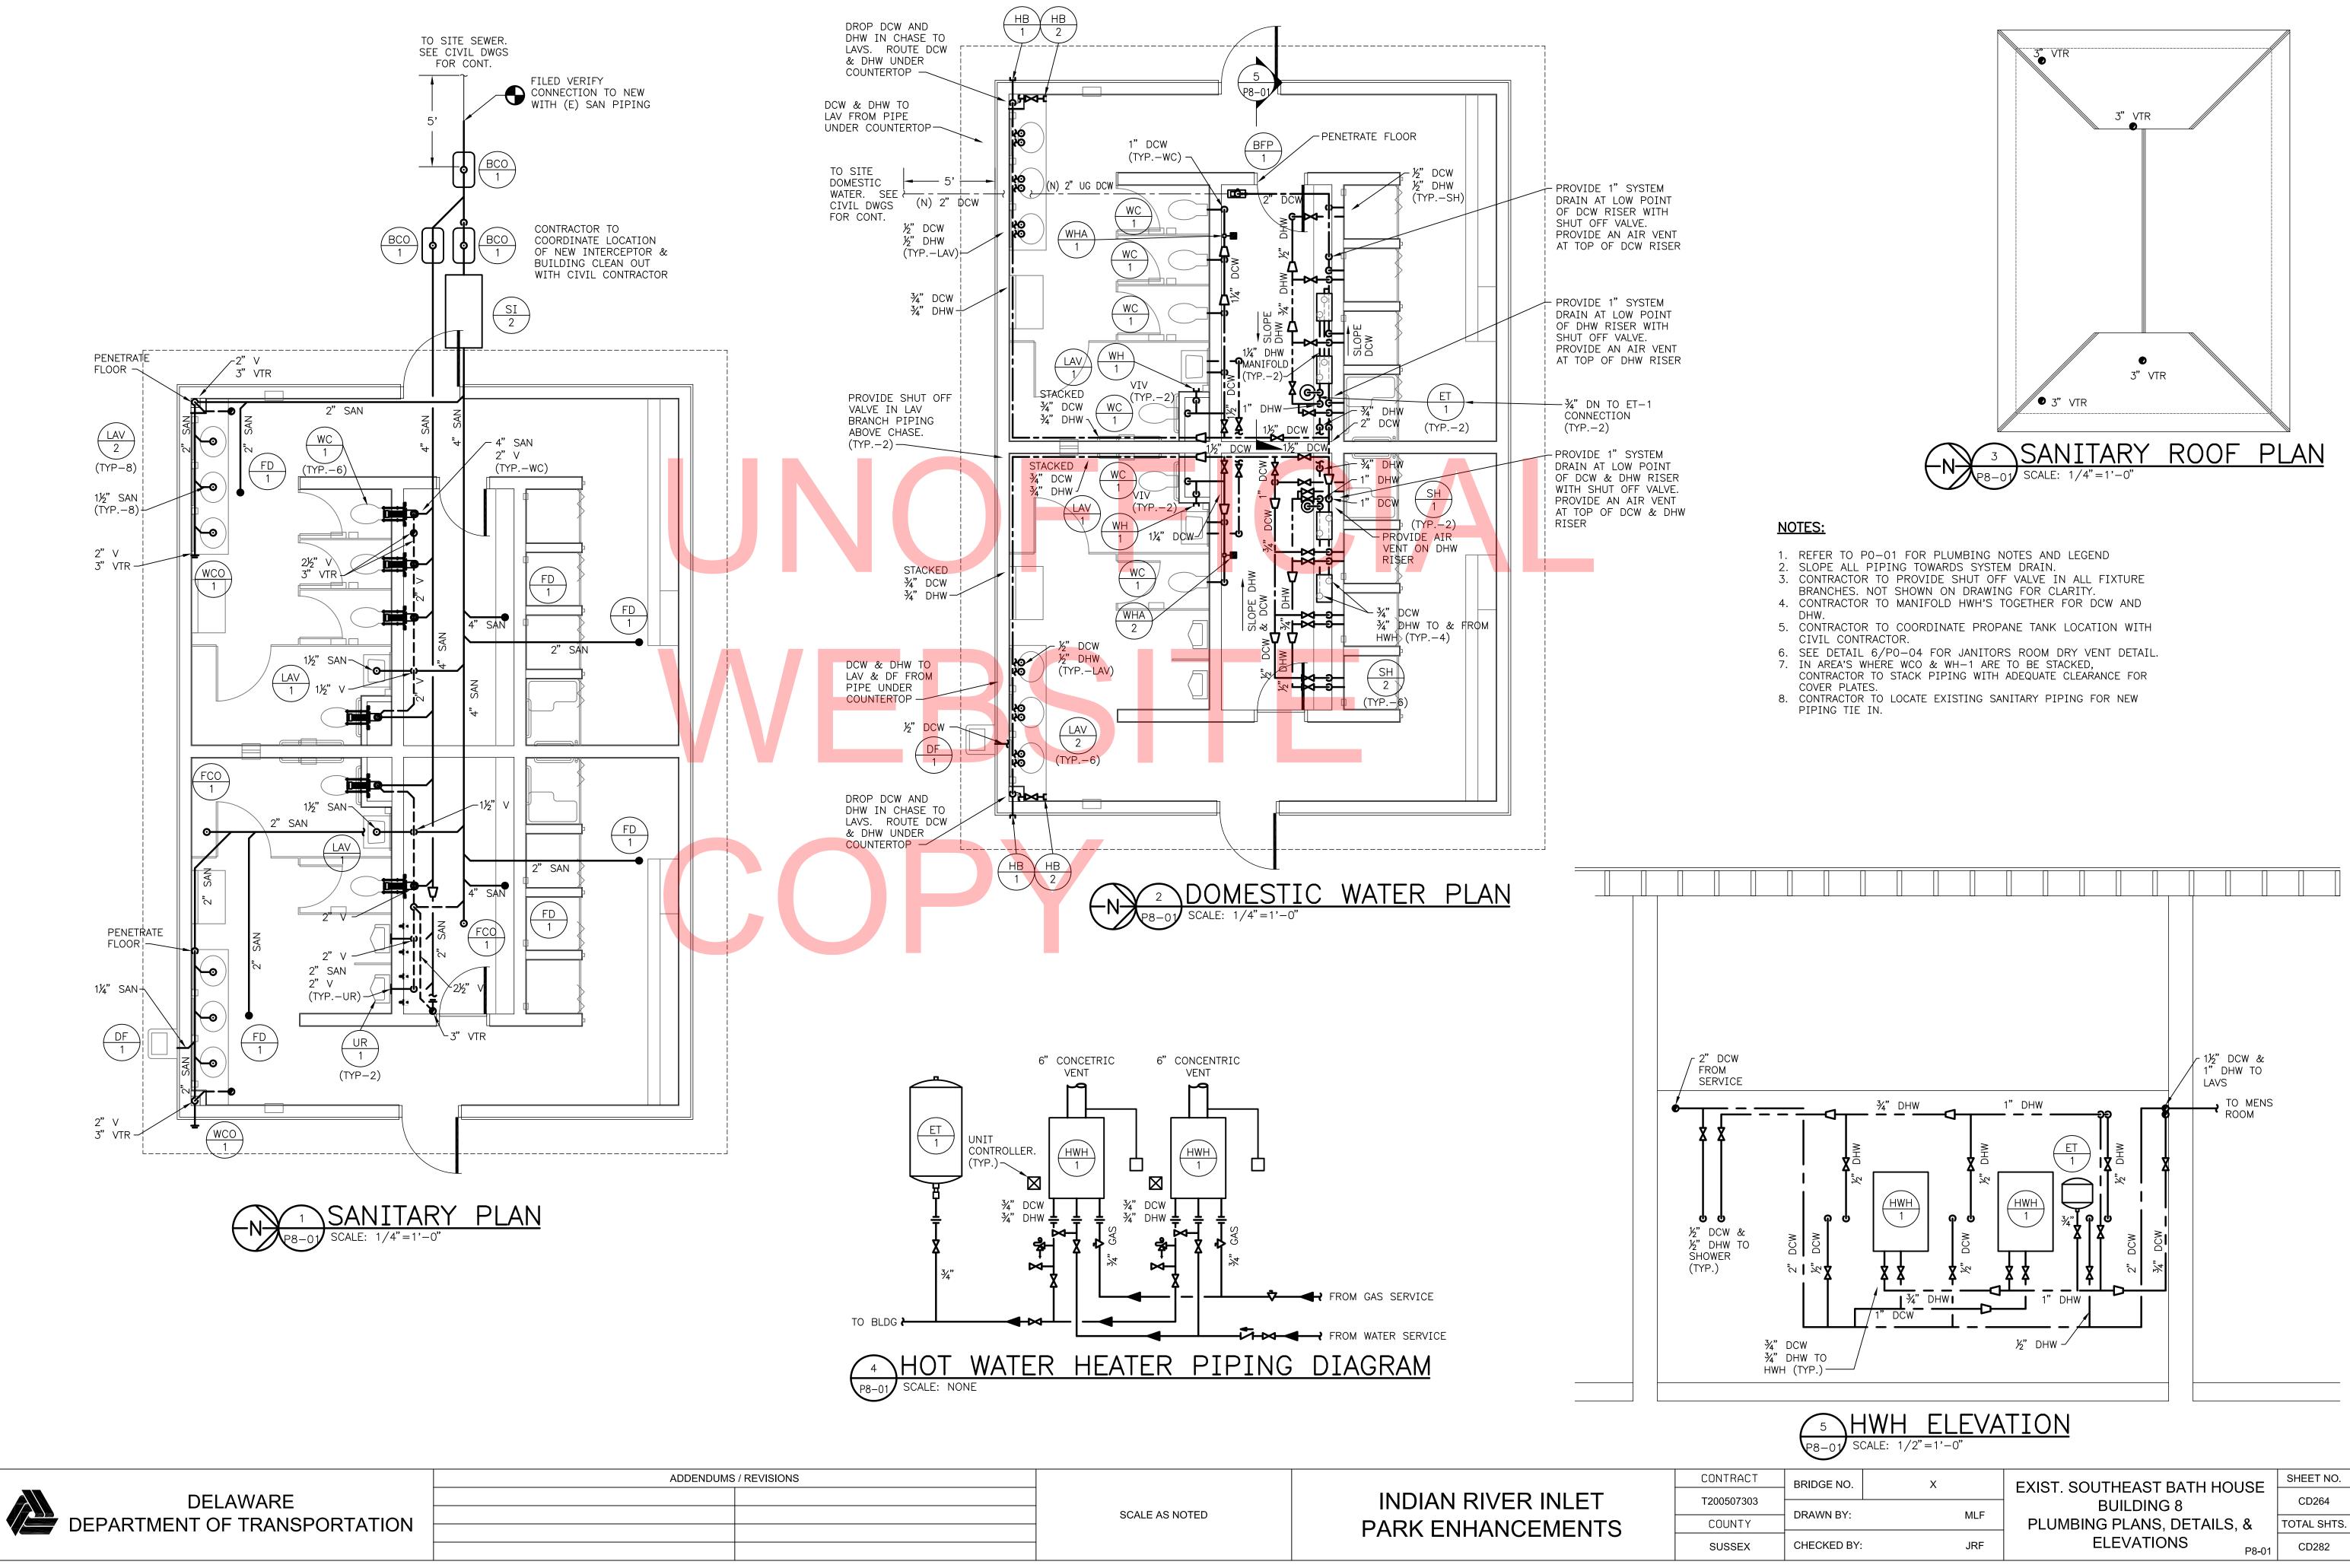

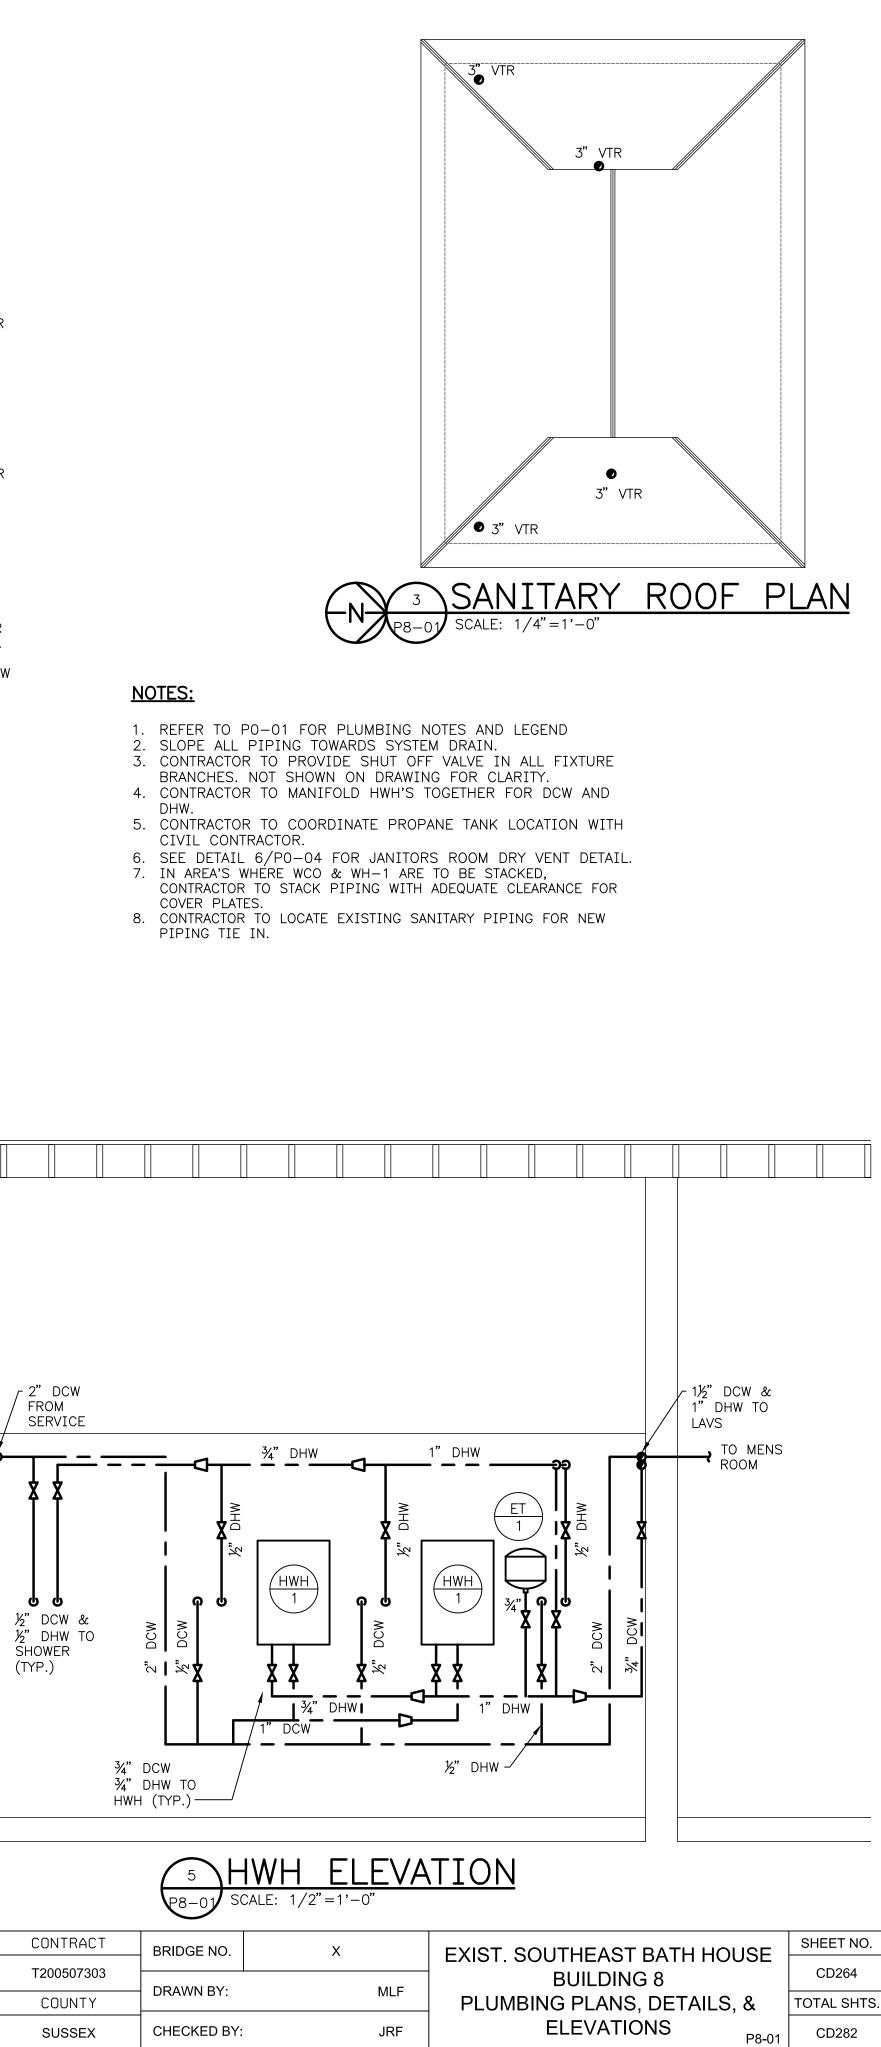


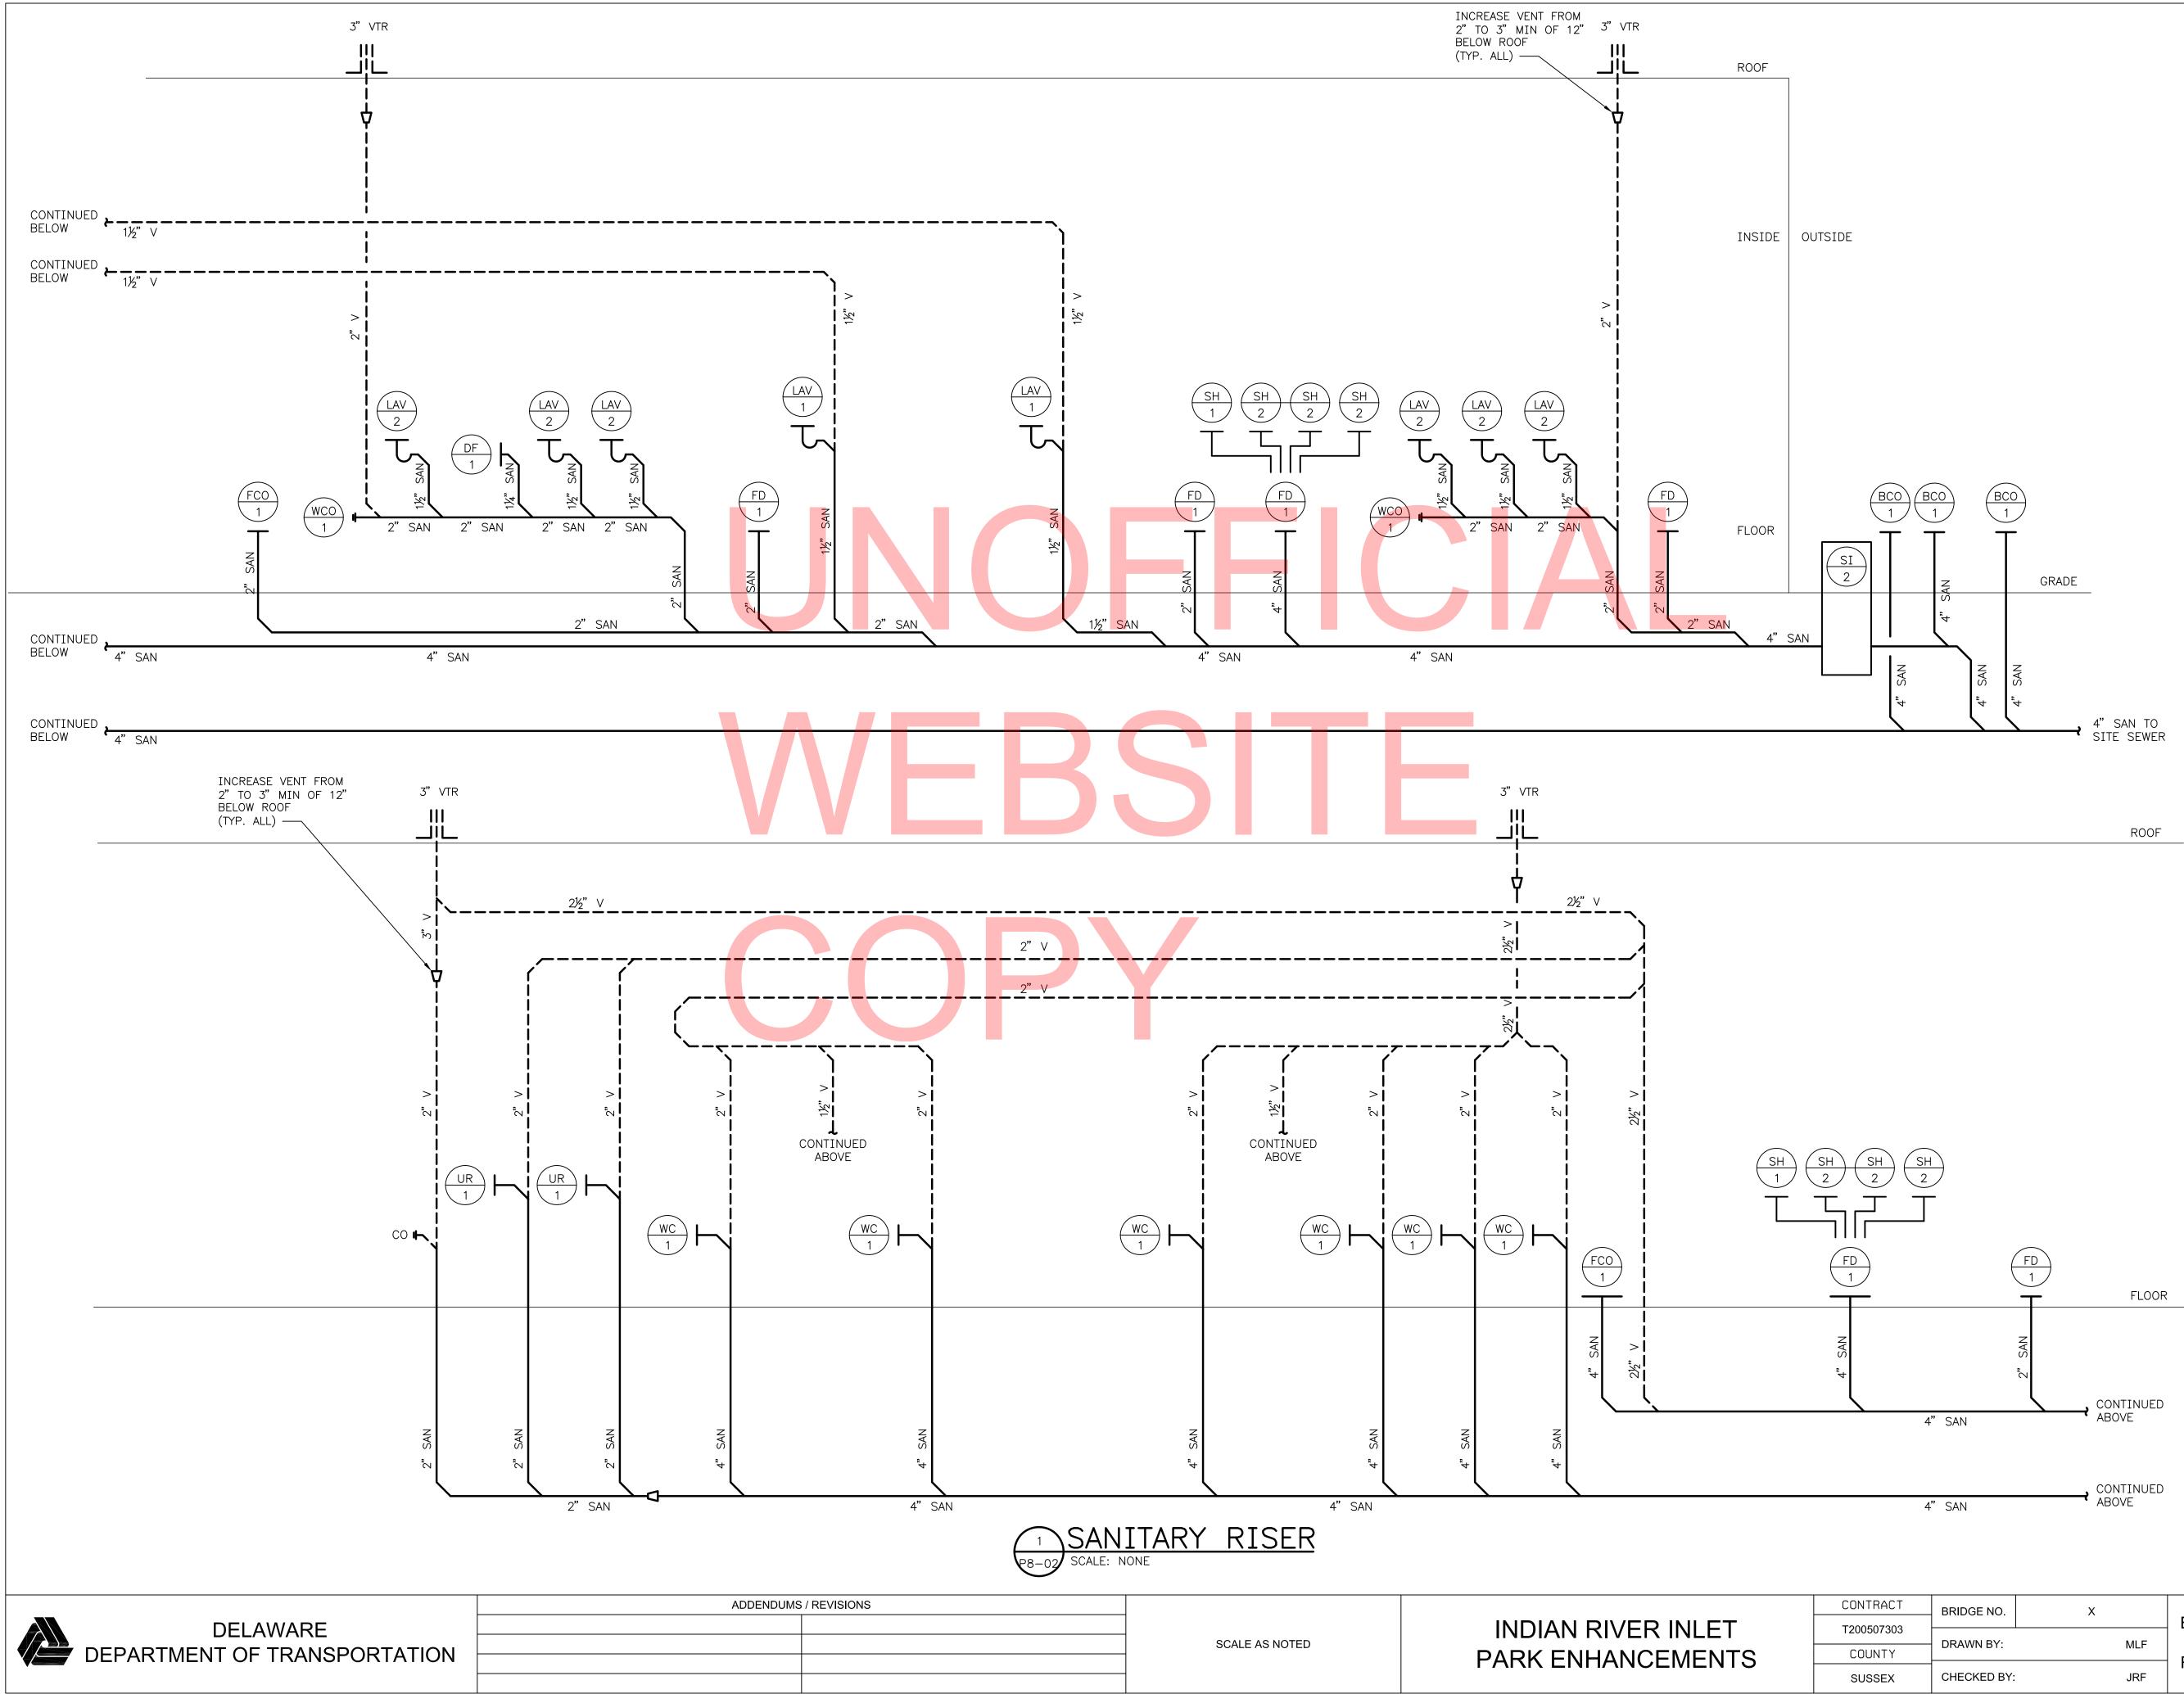


	4" SAN	· · · · · · · · · · · · · · · · · · ·	ABOVE		
	4" SAN		CONTINUED ABOVE		
CONTRACT	BRIDGE NO.	×	<		SHEET NO.
Г200507303				EXIST. SOUTHEAST BATH HOUSE	CD265
COUNTY	DRAWN BY:		MLF	BUILDING 8	TOTAL SHTS.
SUSSEX	CHECKED BY:		JRF	RISER DIAGRAMS (SHEET 1 OF 2) P8-02	CD282

DELAWARE
DEPARTMENT OF TRANSPORTATION

ADDENDUM	ADDENDUMS / REVISIONS		

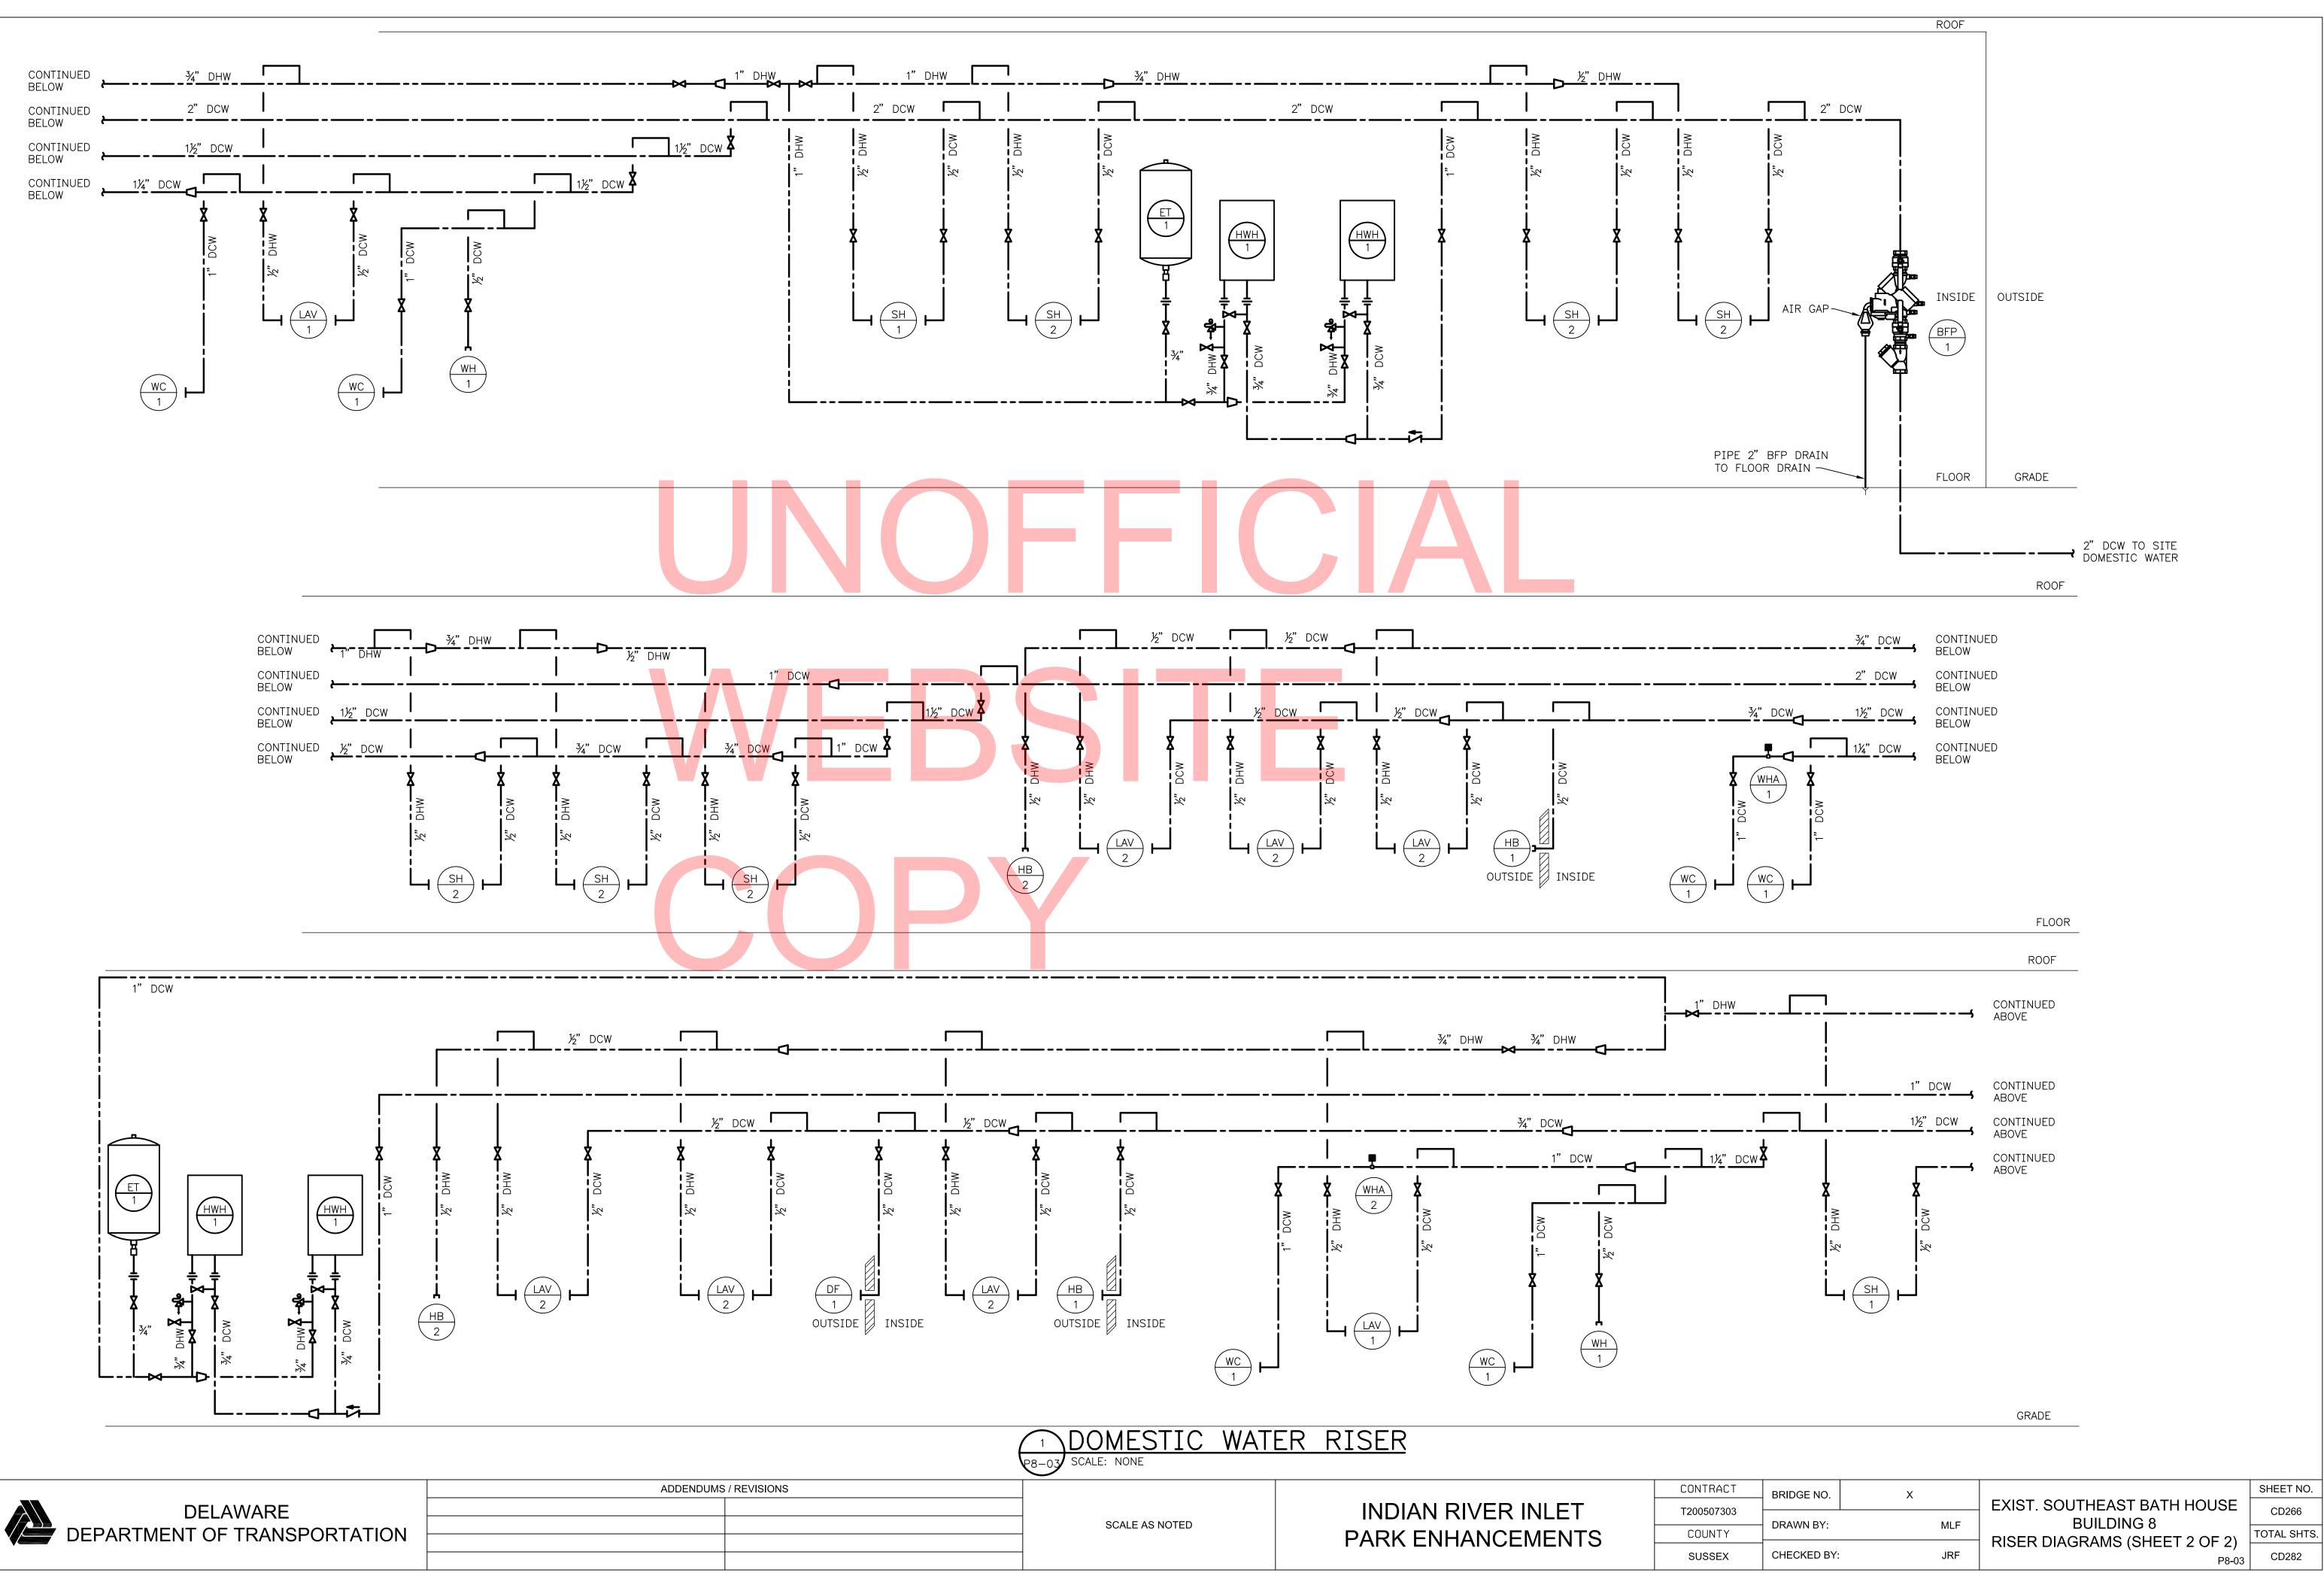

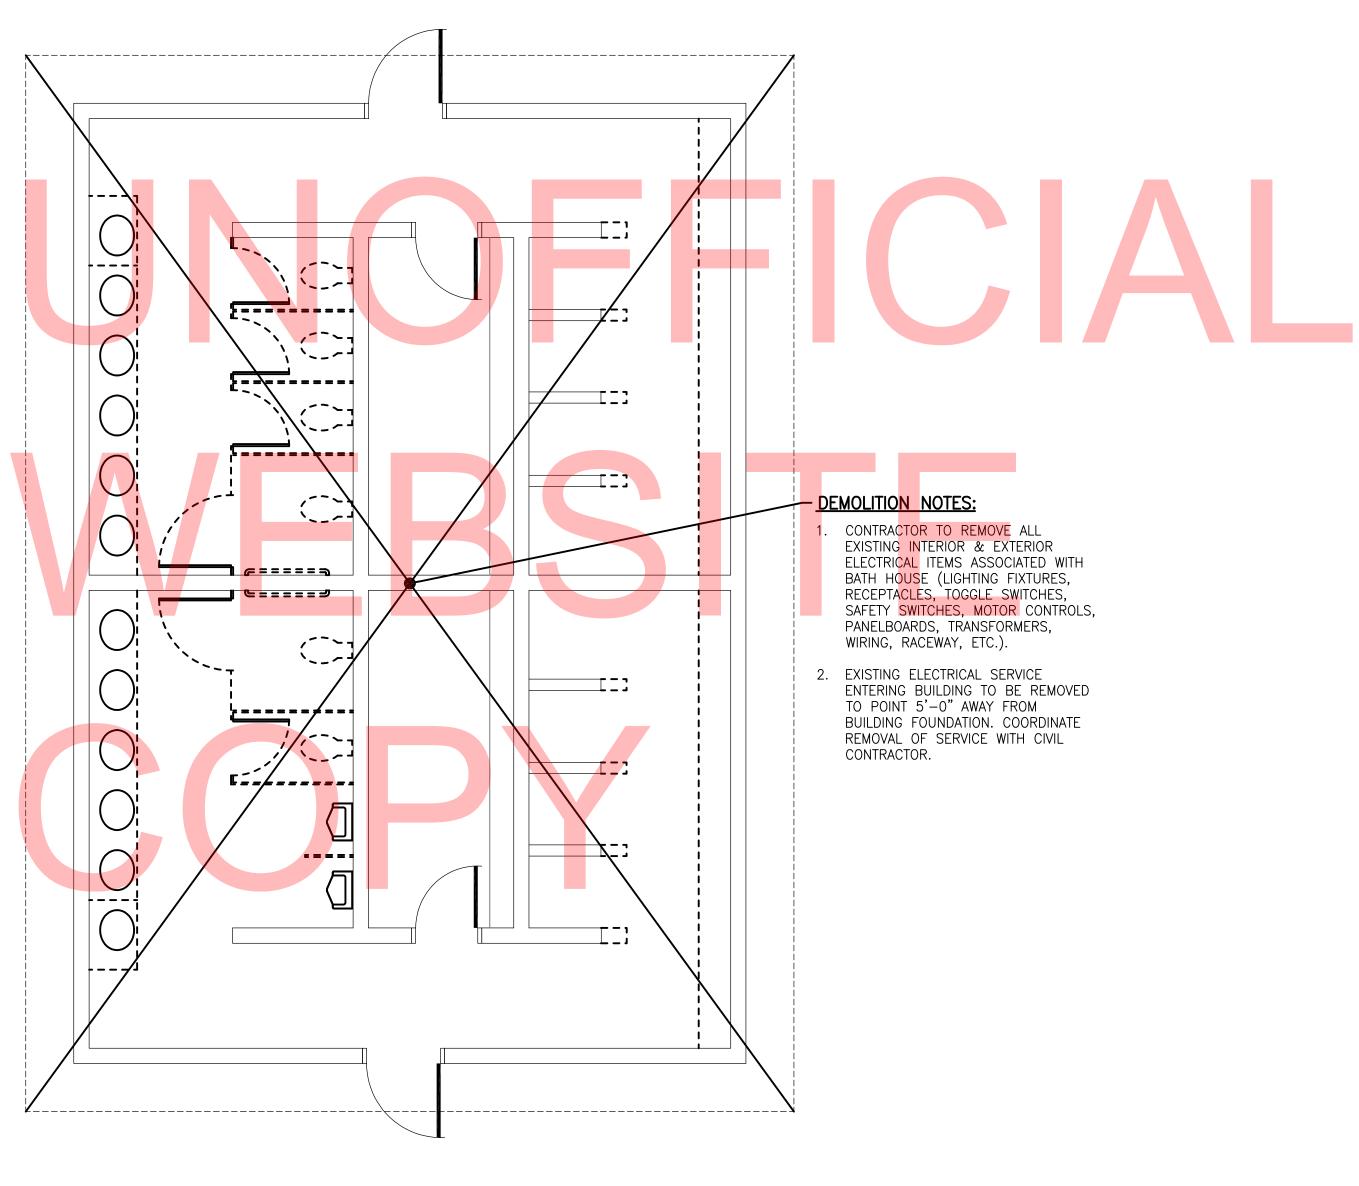





N EXIST. SOUTHEAST BATH HOUSE - ELECTRICAL DEMOLITION PLAN


INDIAN RIVER INLET PARK ENHANCEMENTS CONTRACT T200507303 COUNTY SUSSEX


BRIDGE NO. Х DRAWN BY: AHH JRF CHECKED BY:

EXIST. SOUTHEAST BATH HOUSE **BUILDING 8** ELECTRICAL DEMOLITION PLAN ED8-01

SHEET NO. CD267

TOTAL SHTS. CD282

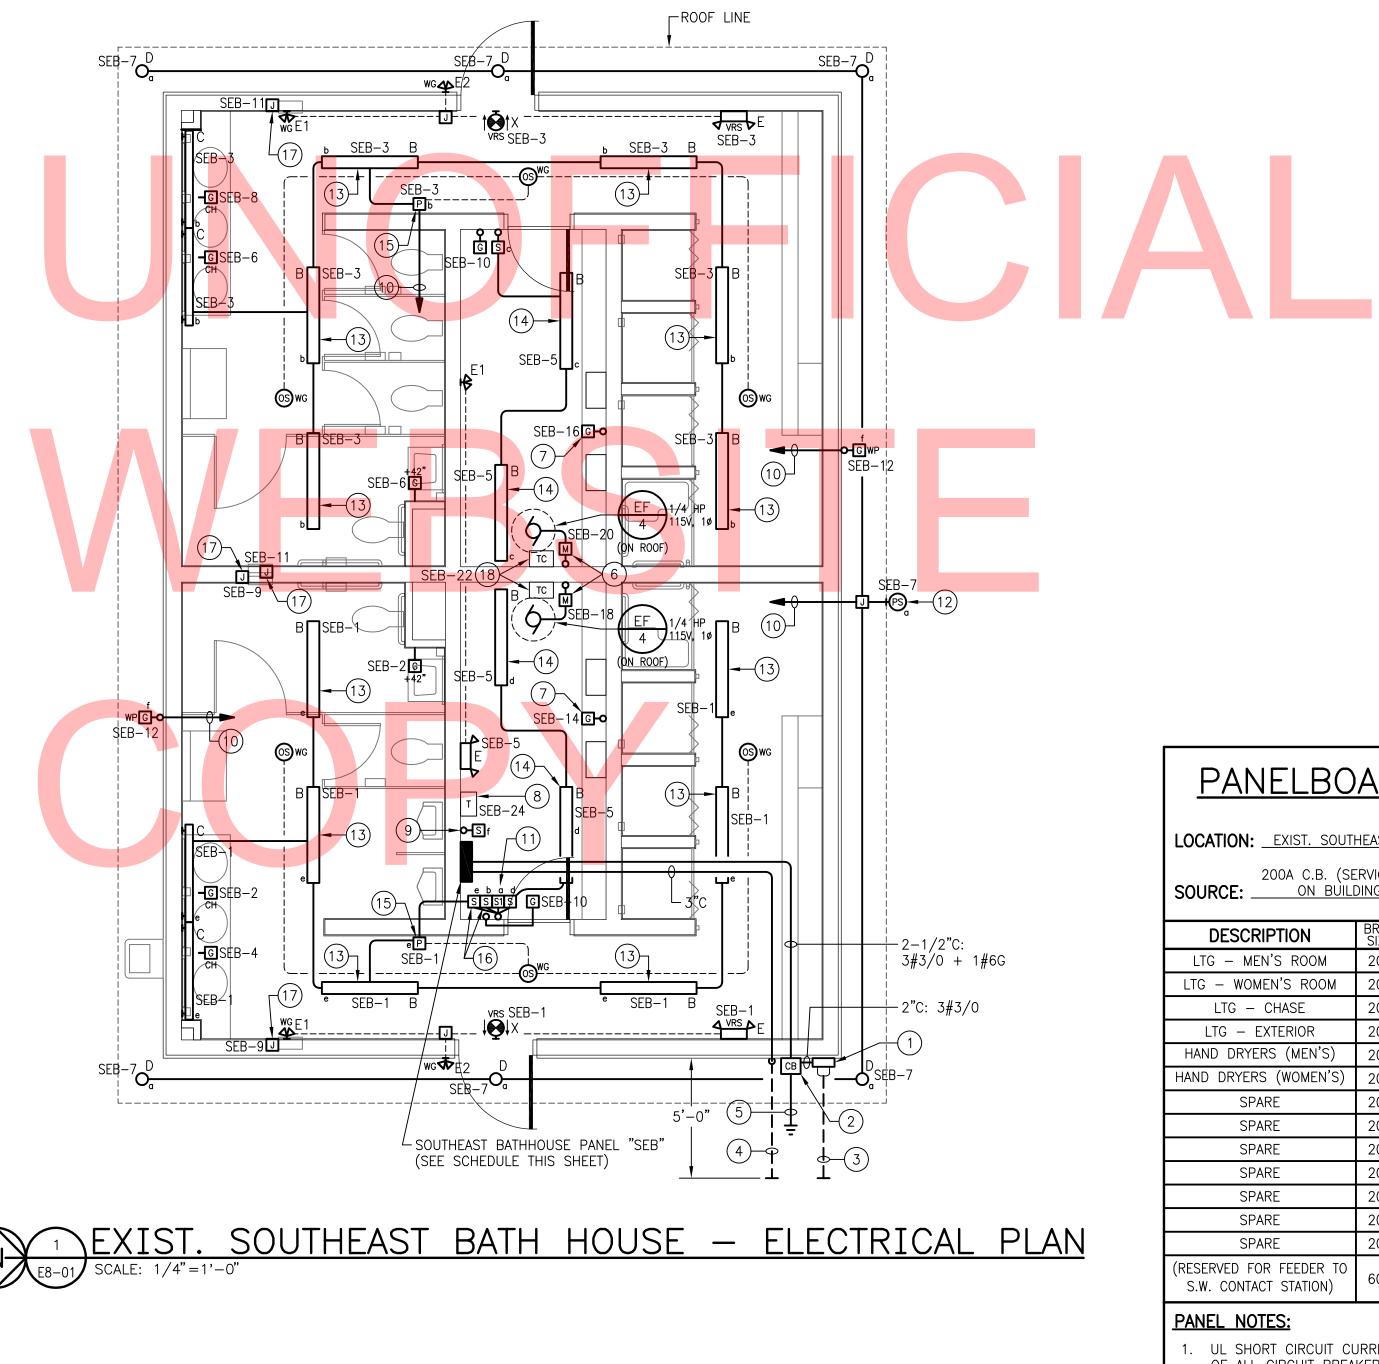

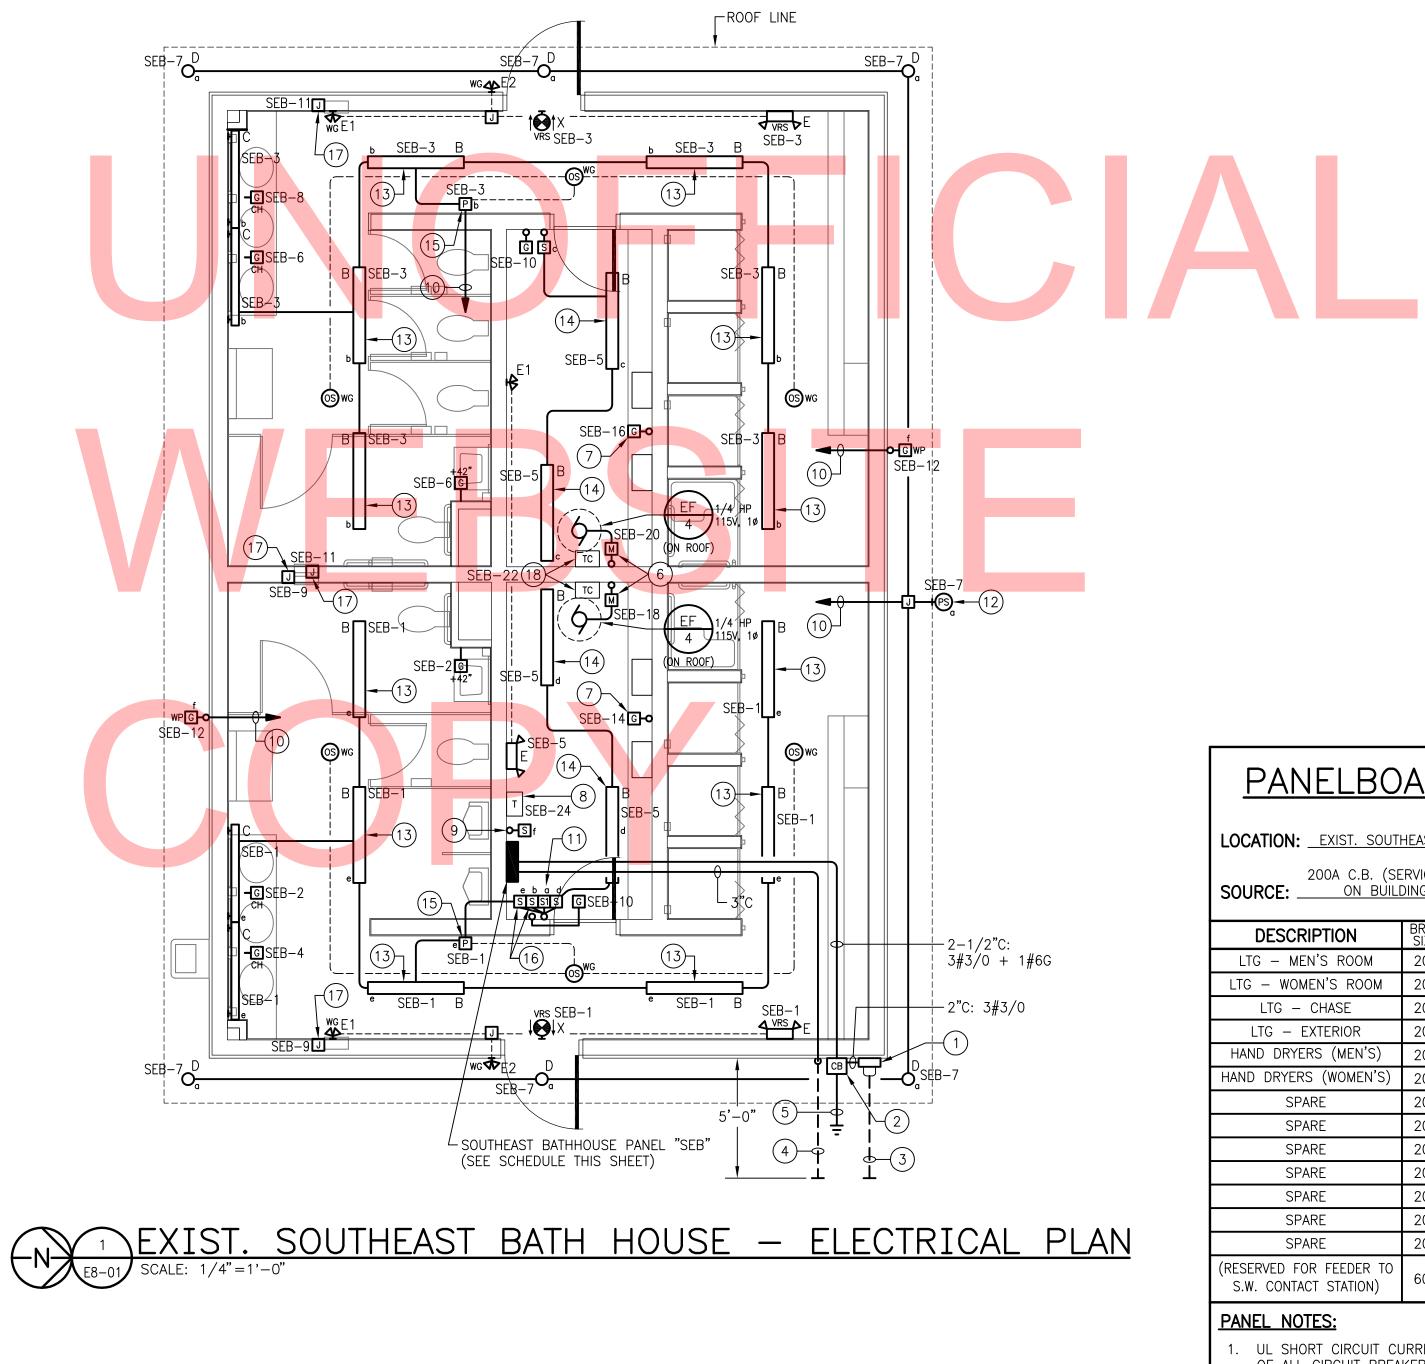



ADDENDUMS / REVISIONS

SCALE AS NOTED

### INDIAN RIVER INLET PARK ENHANCEMENTS

### SHEET NOTES:

- (1) 200A, 1Ø, 3W METER SOCKET PER UTILITY REQUIREMENTS (METER PROVIDED BY ELECTRIC UTILITY).
- 2 <u>ENCLOSED CIRCUIT BREAKER (SERVICE DISCONNECT)</u>: 200A/2P, 240V IN NEMA 4X STAINLESS STEEL ENCLOSURE. CIRCUIT BREAKER ASSEMBLY SHALL BE SUITABLE FOR USE AS SERVICE EQUIPMENT. UL SHORT CIRCUIT CURRENT AND INTERRUPT RATINGS OF CIRCUIT BREAKER SHALL BE COORDINATED WITH AVAILABLE FAULT CURRENT AT BREAKER PRIOR TO PURCHASING EQUIPMENT. COORDINATE WITH ELECTRIC UTILITY AND SITE ENGINEER.
- (3) EMPTY 3-1/2" SCHEDULE 80 PVC UNDERGROUND CONDUIT STUB-OUT WITH PULL STRING FOR ELECTRICAL SERVICE TO BUILDING (CONDUCTORS PROVIDED BY OTHERS). TOP OF CONDUIT SHALL BE BURIED MINIMUM 36" BELOW FINISHED GRADE. PROVIDE CONTINUOUS DETECTABLE RED WARNING TAPE IN BACKFILL 12" BELOW FINISHED GRADE ("CAUTION – BURIED ELECTRIC LINE BELOW").
- (4) EMPTY 3" SCHEDULE 80 PVC UNDERGROUND CONDUIT STUB-OUT WITH PULL STRING FOR ELECTRICAL FEEDER TO WEST CONTACT STATION (CONDUCTORS PROVIDED BY OTHERS). TOP OF CONDUIT SHALL BE BURIED MINIMUM 36" BELOW FINISHED GRADE. PROVIDE CONTINUOUS DETECTABLE RED WARNING TAPE IN BACKFILL 12" BELOW FINISHED GRADE ("CAUTION – BURIED ELECTRIC LINE BELOW").
- 5 SEE DIAGRAM 3/E0-02 FOR ENCLOSED CIRCUIT BREAKER SERVICE DISCONNECT GROUNDING AND BONDING DETAILS.
- 6 SEE EXHAUST FAN WIRING DIAGRAM 2/E0-02.
- (7) RECEPTACLE OUTLET FOR GAS-FIRED INSTANTANEOUS WATER HEATERS. EXACT MOUNTING LOCATION TO BE FIELD-COORDINATED WITH MECHANICAL PIPING.
- 8 CONTROL POWER TRANSFORMER (TRANSFORMER & LOW VOLTAGE CONTROL WIRING PROVIDED BY CONTROLS CONTRACTOR). PRIMARY CIRCUIT TO BE PROVIDED BY ELECTRICAL CONTRACTOR. NOTE: TRANSFORMER TO BE PROVIDED WITH FACTORY-INSTALLED PRIMARY AND SECONDARY FUSE BLOCKS WITH FUSES AS REQUIRED.
- (9) MASTER SWITCH CONTROL FOR EXTERIOR RECEPTACLE OUTLETS (PROVIDE LABEL).
- (10) TO TOGGLE SWITCH ADJACENT TO PANEL "SEB" IN CHASE.
- (1) EXTERIOR LIGHTING MAINTENANCE SWITCH (PROVIDE LABEL). SEE EXTERIOR LIGHTING CONTROL WIRING DIAGRAM 1/E0-02.
- (12) OUTDOOR PHOTOSENSOR FOR CONTROL OF EXTERIOR LIGHTING FIXTURES (SEE EXTERIOR LIGHTING CONTROL WIRING DIAGRAM 1/E0-02 FOR DETAILS). MOUNT TO ROOF LINE FASCIA ON NORTH SIDE OF BUILDING.
- (13) SECURE LIGHTING FIXTURE TO UNDERSIDE OF ROOF JOISTS.
- (14) CHAIN-SUSPEND LIGHTING FIXTURE 8'-0" A.F.F. EXACT LOCATION TO BE FIELD-COORDINATED WITH MECHANICAL PIPING & DUCTWORK.
- (15) POWER RELAY PACK WITH OCCUPANCY SENSORS FOR CONTROL OF BATHROOM LIGHTING FIXTURES. CONNECT PER MANUFACTURER'S WIRING INSTRUCTIONS.
- (16) MASTER-OFF SWITCHES FOR MEN'S & WOMEN'S ROOM LIGHTING FIXTURES (PROVIDE LABELS). CONNECT PER OCCUPANCY SENSOR MANUFACTURER'S WIRING INSTRUCTIONS.
- (17) JUNCTION BOX FOR HAND DRYER (510W, 120V, 10). FIELD-COORDINATE EXACT LOCATION AND PROVIDE ALL CIRCUITING TO HAND DRYER AS REQUIRED PER DRYER MANUFACTURER'S INSTALLATION INSTRUCTIONS.
- 18 TIME CLOCK CONTROLS FOR EXHAUST FANS EF/4 (TIME CLOCK & CONTROL WIRING TO EXHAUST FANS PROVIDED BY CONTROLS CONTRACTOR). POWER SUPPLY CIRCUIT TO BE PROVIDED BY ELECTRICAL CONTRACTOR.

RD "SEB" SCHEDULE							
AST BATH HOUSE TYPE: 240/120V, 1Ø, 3W VICE DISCONNECT) IG EXTERIOR MAIN LUGS: 225A							
RKR SIZE	CIR NO		<sup>م</sup> 4	3¢	CIR NO	BRKR SIZE	DESCRIPTION
20A	1	$\bigcirc$		$\sum$	2	20A	REC – MEN'S ROOM
20A	3	$\left  \bigcap \right $		$\sum_{i=1}^{n}$	4	20A	REC – MEN'S ROOM
20A	5	$\bigcirc$	-	$\sum_{i=1}^{n}$	6	20A	REC – WOMEN'S ROOM
20A	7	$\bigcap$	-	$\sum_{i=1}^{n}$	8	20A	REC – WOMEN'S ROOM
20A	9	$\bigcirc$		$\sum$	10	20A	REC – CHASE
20A	11	$\frown$	-	$\frown$	12	20A	REC – EXTERIOR
20A	13	$\frown$		$\frown$	14	20A	REC – INST. WTR. HTRS. (MEN'S)
20A	15	$\cap$		$\frown$	16	20A	REC – INST. WTR. HTRS. (WOMEN'S)
20A	17	$\frown$		$\frown$	18	15A	EXHAUST FAN (MEN'S)
20A	19	$\cap$		$\frown$	20	15A	EXHAUST FAN (WOMEN'S)
20A	21	$\bigcirc$		$\sum$	22	15A	EXH. FAN TIME CLOCK CONTROLS
20A	23	$\left  \bigcap \right $		$\bigcirc$	24	20A	CONTROL POWER XFMR
20A	25	$\bigcirc$	-	$\sum_{i=1}^{n}$	26	20A	SPARE
204	27	$  \bigcap$		$\cap$	28	20A	SPARE
50A	29	$\bigcap$		$\sum$	30	20A	SPARE


UL SHORT CIRCUIT CURRENT RATING OF PANELBOARD AND UL INTERRUPT RATINGS OF ALL CIRCUIT BREAKERS WITHIN PANELBOARD SHALL BE COORDINATED WITH AVAILABLE FAULT CURRENT AT PANELBOARD PRIOR TO PURCHASING EQUIPMENT. COORDINATE WITH ELECTRIC UTILITY AND SITE ENGINEER.

2. ALL CIRCUIT BREAKERS WITHIN PANELBOARD SHALL BE HACR RATED.

CONTRACT	BRIDGE NO.	Х
T200507303		
1200001000	DRAWN BY:	АНН
COUNTY		2001
SUSSEX	CHECKED BY:	JRF


EXIST. SOUTHEAST BATH HOUSE **BUILDING 8** ELECTRICAL PLAN E8-01

SHEET NO. CD268 TOTAL SHTS. CD282

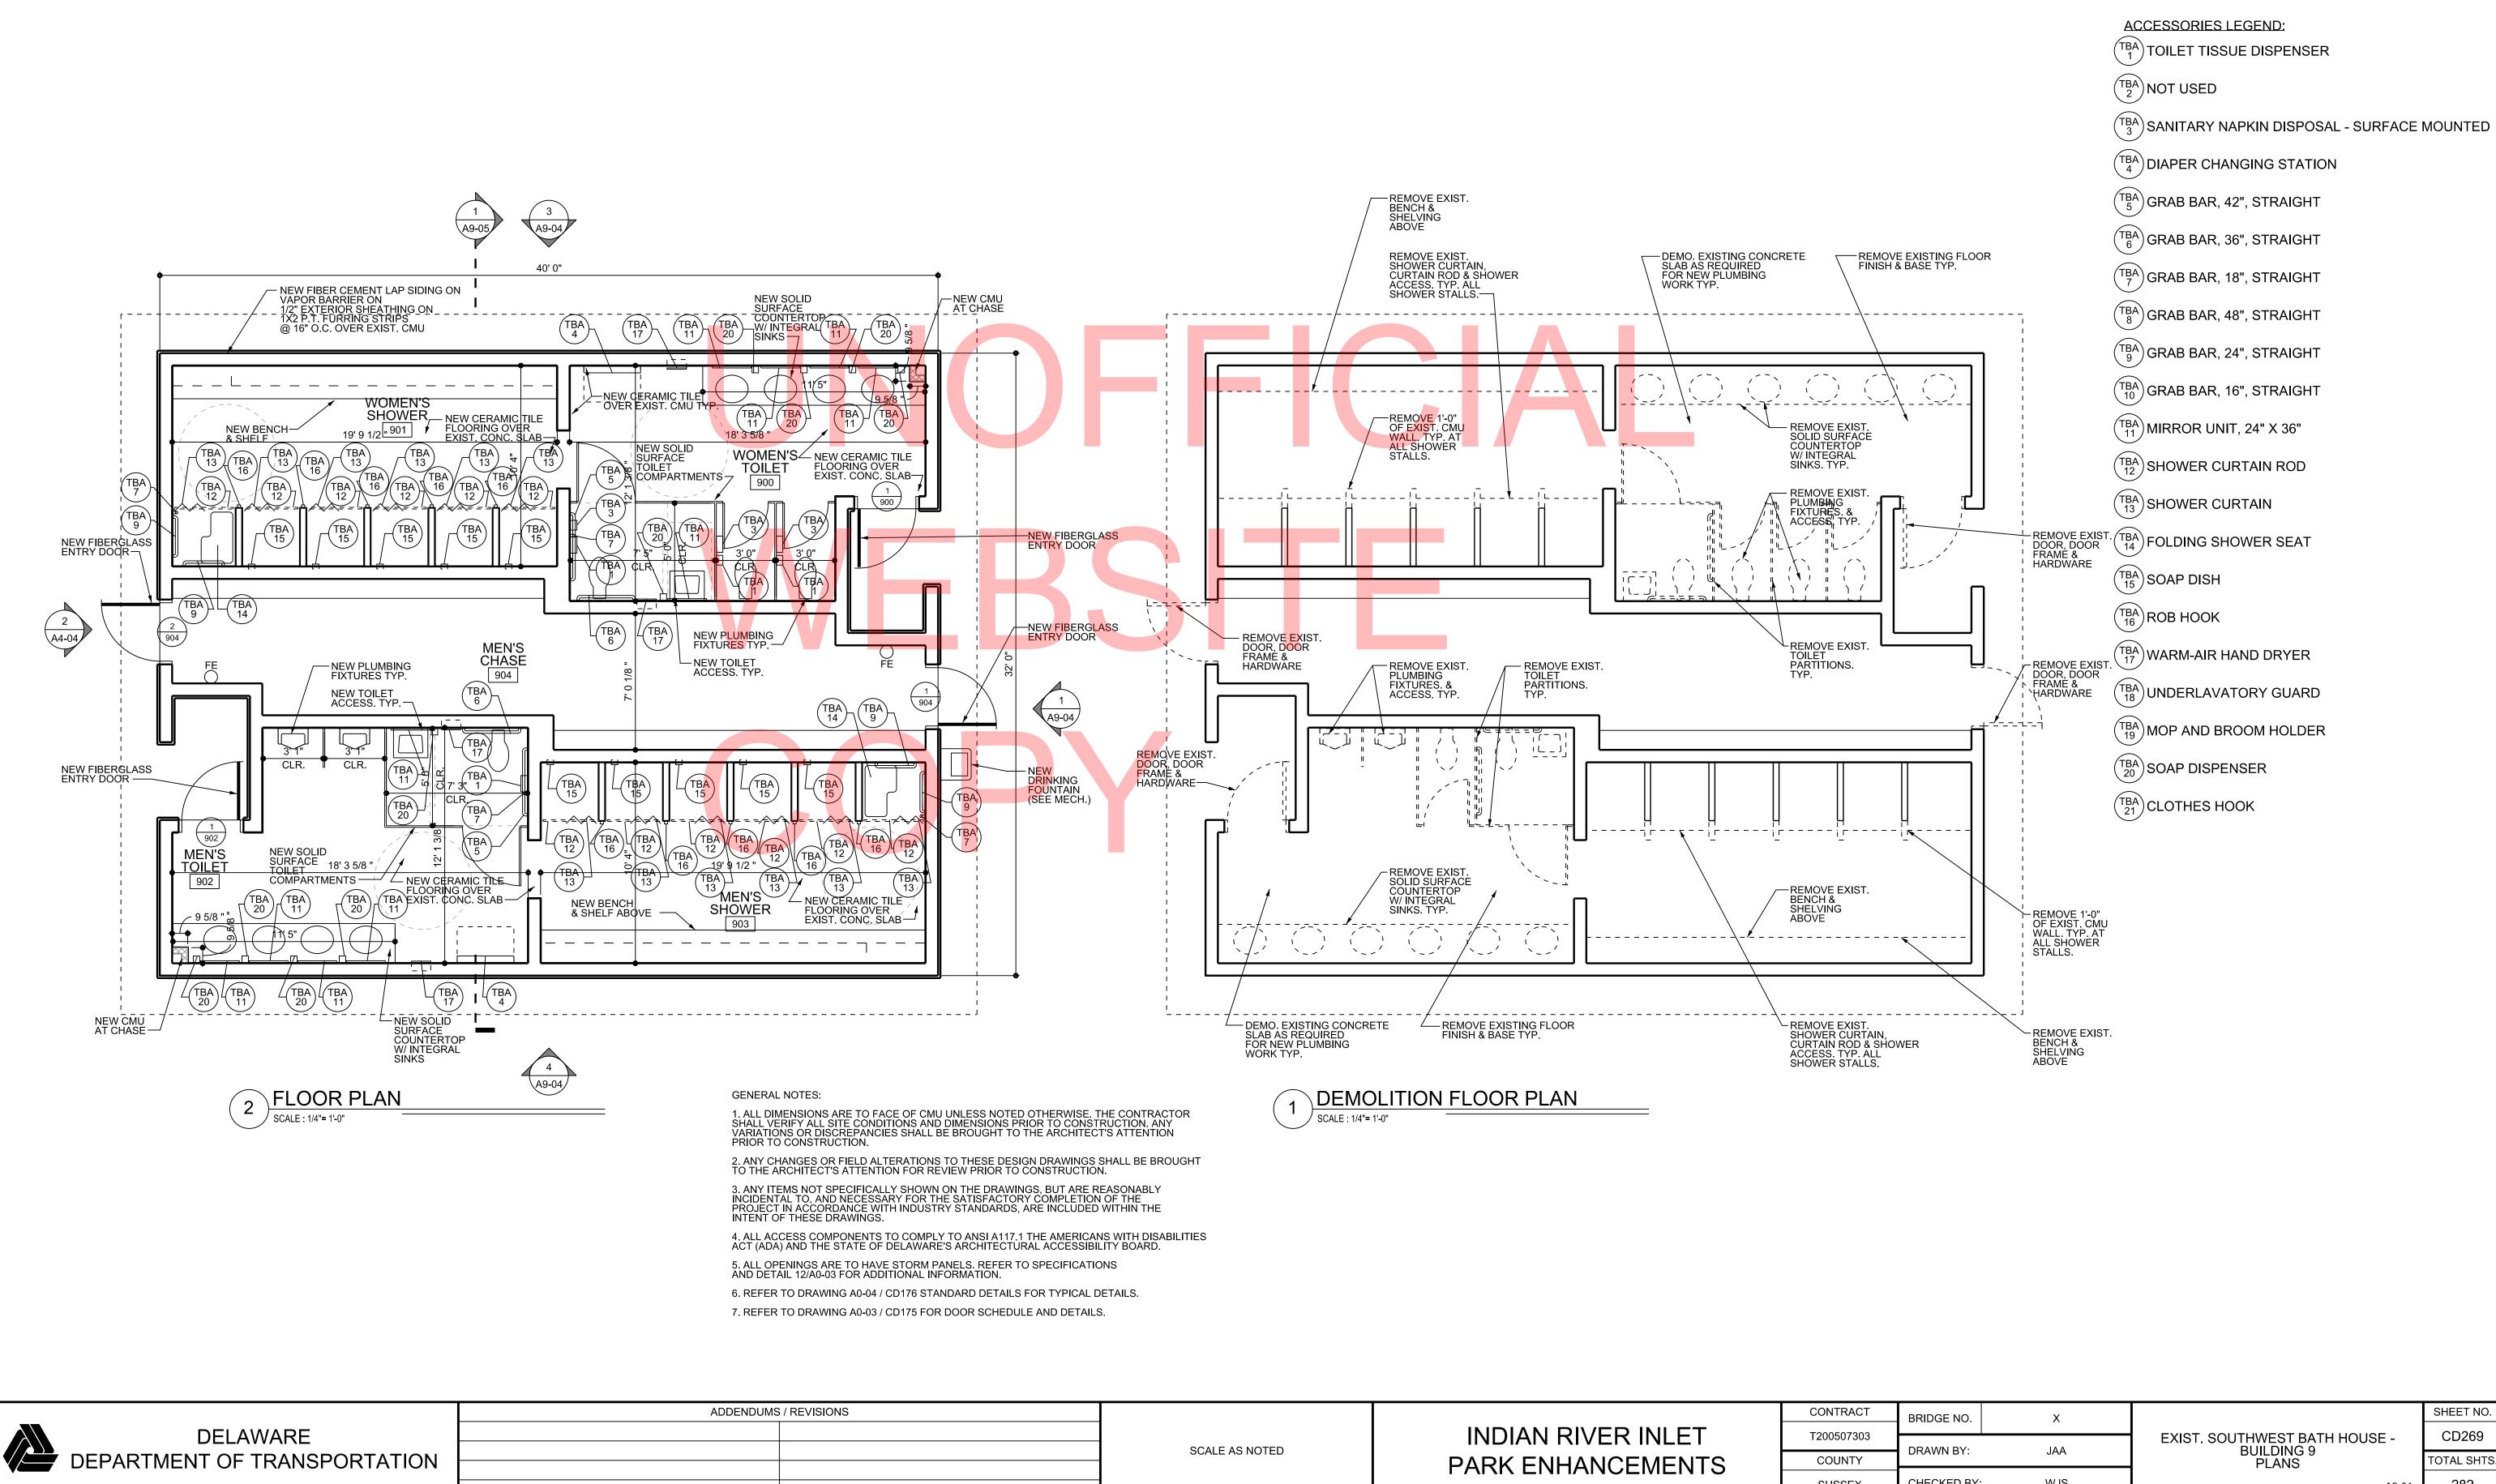

	INDIAN RIVER I
SCALE AS NOTED	
	PARK ENHANCEI


CONTRACT	BRIDGE NO.	X		SHEET NO.
T200507303		- •		CD269
1200507505	DRAWN BY:	JAA	EXIST. SOUTHWEST BATH HOUSE - BUILDING 9	00209
COUNTY		374	PLANS	TOTAL SHTS.
SUSSEX	CHECKED BY:	WJS	A9-01	282

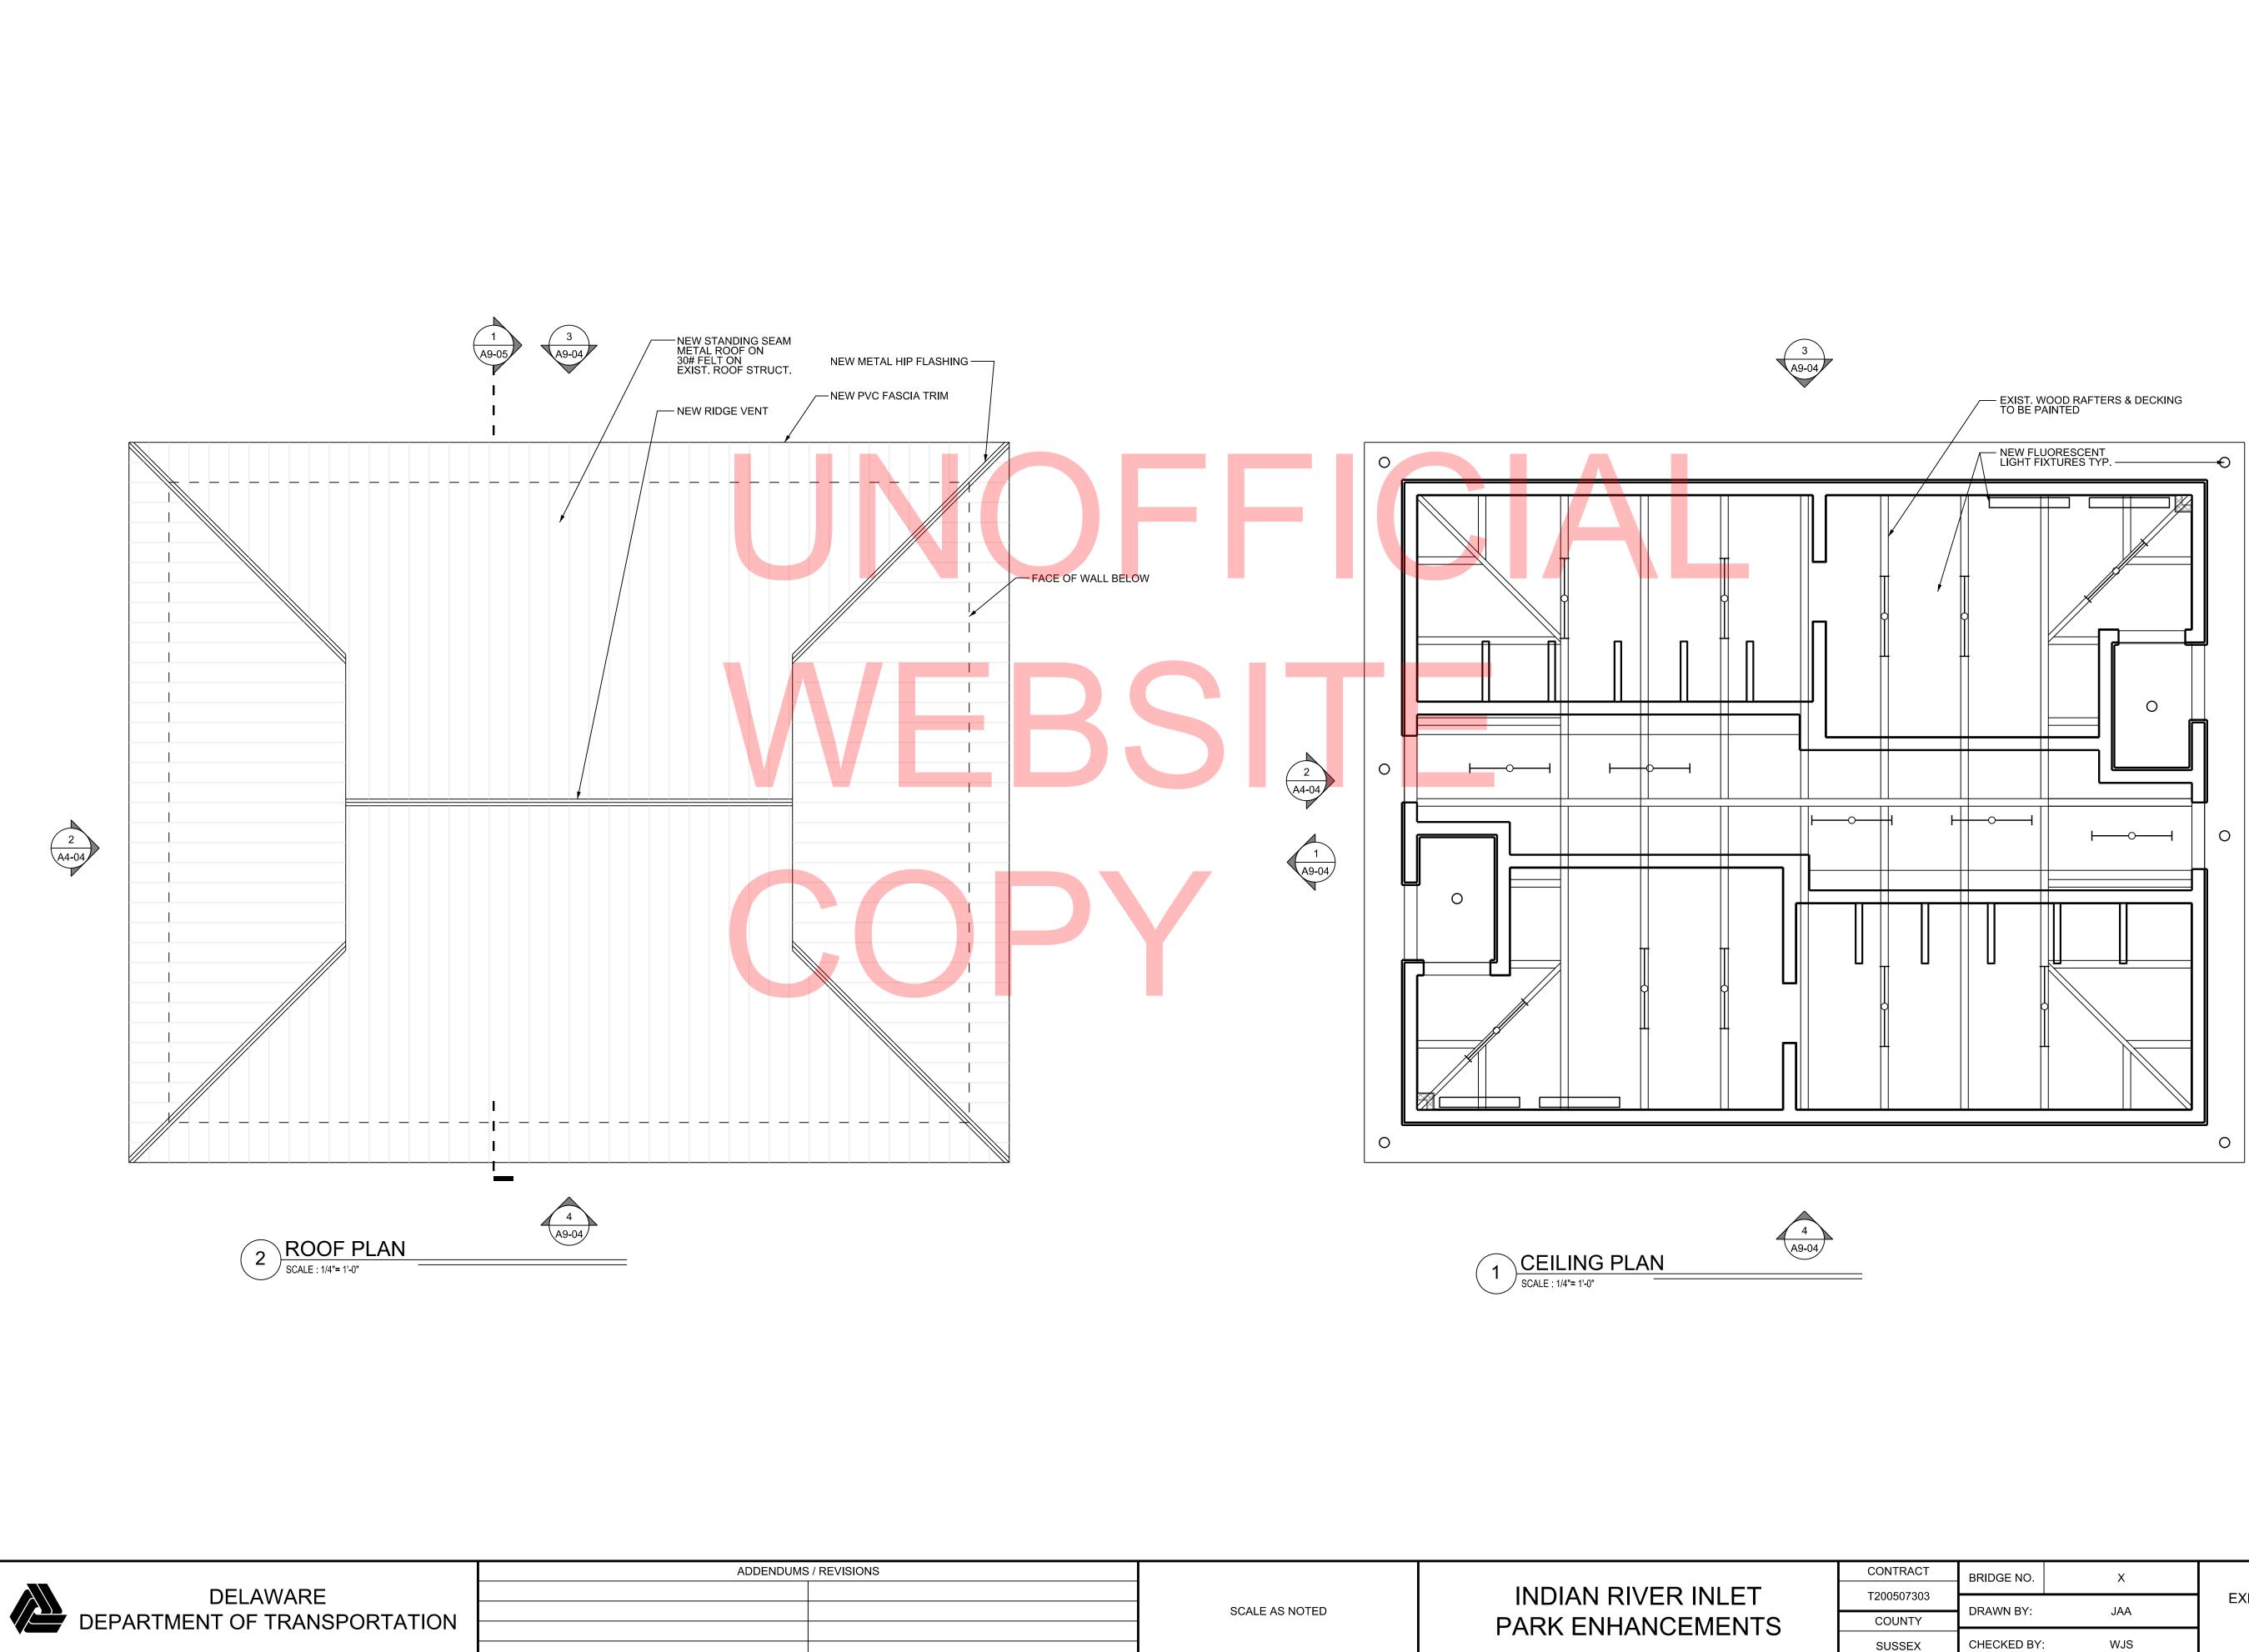

S / REVISIONS		
	SCALE AS NOTED	INDIAN RIVER INLET
		PARK ENHANCEMENTS




CONTRACT	BRIDGE NO.	Х		SHEET NO.
Г200507303			EXIST. SOUTHWEST BATH HOUSE -	CD270
COUNTY	DRAWN BY:	JAA	BUILDING 9 PLANS	TOTAL SHTS.
SUSSEX	CHECKED BY:	WJS	A9-02	282

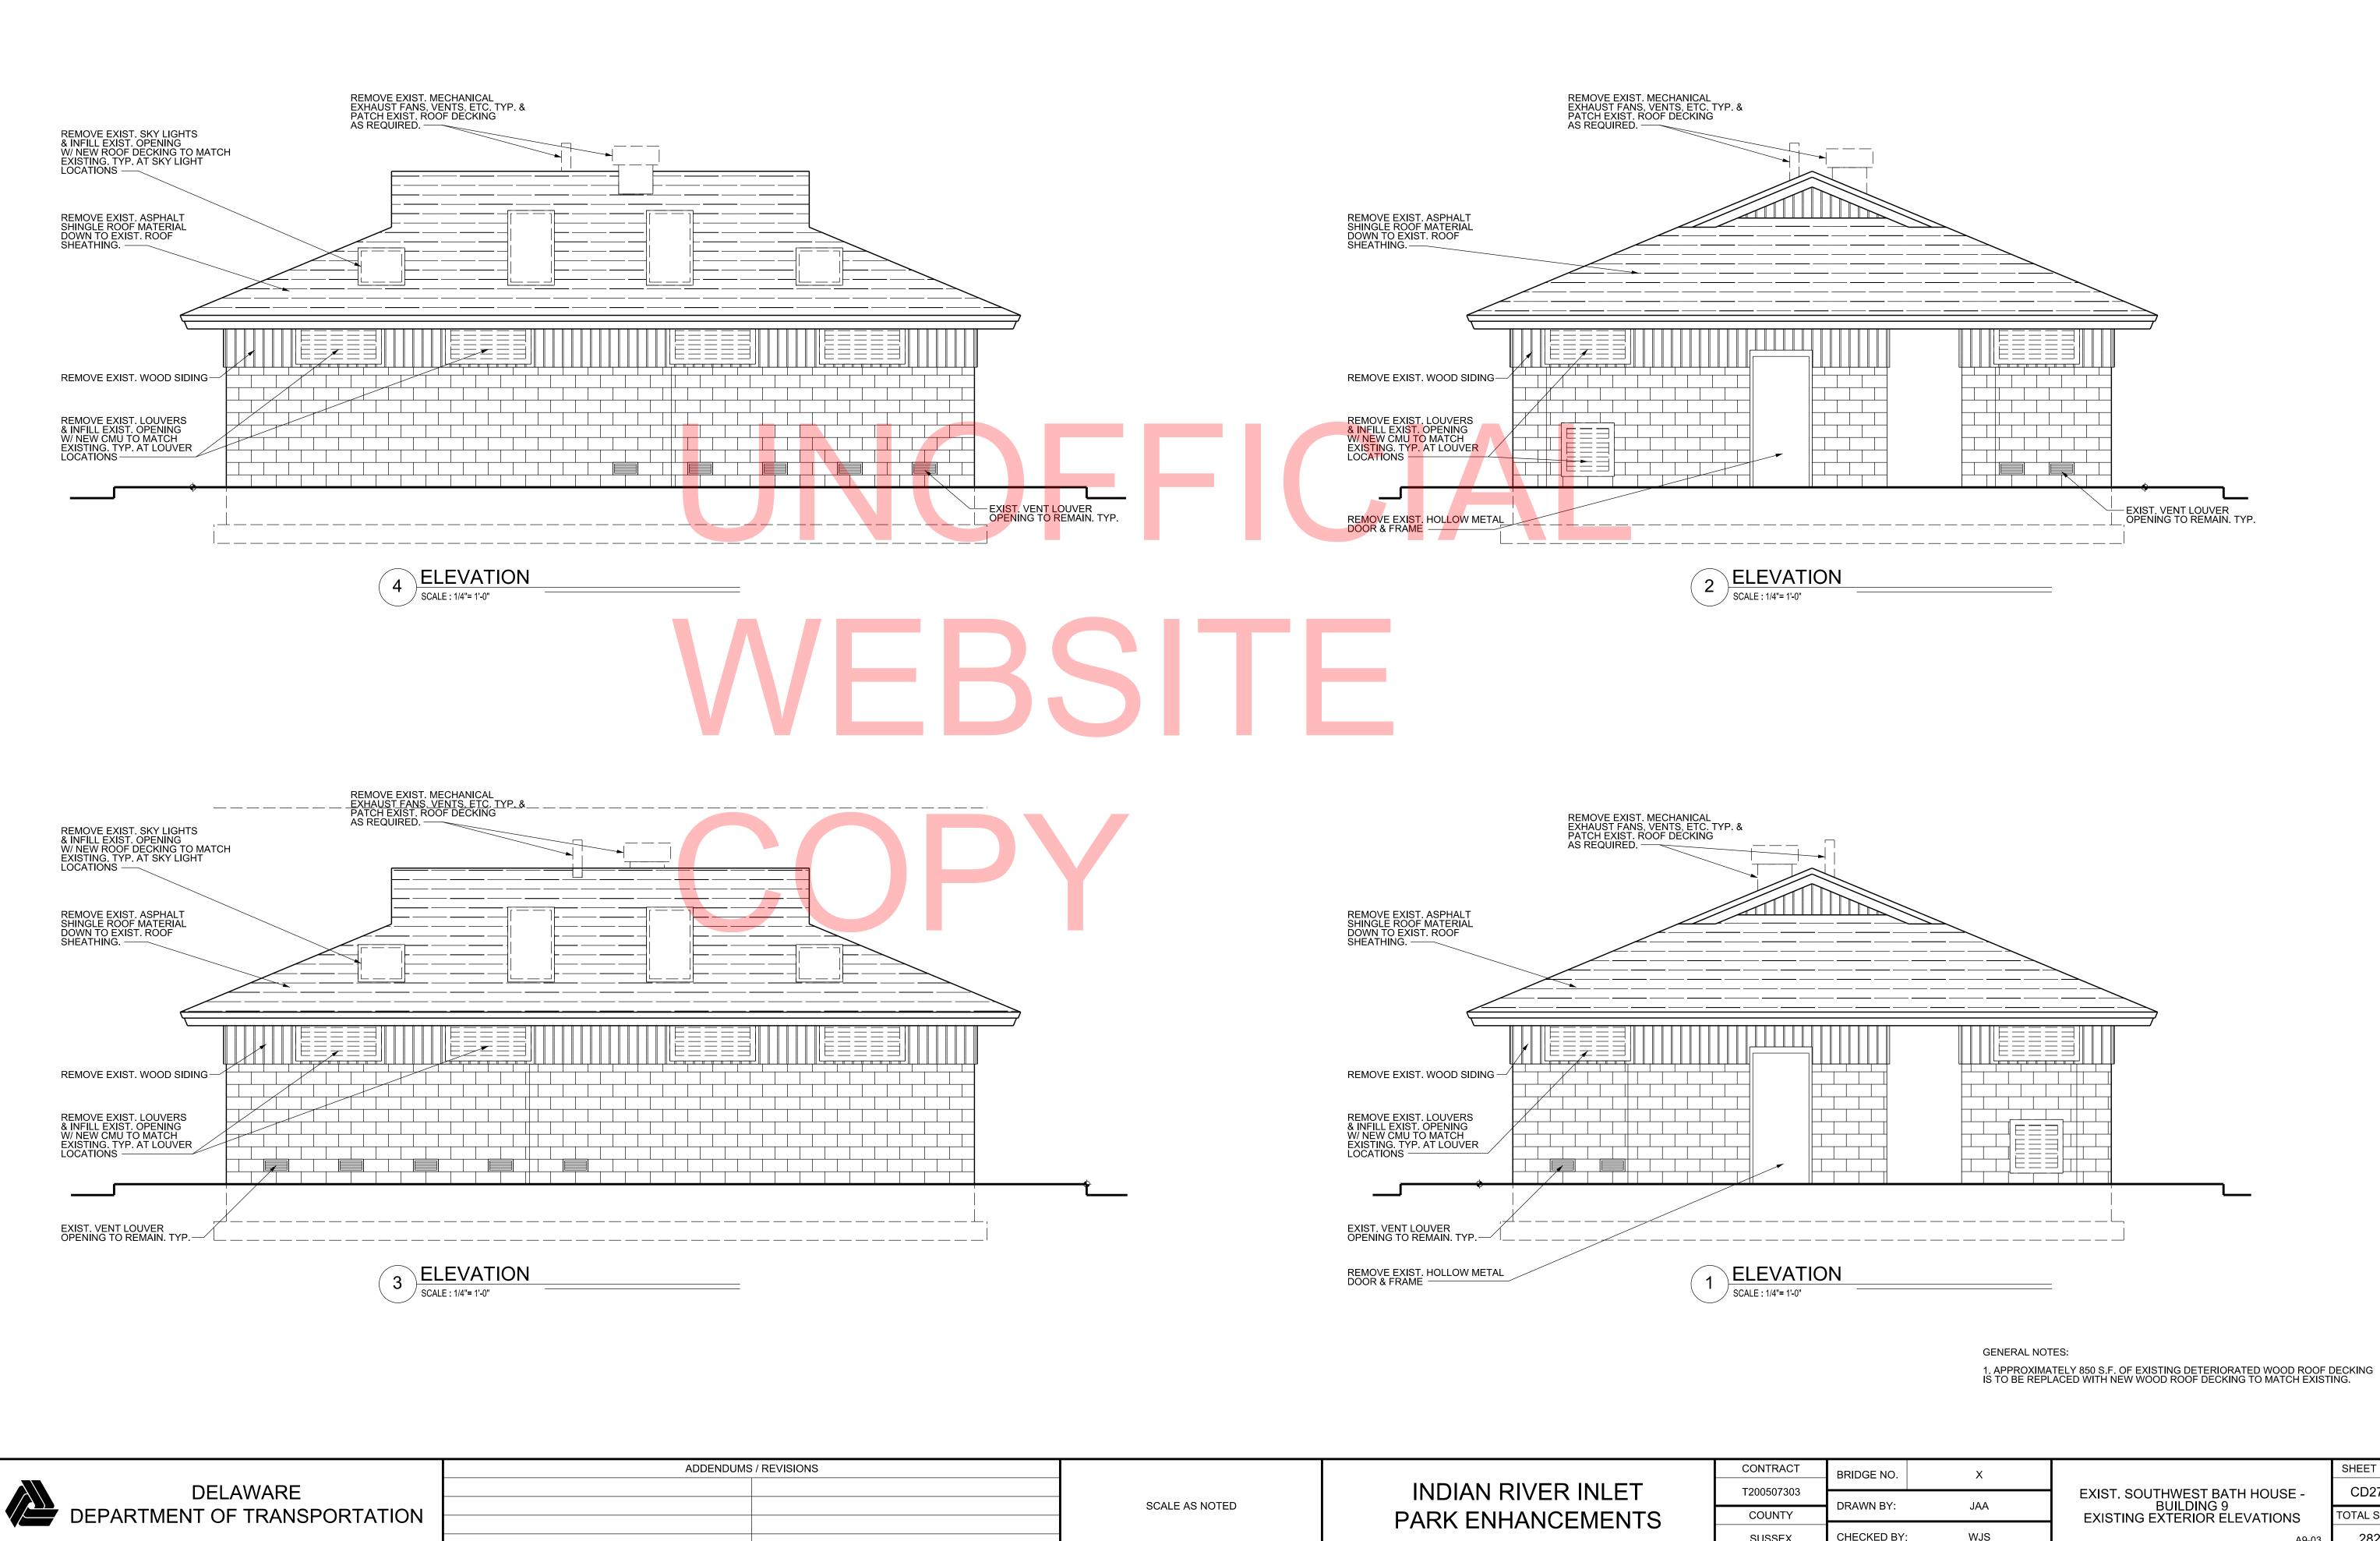




CONTRACT	BRIDGE NO.	Х		SHEET NO.
200507303			EXIST. SOUTHWEST BATH HOUSE -	CD271
COUNTY	DRAWN BY:	JAA	BUILDING 9 EXISTING EXTERIOR ELEVATIONS	TOTAL SHTS.
SUSSEX	CHECKED BY:	STM	A9-03	282

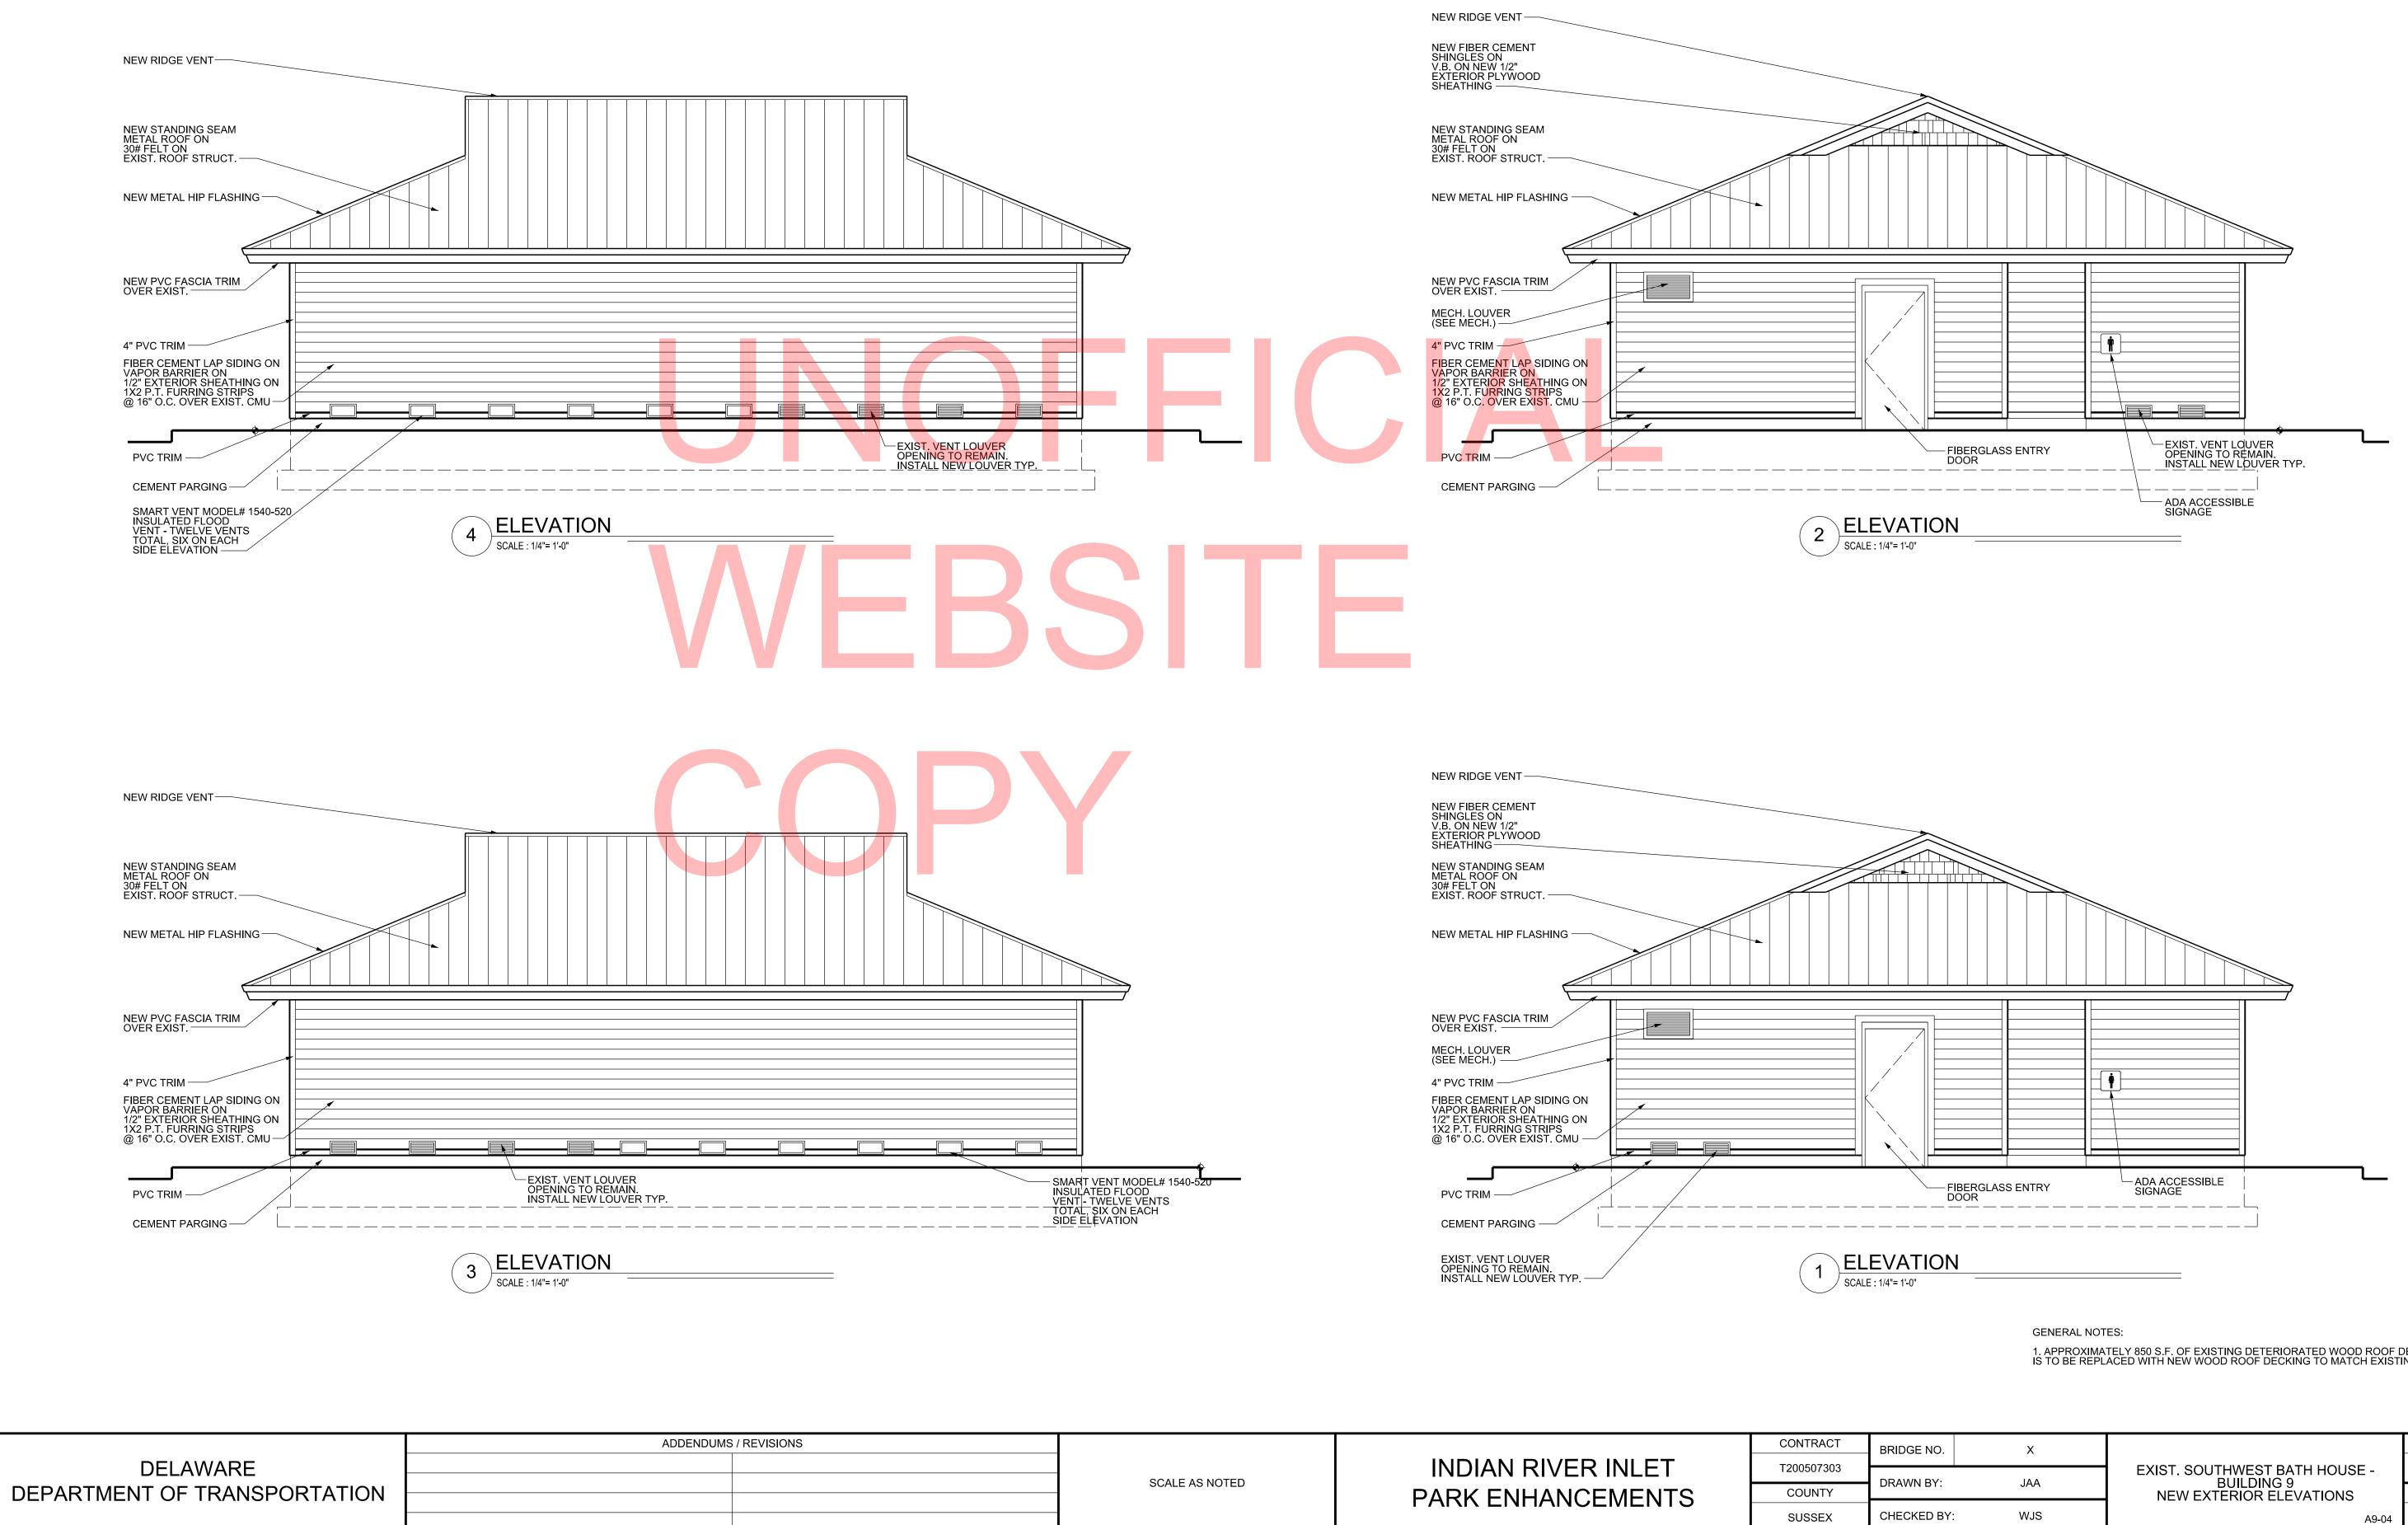


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BRIDGE NO.     X       T200507303     DRAWN BY:     JAA       COUNTY     JAA       EXIST. SOUTHWEST BATH HOUSE - BUILDING 9 NEW EXTERIOR ELEVATIONS     CD272       TOTAL SHTS.	SCALE	E : 1/4"= 1'-0"			
BRIDGE NO.     X       T200507303     DRAWN BY:     JAA       COUNTY     JAA       EXIST. SOUTHWEST BATH HOUSE - BUILDING 9 NEW EXTERIOR ELEVATIONS     CD272       TOTAL SHTS.			1. APPROXIMA	TELY 850 S.F. OF EXISTING DETERIORATED WOOD ROOF [	DECKING ING.
COUNTY     DRAWN BY:     JAA     BUILDING 9 NEW EXTERIOR ELEVATIONS     TOTAL SHTS.	CONTRACT	BRIDGE NO.	Х		SHEET NO.
COUNTY NEW EXTERIOR ELEVATIONS TOTAL SHTS.	T200507303				CD272
SUSSEX CHECKED BY: WJS A9-04 282	COUNTY	DRAWN BY:	JAA		TOTAL SHTS.
7.0-04 202	SUSSEX	CHECKED BY:	WJS	A9-04	282

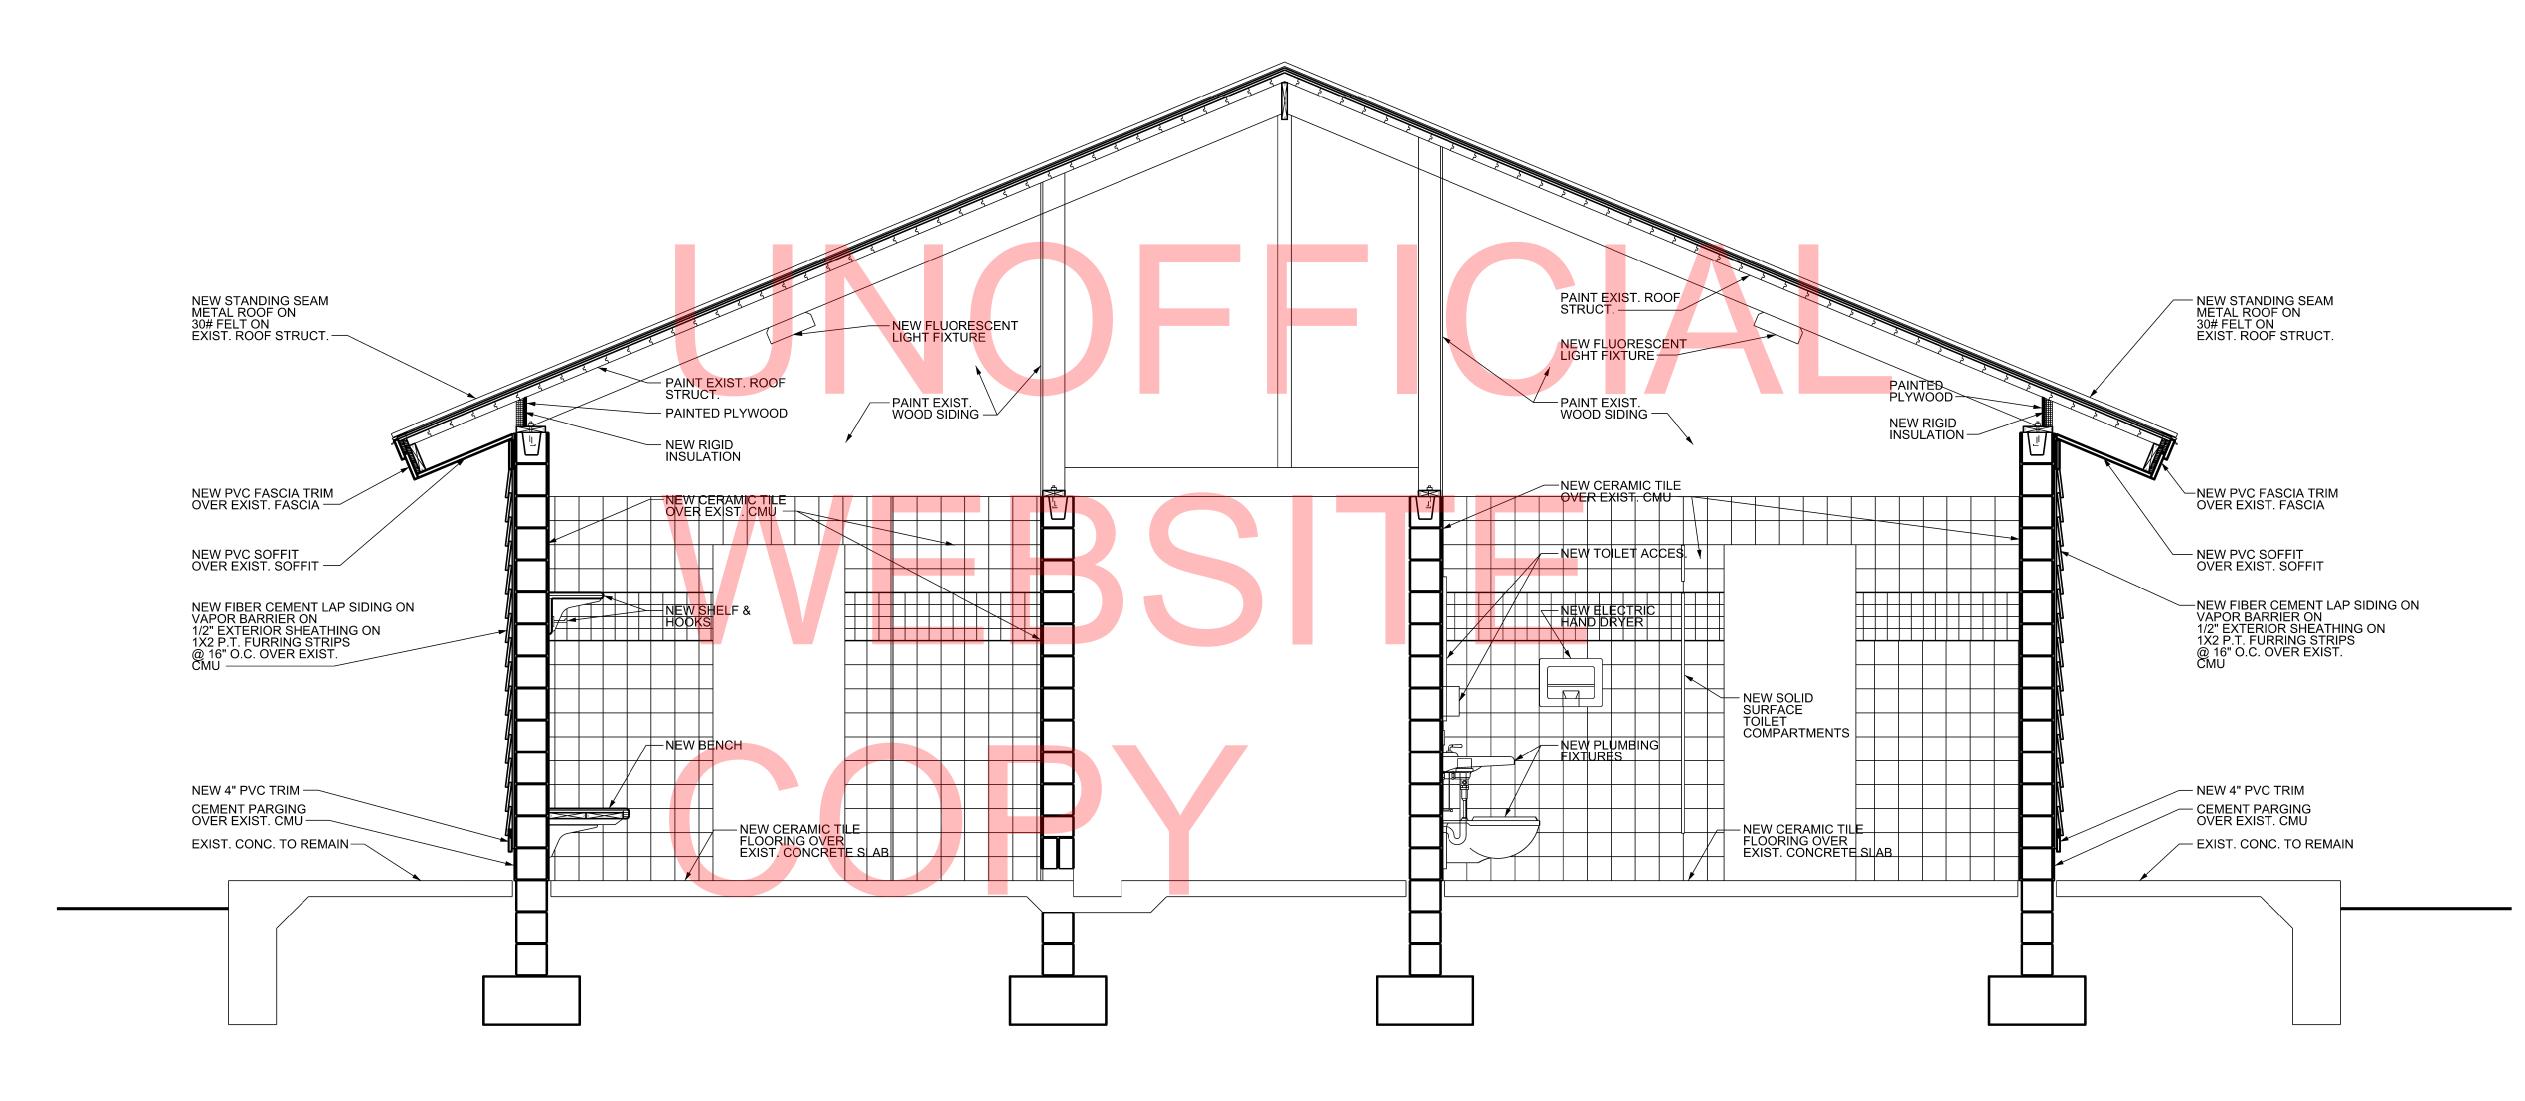

SECTION SCALE : 1/2"= 1'-0"

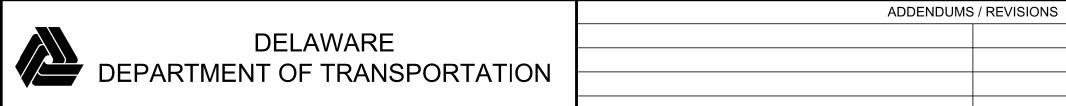


SCALE AS NOTED

### INDIAN RIVER INLET PARK ENHANCEMENTS

CONTRACT	BRIDGE NO.	X	EXIST. SOUTHWEST BATH HOUSE -	SHEET NO.
Г200507303				CD273
	DRAWN BY:	JAA	BUILDING 9	
COUNTY	BIUUUUEU	0, 0, 1	BUILDING SECTION	TOTAL SHTS.
SUSSEX	CHECKED BY:	: WJS	A9-05	282



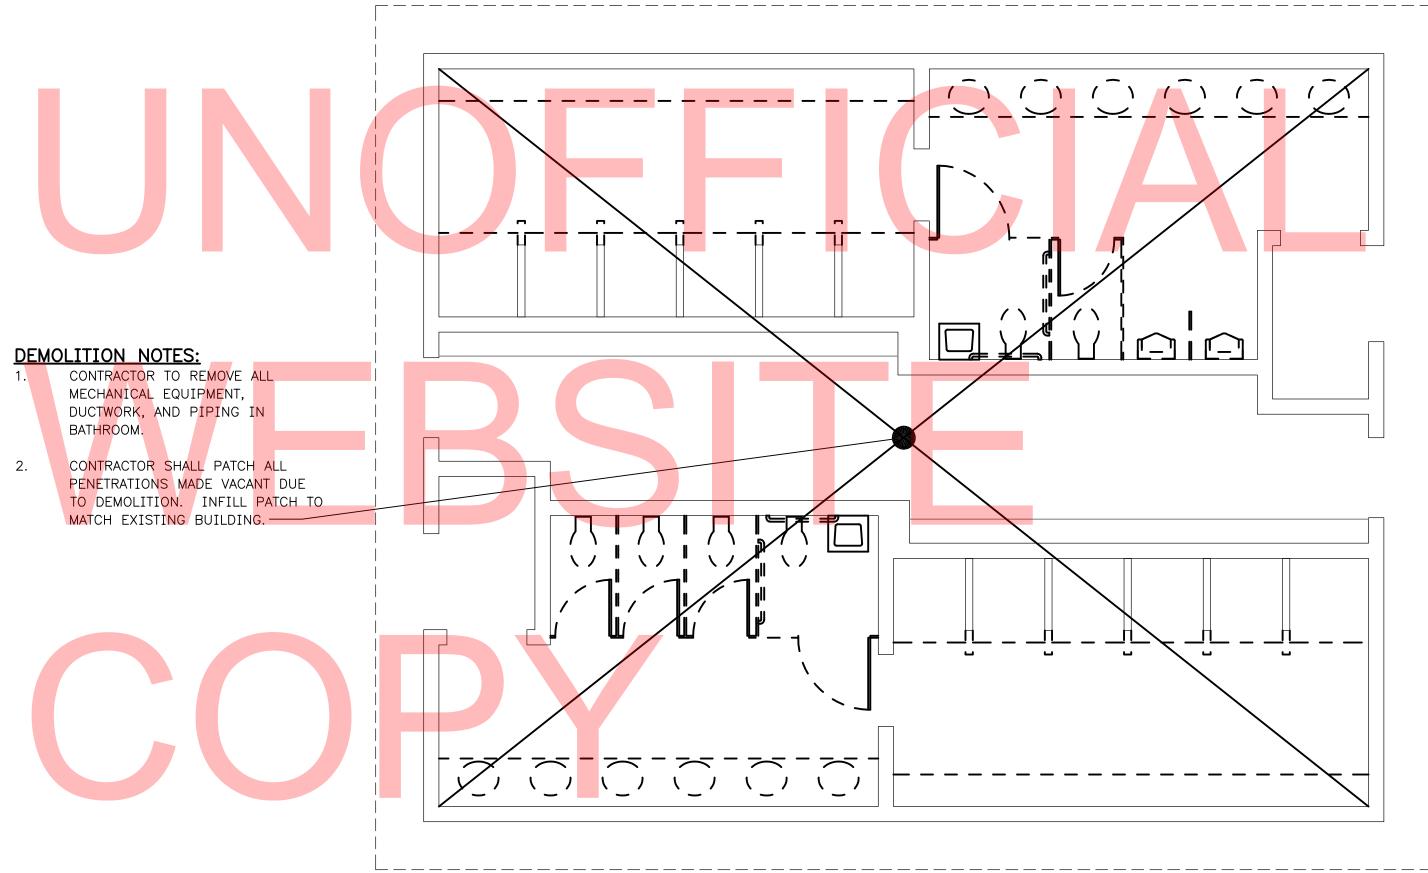



ADDENDUMS / REVISIONS



SCALE AS NOTED


INDIAN RIVER INLET PARK ENHANCEMENTS CONTRACT T200507303 COUNTY SUSSEX

BRIDGE NO. Х MLF DRAWN BY: CHECKED BY: JRF

EXIST. SOUTHWEST BATH HOUSE **BUILDING 9** MECHANICAL DEMOLITION PLAN MD9-01

SHEET NO. CD274

TOTAL SHTS. CD282

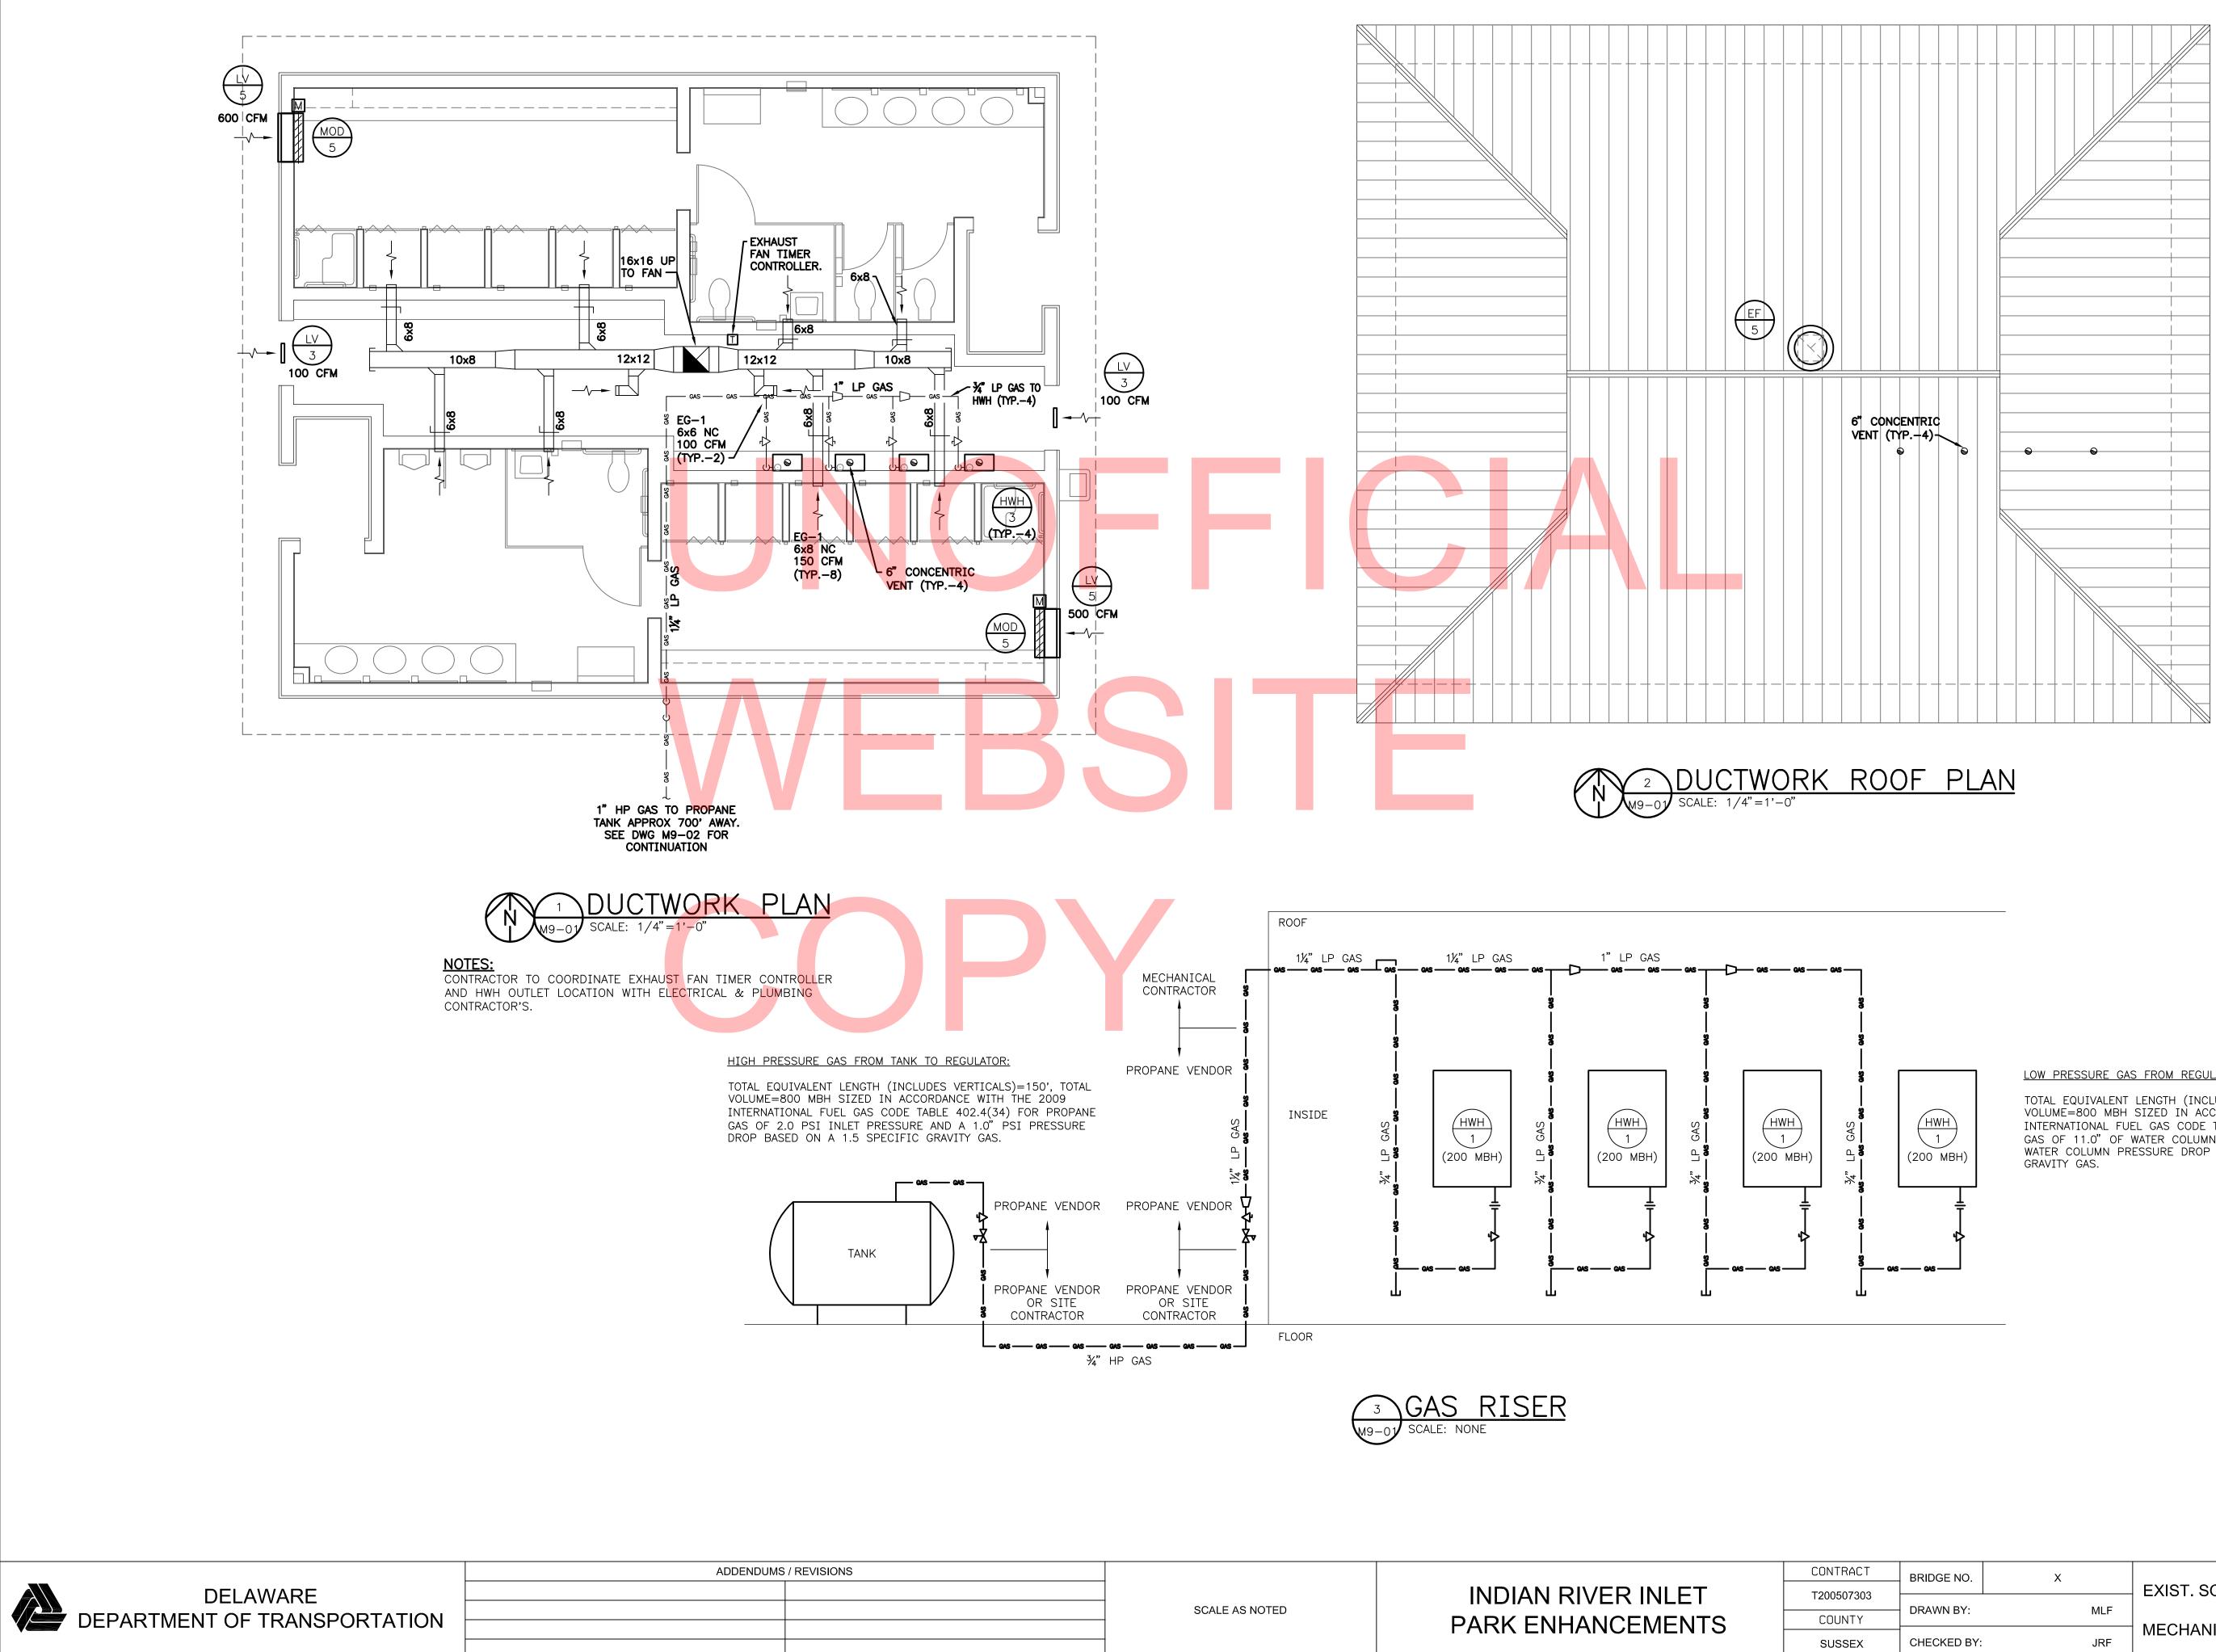

LOW PRESSURE GAS FROM REGULATOR TO EQUIPMENT:

TOTAL EQUIVALENT LENGTH (INCLUDES VERTICALS)=80', TOTAL VOLUME=800 MBH SIZED IN ACCORDANCE WITH THE 2009 INTERNATIONAL FUEL GAS CODE TABLE 402.4(33) FOR PROPANE GAS OF 11.0" OF WATER COLUMN INLET PRESSURE AND A 0.5" OF WATER COLUMN PRESSURE DROP BASED ON A 1.5 SPECIFIC


CONTRACT
T200507303
COUNTY
SUSSEX

BRIDGE NO.	X
DRAWN BY:	MLF
CHECKED BY:	JRF

EXIST. SOUTHWEST BATH HOUSE **BUILDING 9** MECHANICAL PLANS & DIAGRAMS SHEET NO. CD275

TOTAL SHTS. CD282

M9-01

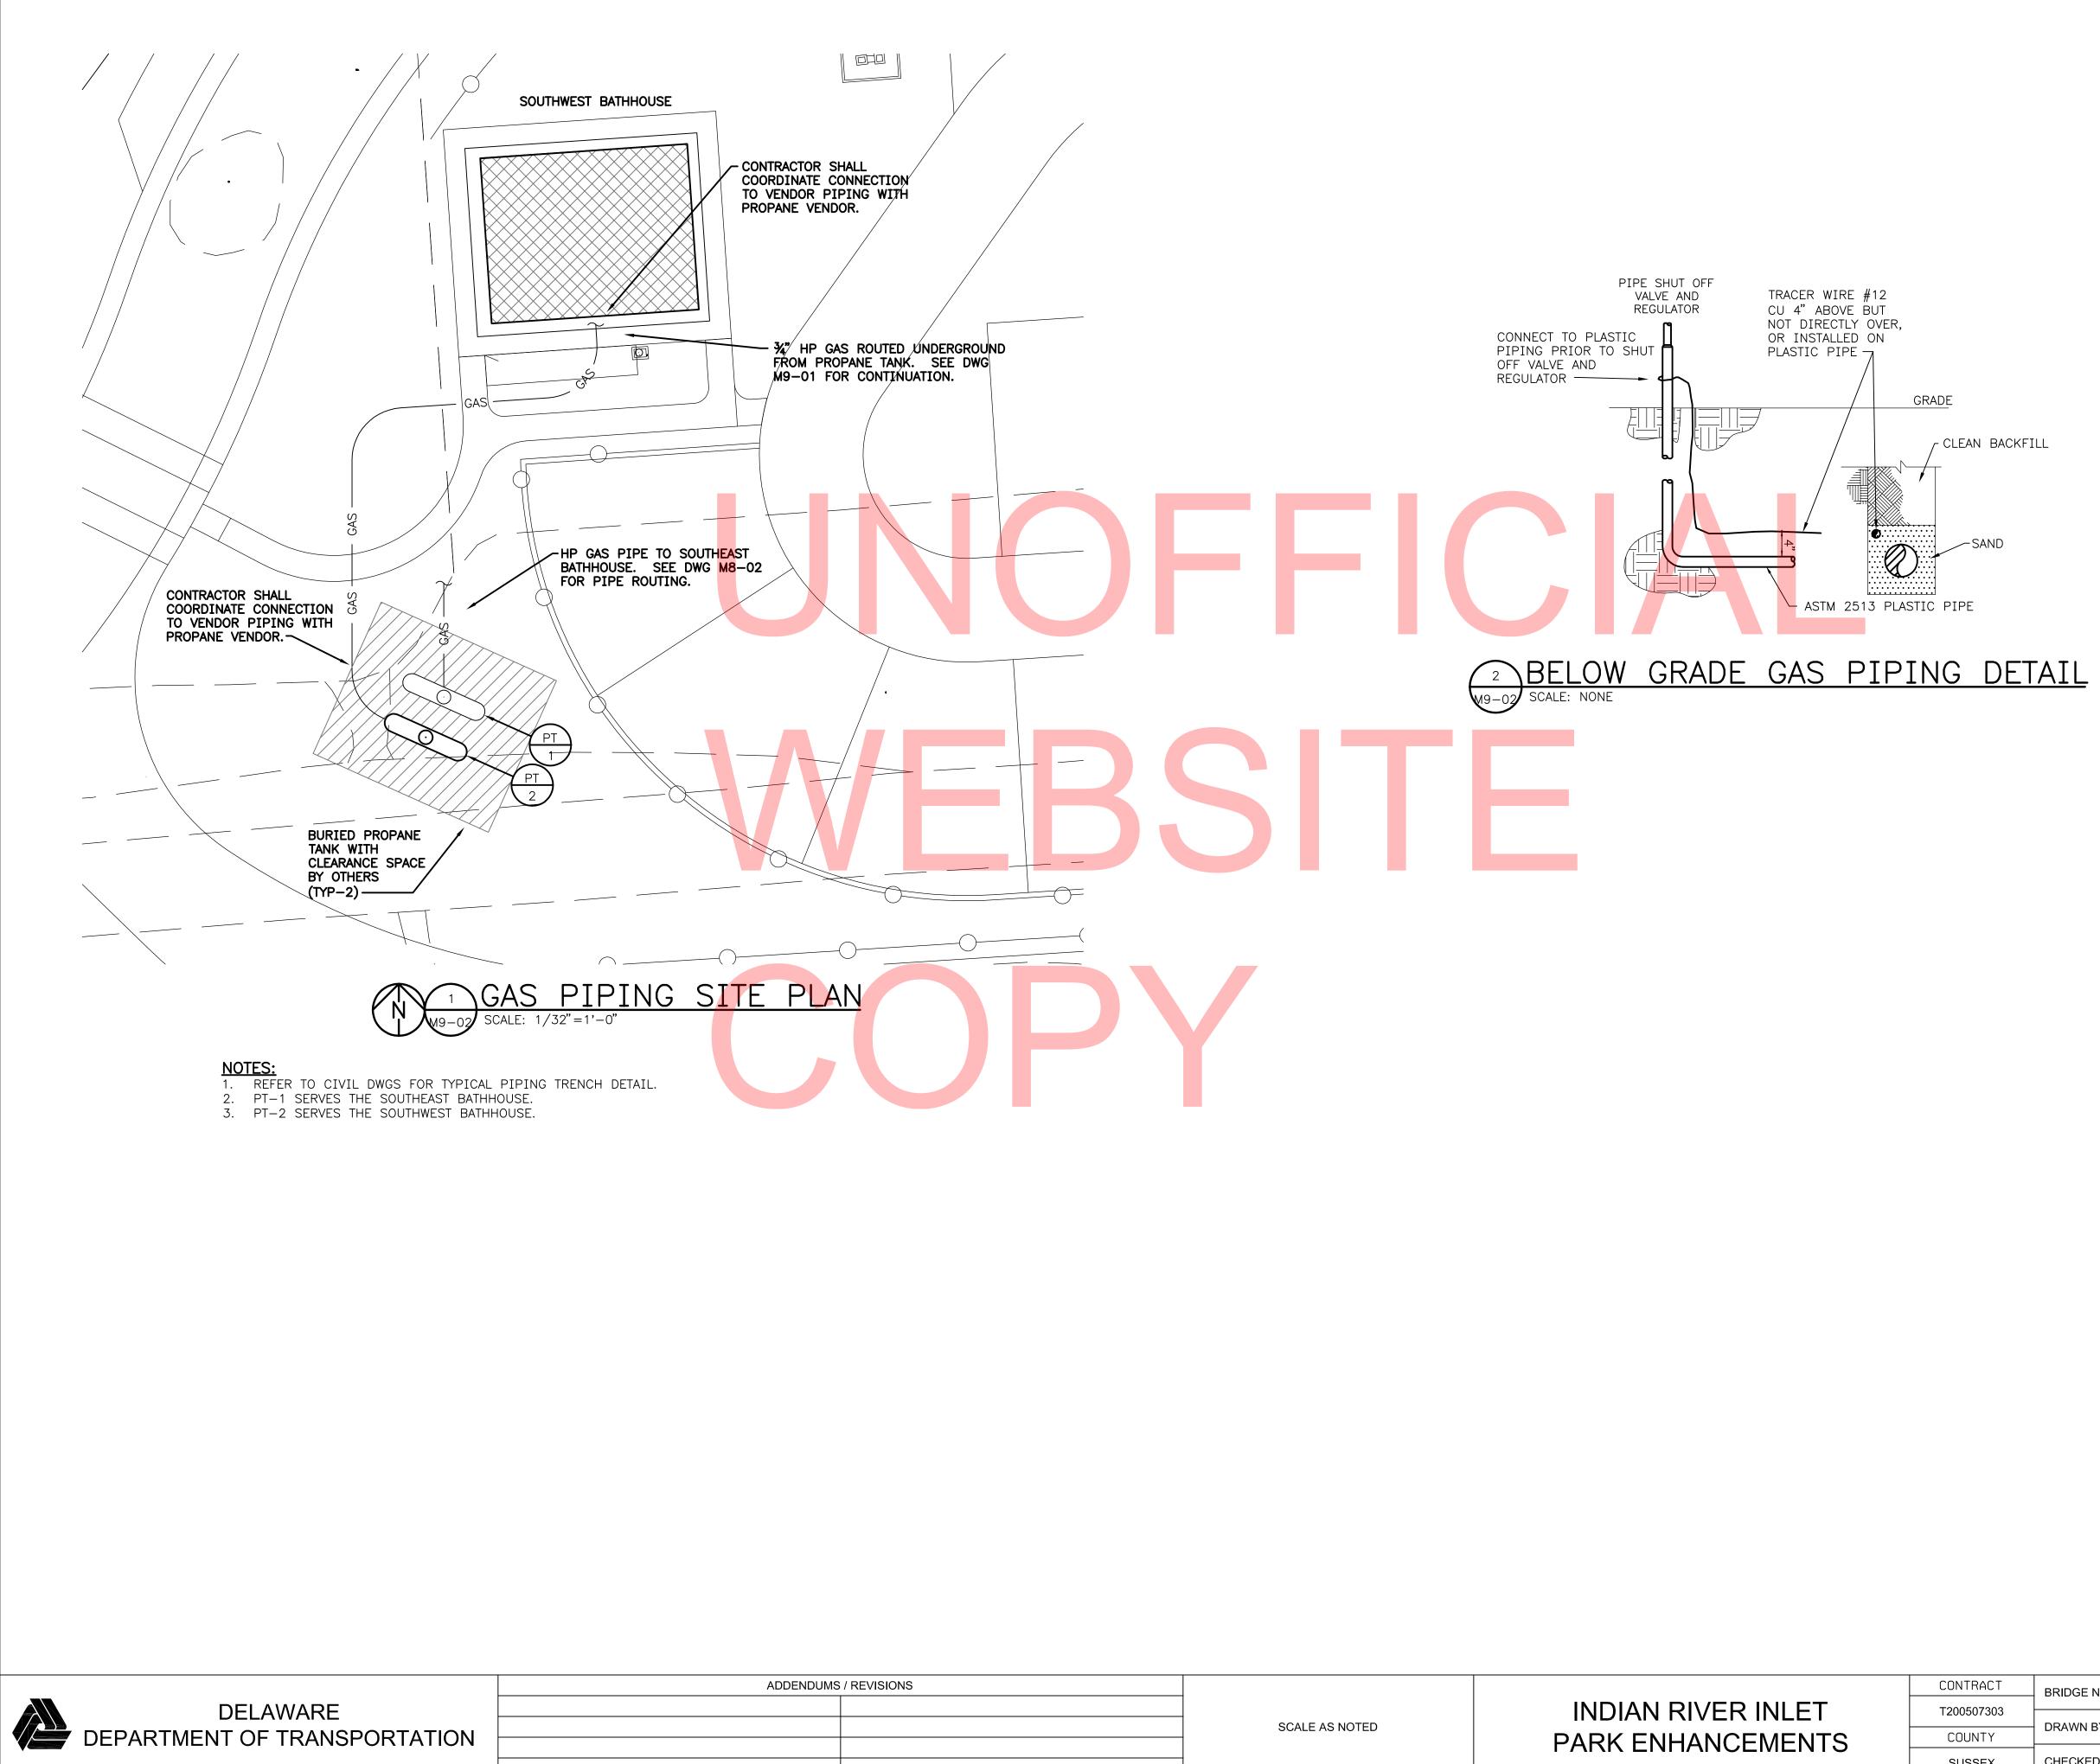


SUSSEX

BRIDGE NO. Х DRAWN BY: MLF JRF CHECKED BY:

EXIST. SOUTHWEST BATH HOUSE **BUILDING 9** GAS PIPING PLAN

SHEET NO. CD276 TOTAL SHTS.

M9-02

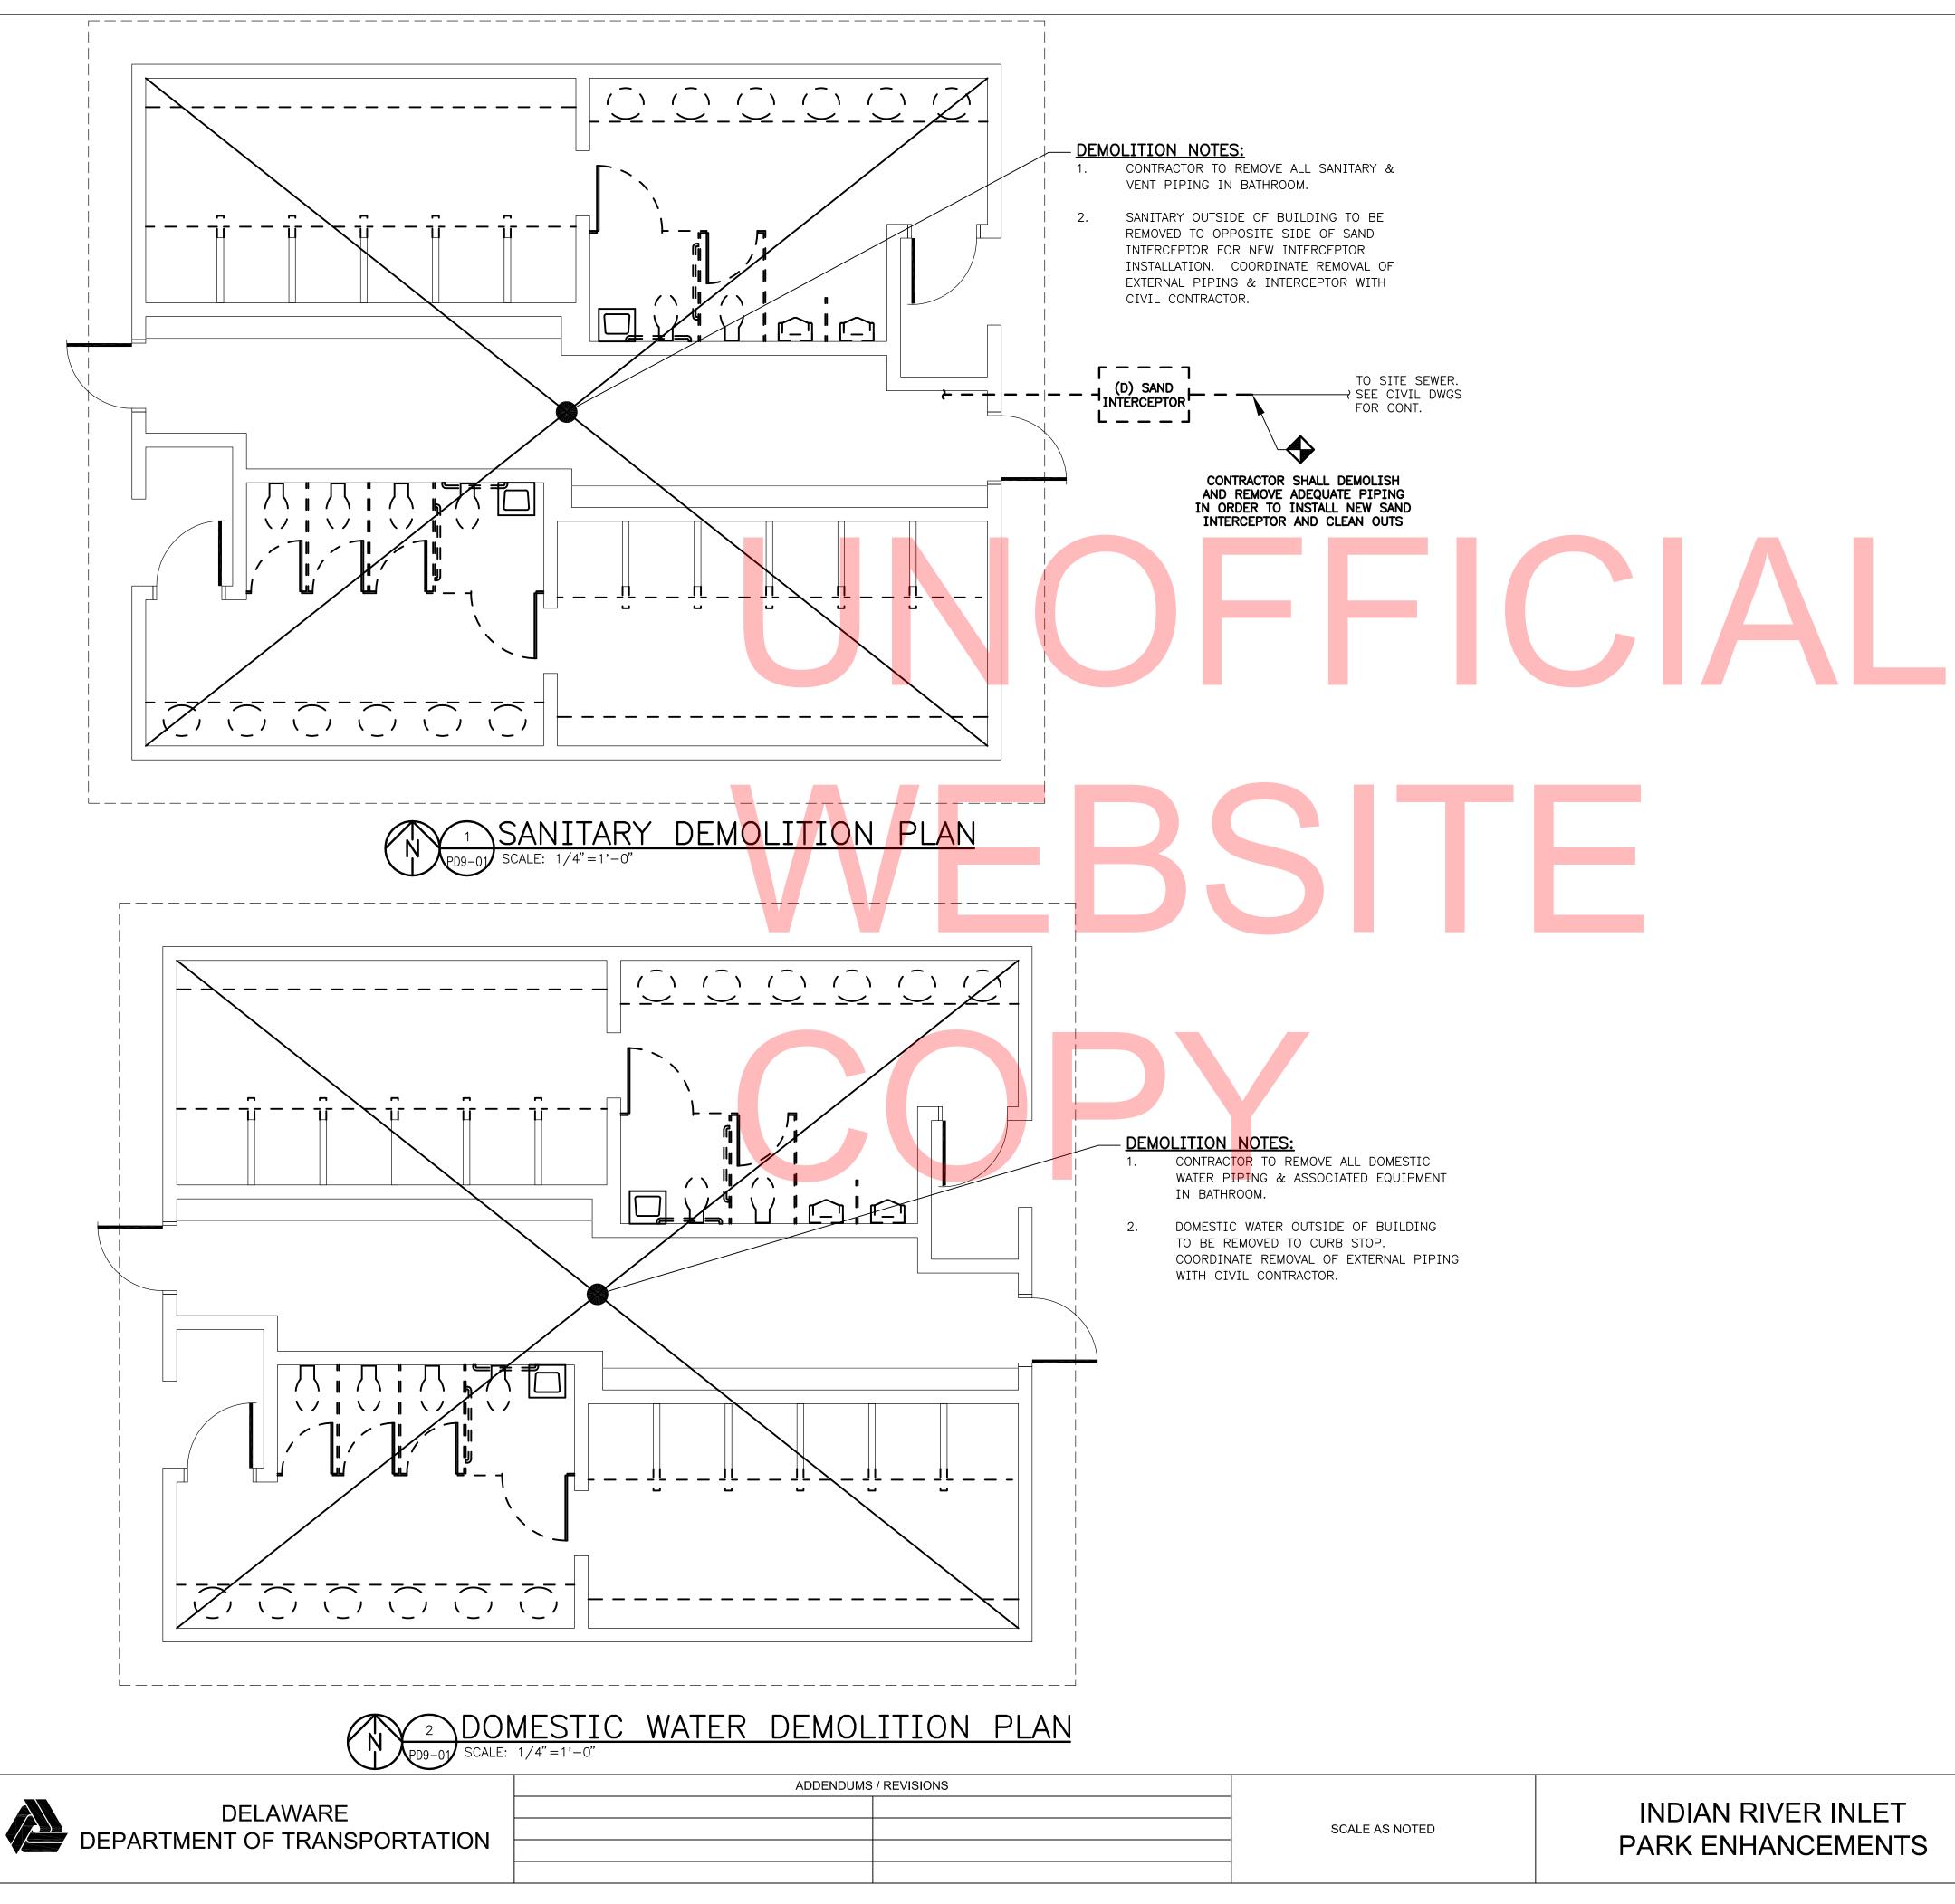


**GENERAL NOTES:** CONTRACTOR SHALL FIELD VERIFY UNDERGROUND PIPING ENTERING THE BUILDING PRIOR TO BEGINNING DEMOLITION.

CONTRACT T200507303 COUNTY SUSSEX

BRIDGE NO. Х MLF DRAWN BY: JRF CHECKED BY:


EXIST. SOUTHWEST BATH HOUSE **BUILDING 9** PLUMBING DEMOLITION PLAN PD9-01

SHEET NO. CD277 TOTAL SHTS.

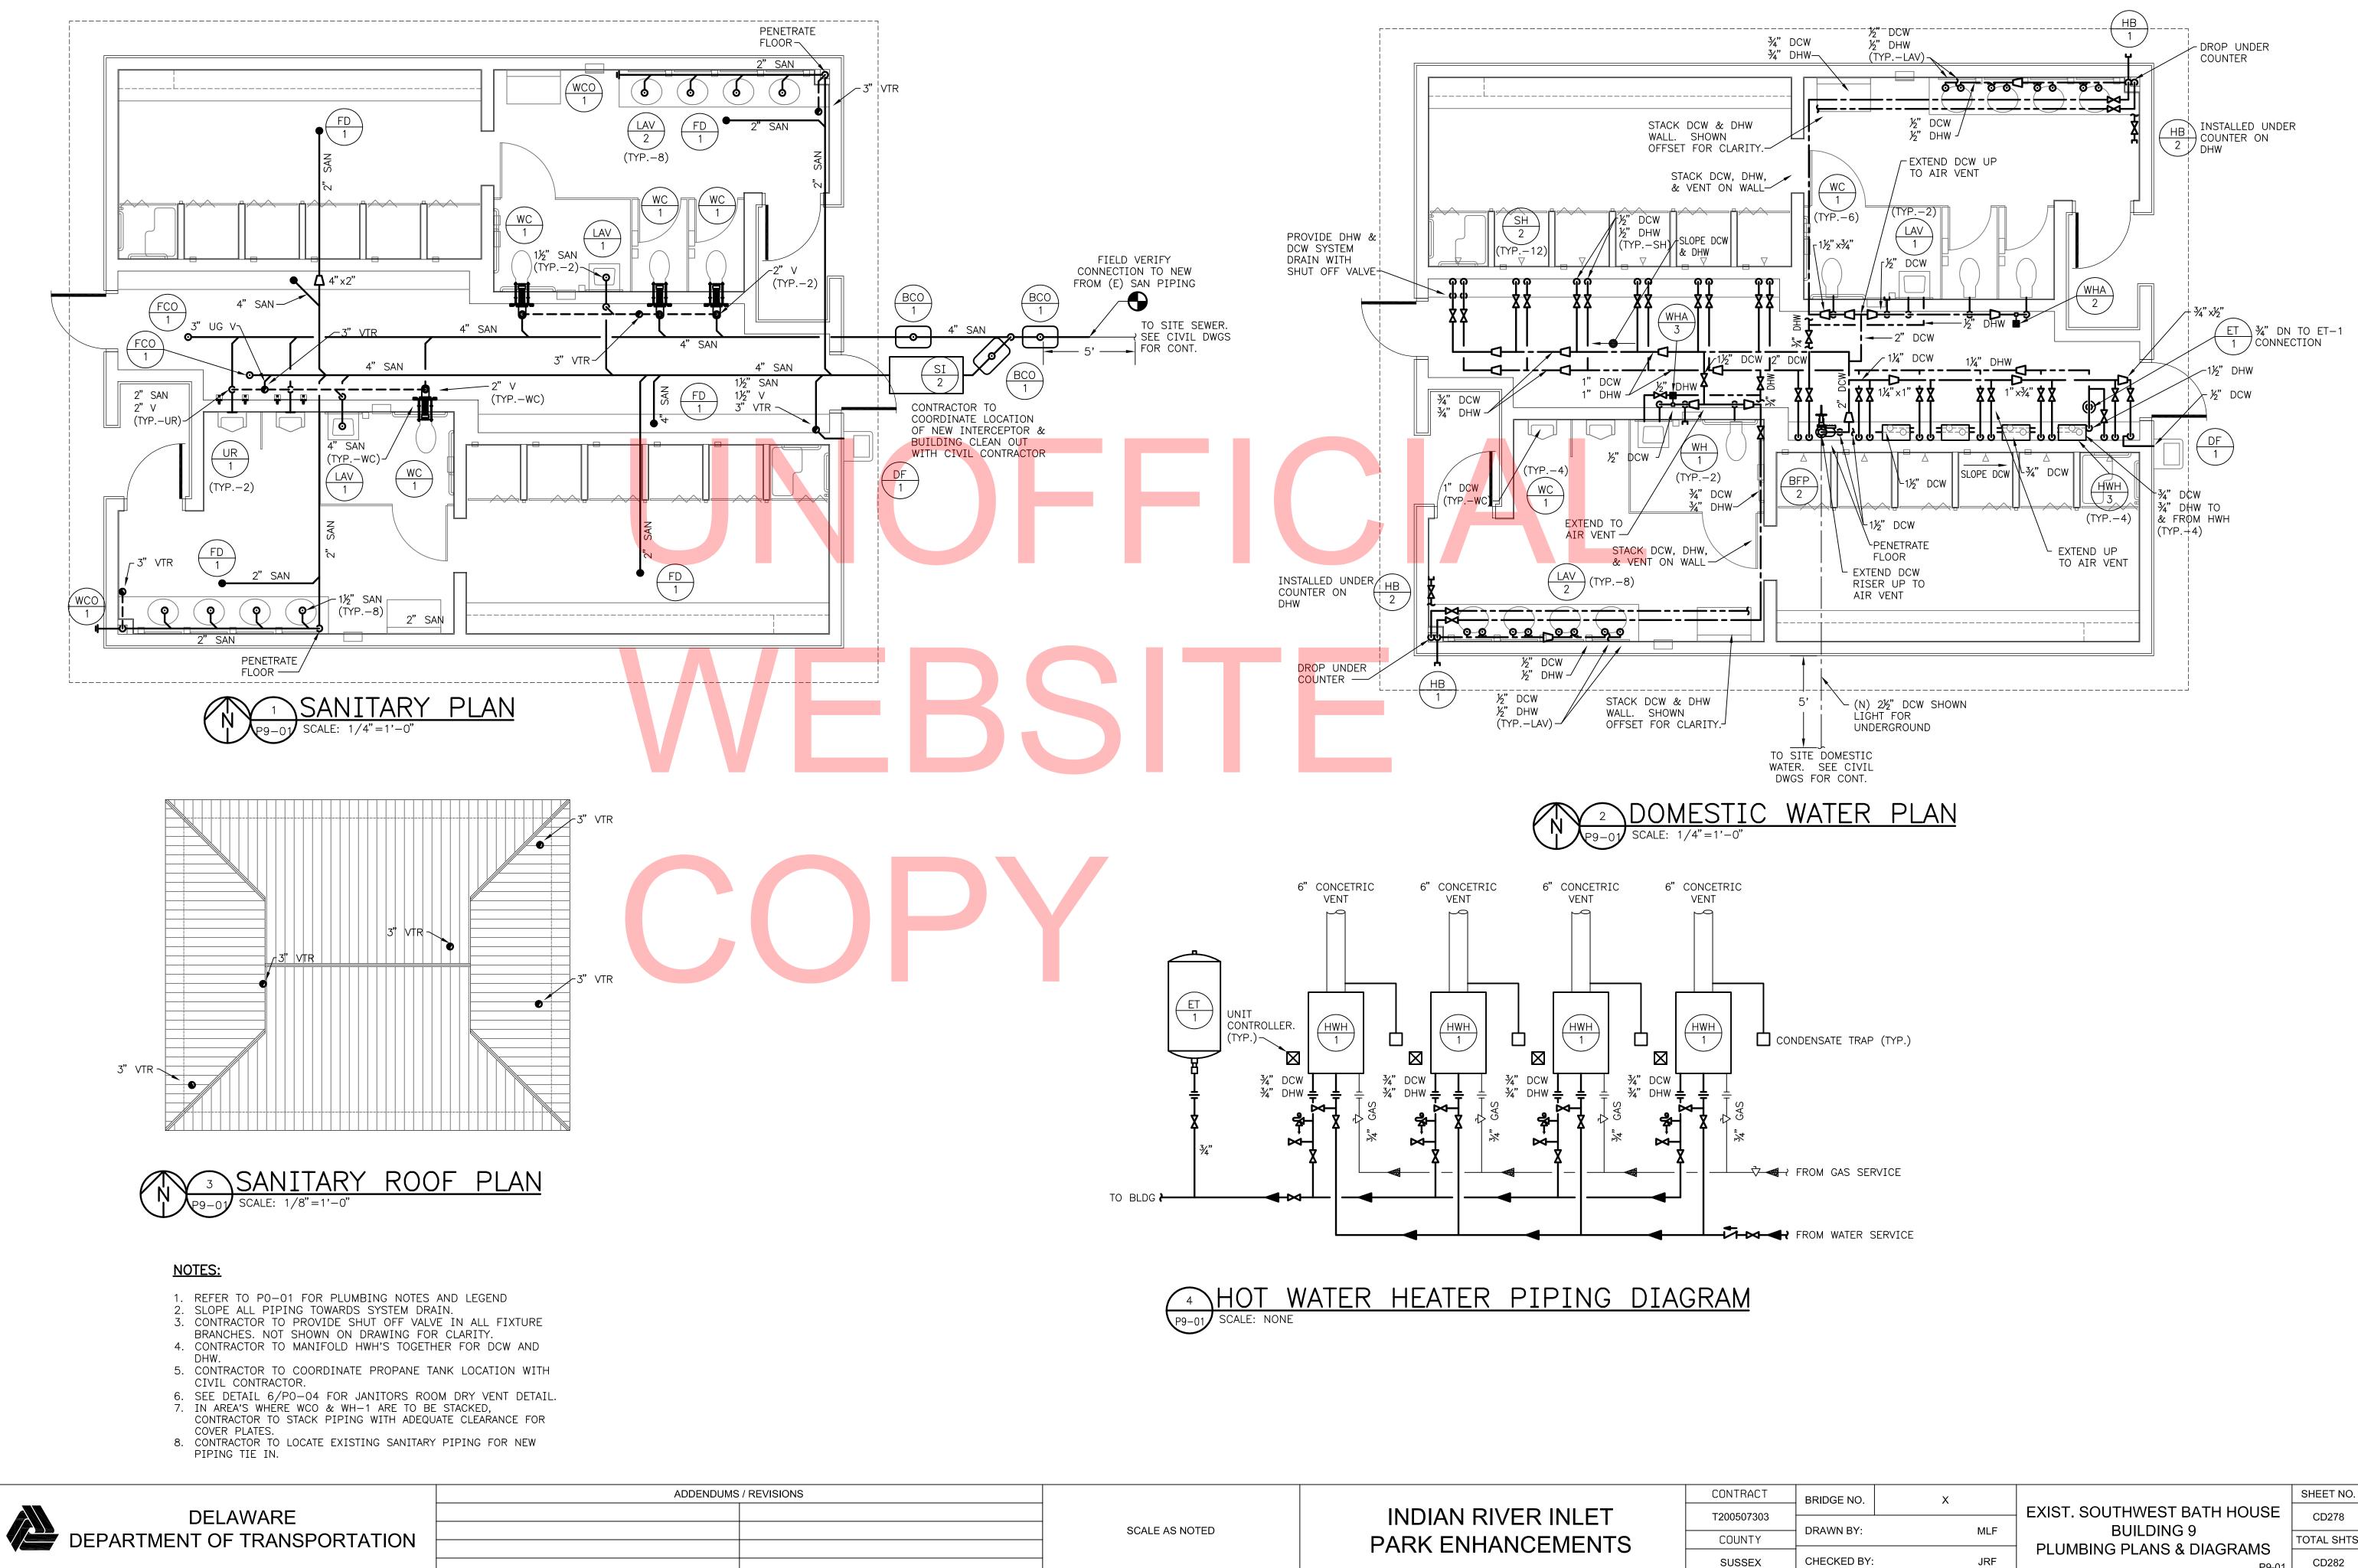


P9-01


TOTAL SHTS. CD282

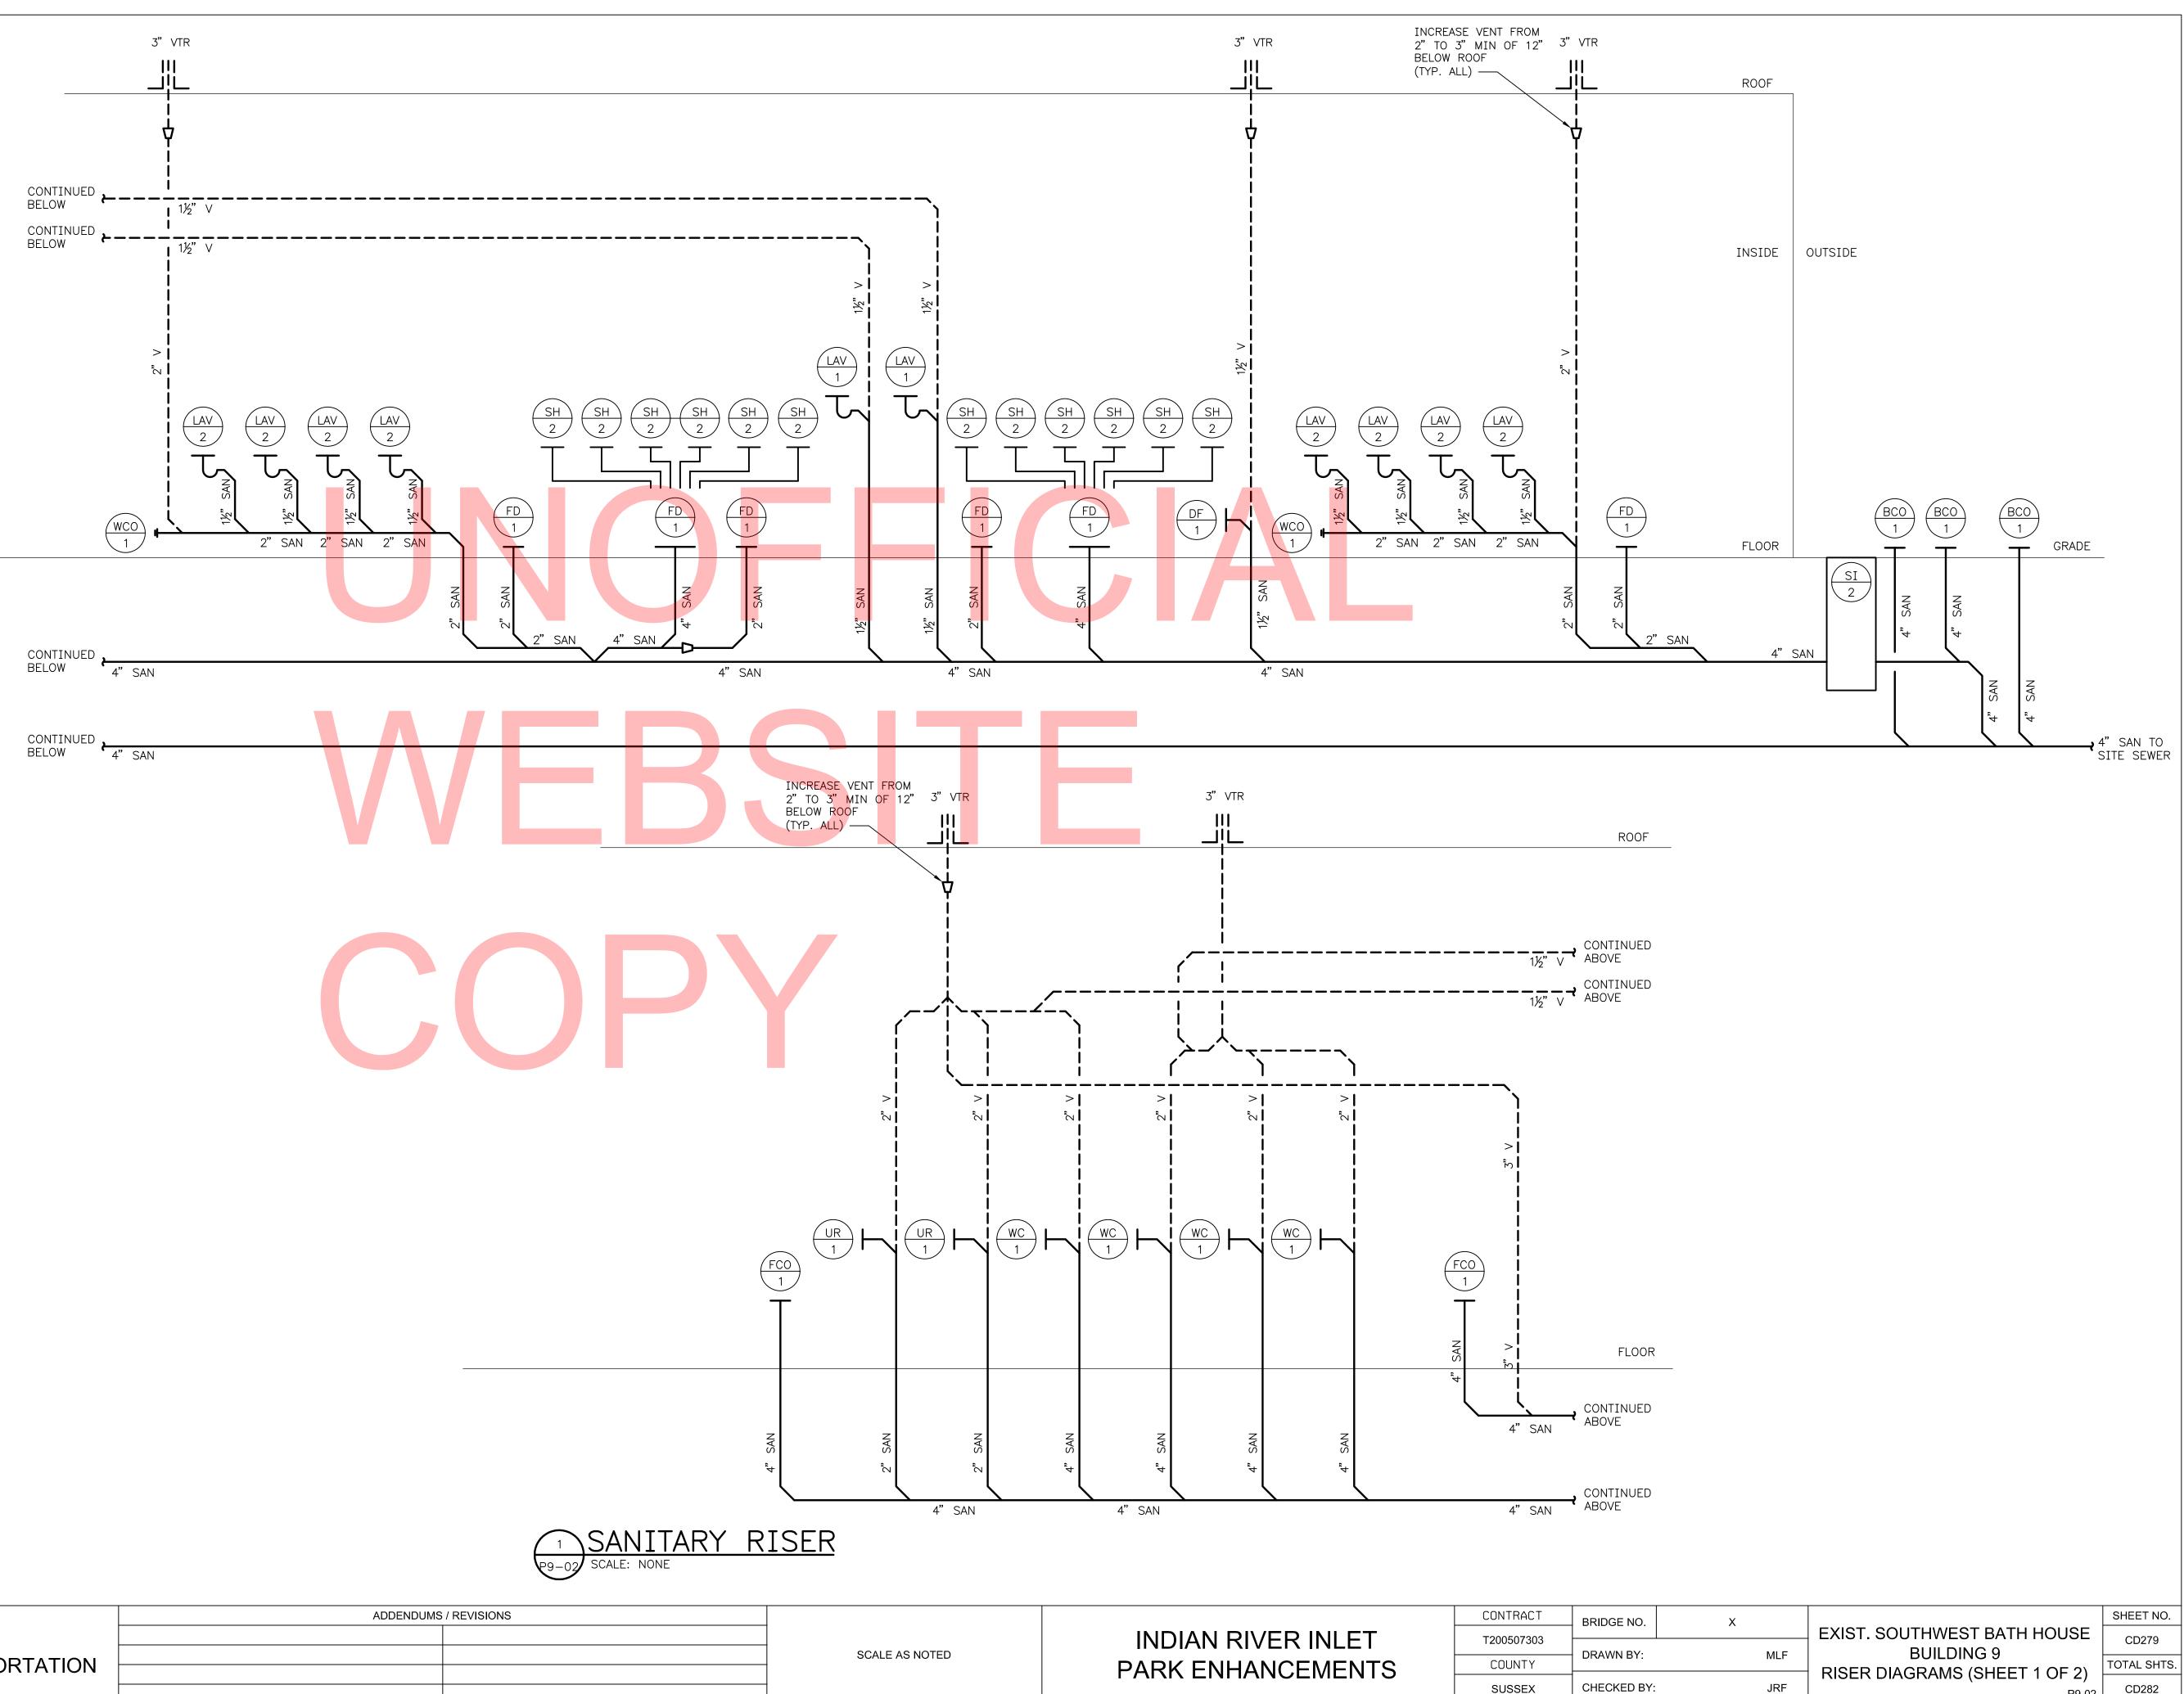



	CONTRACT	BRIDGE NO.	х			SHEET NO.
Γ	T200507303		~		EXIST. SOUTHWEST BATH HOUSE	CD279
	1200301303	DRAWN BY:		MLF	BUILDING 9	00213
	COUNTY				RISER DIAGRAMS (SHEET 1 OF 2)	TOTAL SHTS
	SUSSEX	CHECKED BY:		JRF	P9-02	CD282

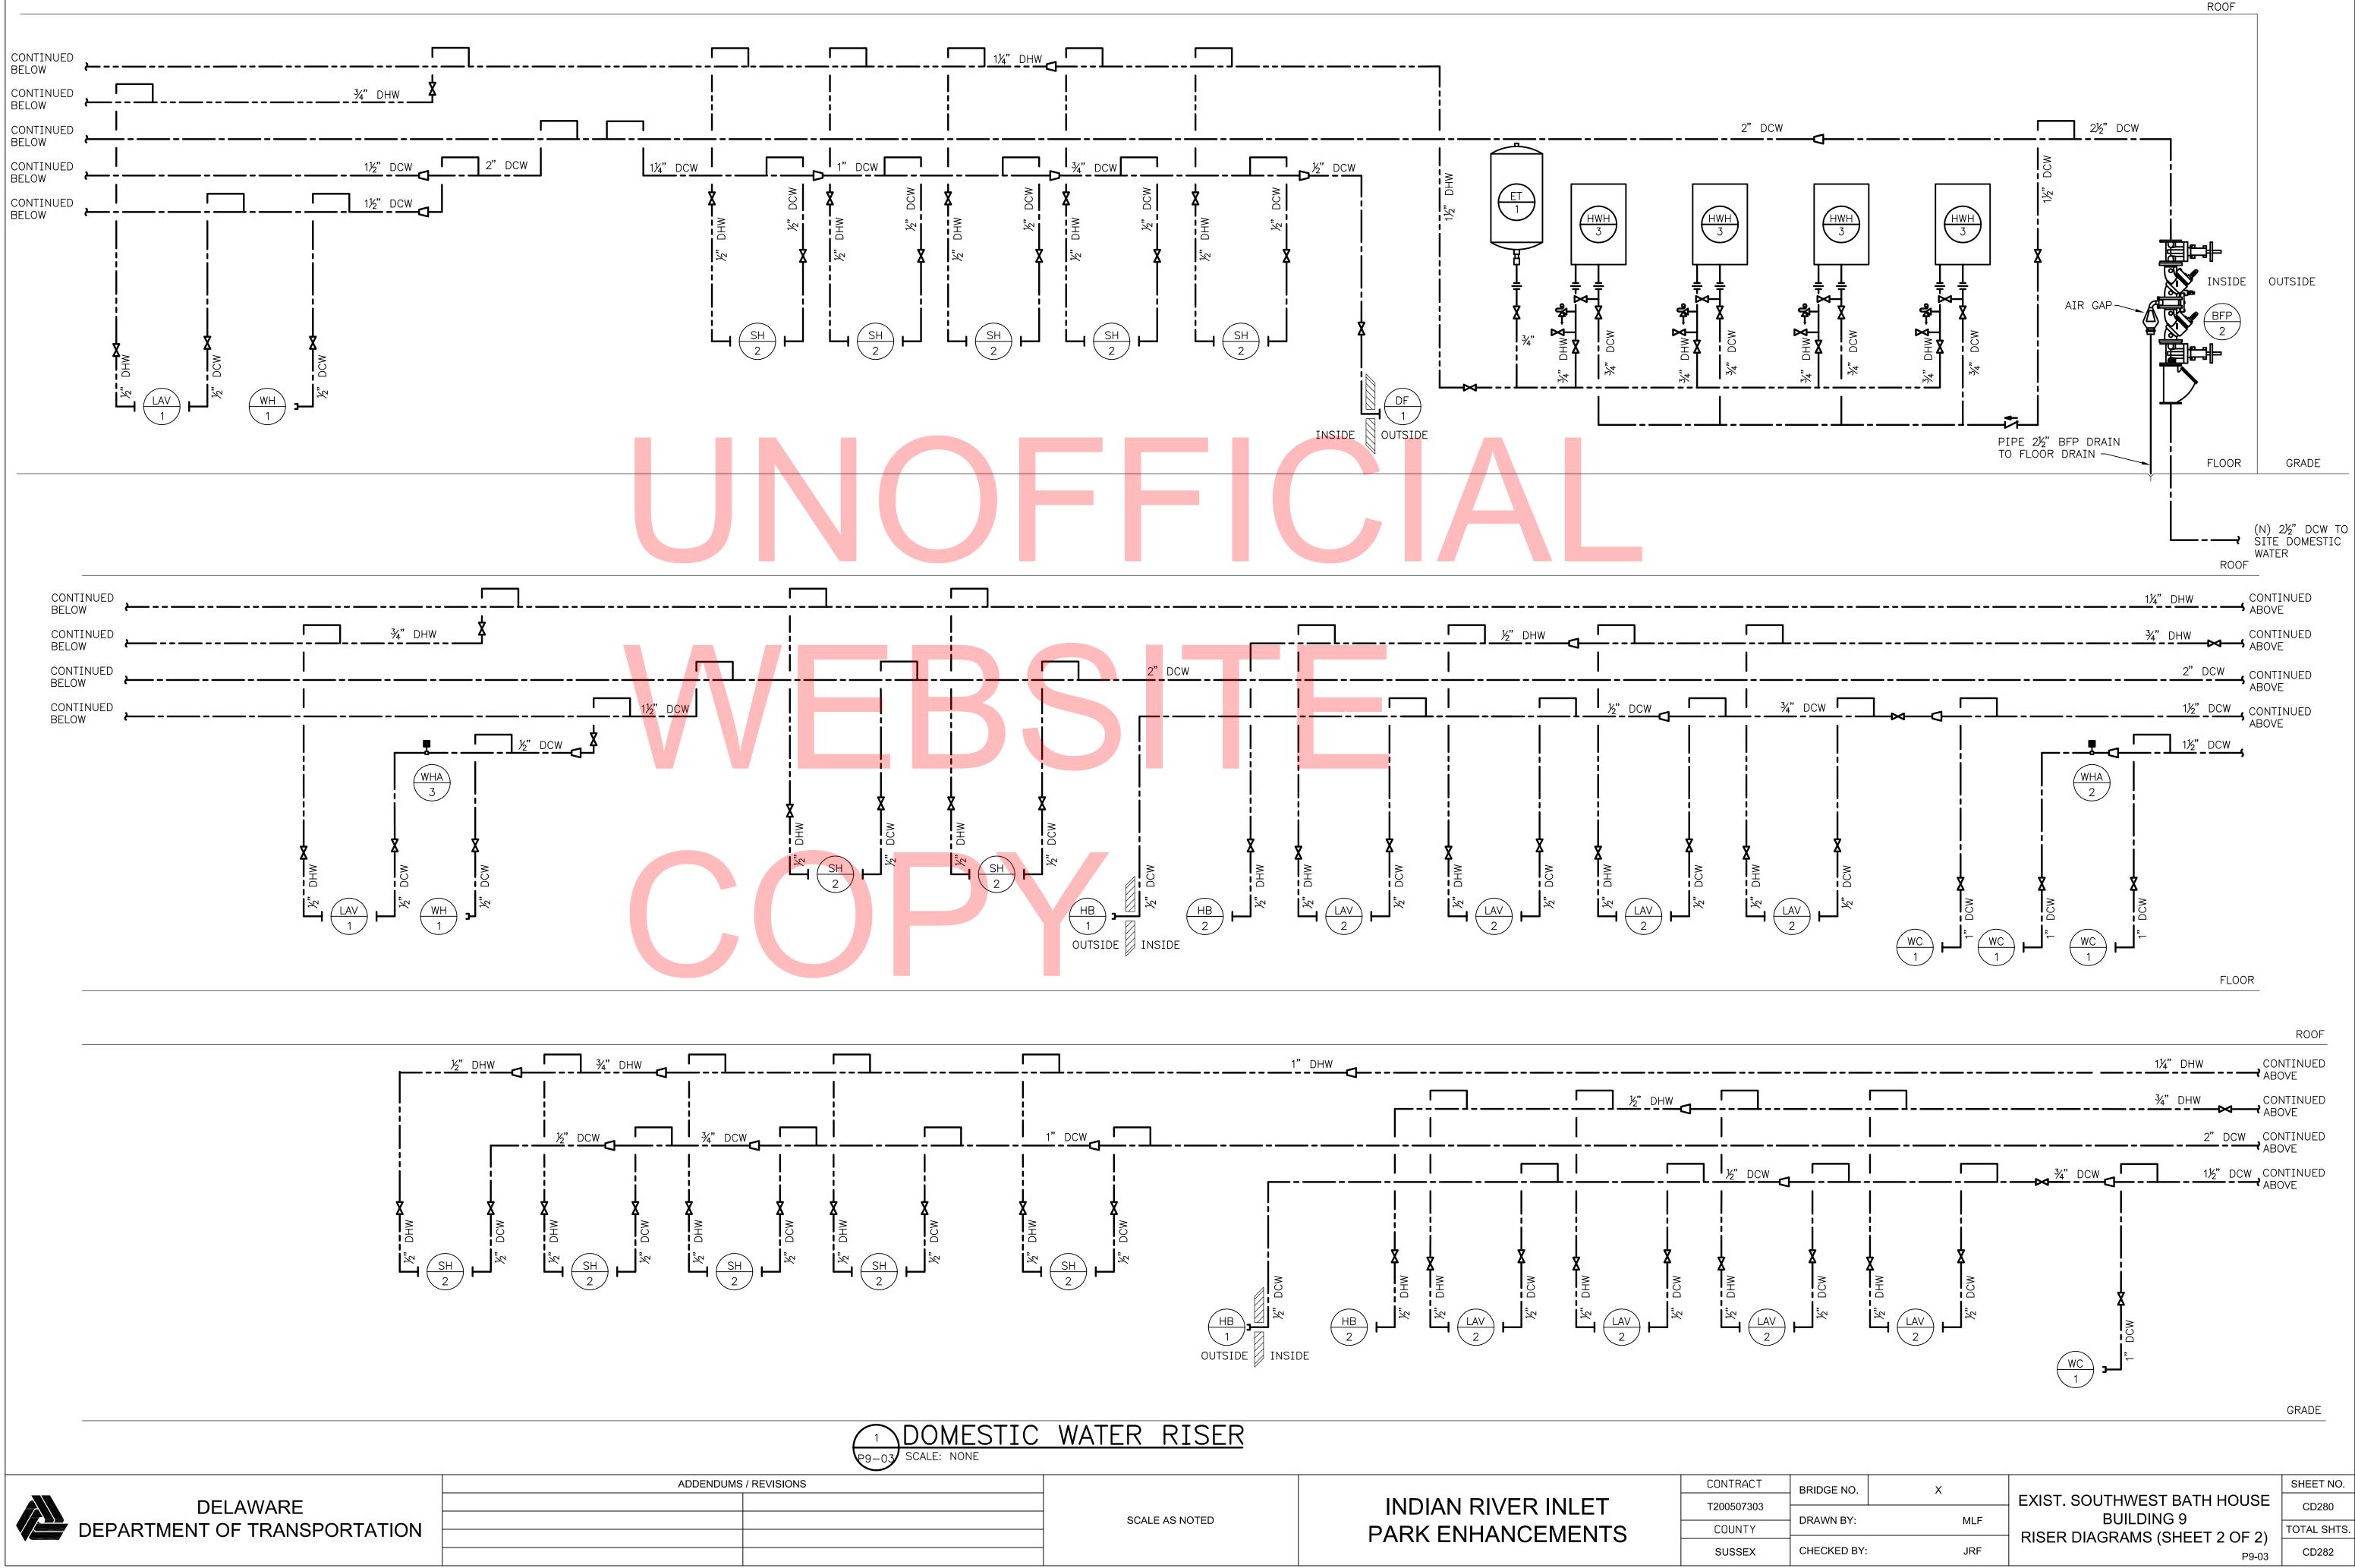

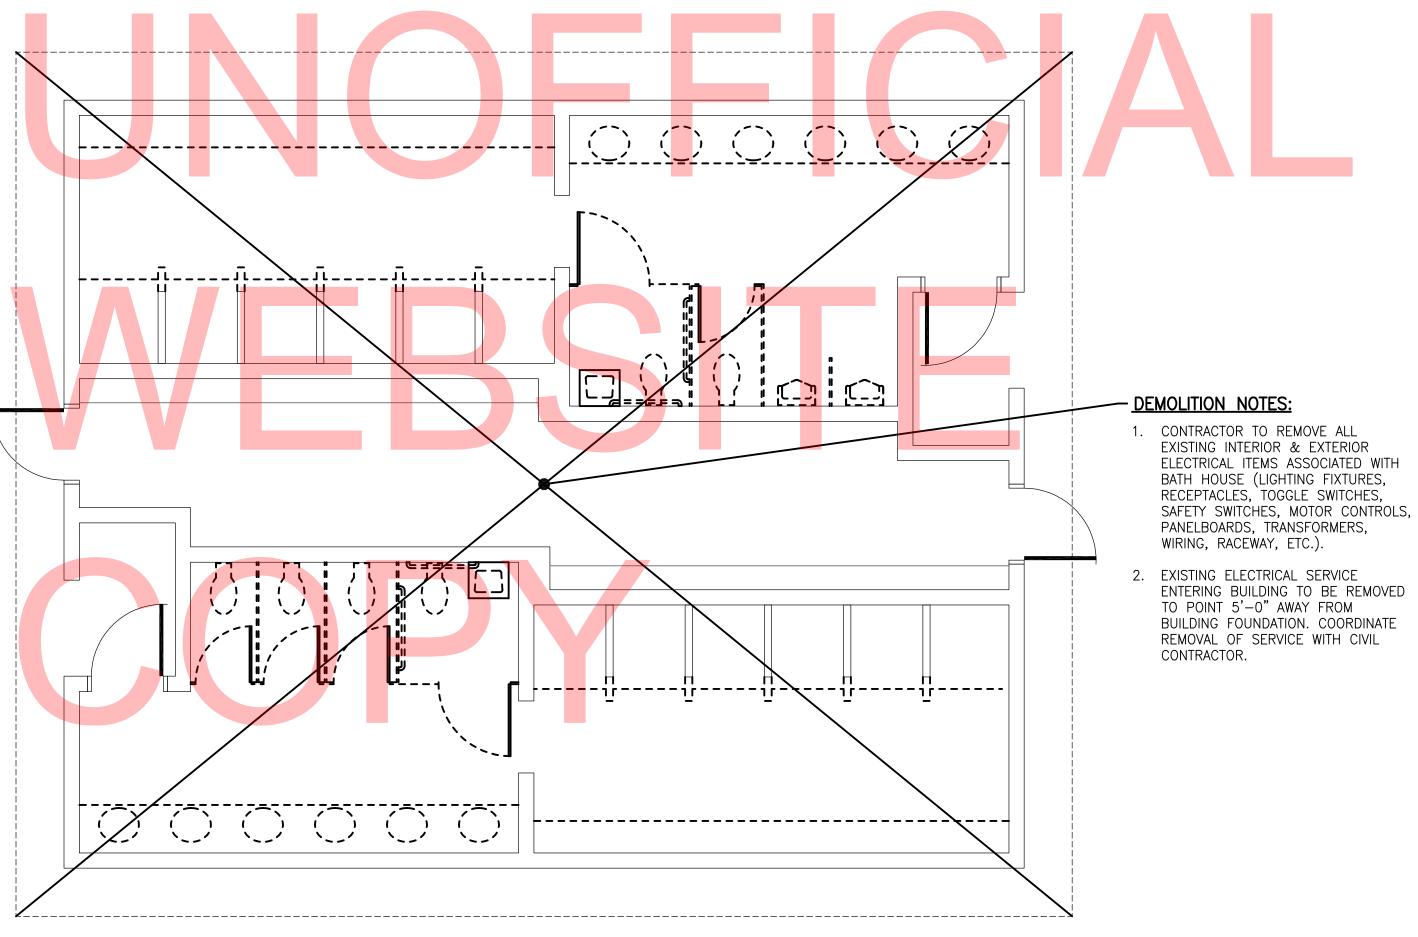






# 1 EXIST. SOUTHWEST BATH HOUSE - ELECTRICAL DEMOLITION PLAN SCALE: 1/4"=1'-0"

### INDIAN RIVER INLET PARK ENHANCEMENTS

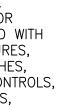


CONTRACT T200507303 COUNTY SUSSEX

BRIDGE NO. Х DRAWN BY: AHH JRF CHECKED BY:

EXIST. SOUTHWEST BATH HOUSE **BUILDING 9** ELECTRICAL DEMOLITION PLAN ED9-01

SHEET NO. CD281 TOTAL SHTS.

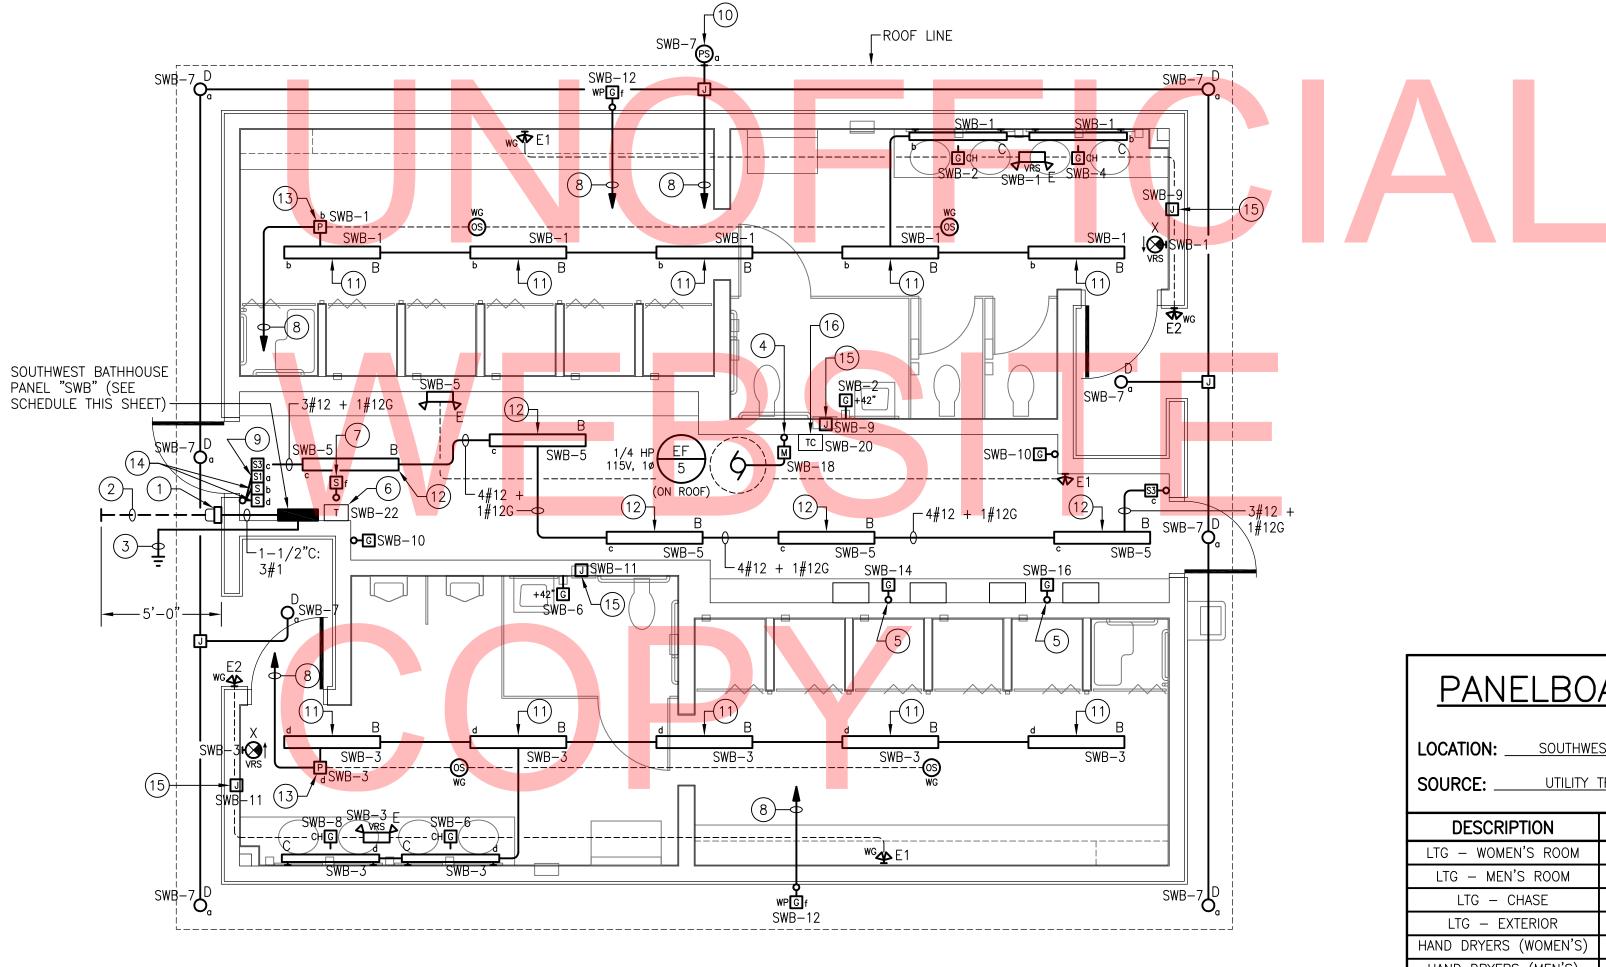





ADDENDUMS / REVISIONS

# ) EXIST. SOUTHWEST BATH HOUSE - ELECTRICAL PLAN SCALE: 1/4"=1'-0"

PANELBOARD "SWB" SCHEDULE         LOCATION:							
SOURCE:       UTILITY TRANSFORMER       MAIN BREAKER:       100A							
DESCRIPTION	BRKR SIZE	CIR NO	$A_{\phi} B_{\phi}$	CIR NO	BRKR SIZE	DESCRIPTION	
LTG – WOMEN'S ROOM	20A	1		2	20A	REC – WOMEN'S ROOM	
LTG – MEN'S ROOM	20A	3		4	20A	REC – WOMEN'S ROOM	
LTG – CHASE	20A	5		6	20A	REC – MEN'S ROOM	
LTG – EXTERIOR	20A	7		8	20A	REC – MEN'S ROOM	
HAND DRYERS (WOMEN'S) 20A 9 10 20A REC - CHASE						REC – CHASE	
HAND DRYERS (MEN'S) 20A 11 12 20A REC – EXTERIOR							
SPARE 15A 13 14 20A REC - INST. WAT					REC – INST. WATER HTRS.		
SPARE	20A	15		16	20A	REC – INST. WATER HTRS.	
SPARE	20A	17		18	15A	EXHAUST FAN	
SPARE	20A	19		20	15A	EXH. FAN TIME CLOCK CONTROL	
SPARE	20A	21		22	20A	CONTROL POWER XFMR	
SPARE	20A	23		24	20A	SPARE	
PREPARED SPACE	-	25	│ ♦┤	26	_	PREPARED SPACE	
PREPARED SPACE	-	27		28	_	PREPARED SPACE	
PREPARED SPACE - 29 + 30 - PREPARED SPACE							
PANEL NOTES:         1. PANELBOARD ASSEMBLY SHALL BE SUITABLE FOR USE AS SERVICE EQUIPMENT.         2. UL SHORT CIRCUIT CURRENT RATING OF PANELBOARD AND UL INTERRUPT RATINGS OF ALL CIRCUIT BREAKERS WITHIN PANELBOARD SHALL BE COORDINATED WITH							

INDIAN RIVER INLET PARK ENHANCEMENTS

SCALE AS NOTED

### SHEET NOTES:

- (1) 125A, 1Ø, 3W METER SOCKET PER UTILITY REQUIREMENTS (METER PROVIDED BY ELECTRIC UTILITY).
- 2 EMPTY 2-1/2" SCHEDULE 80 PVC UNDERGROUND CONDUIT STUB-OUT WITH PULL STRING FOR ELECTRICAL SERVICE TO BUILDING (CONDUCTORS PROVIDED BY OTHERS). TOP OF CONDUIT SHALL BE BURIED MINIMUM 36" BELOW FINISHED GRADÈ. PROVIDE CONTINUOUS DETECTABLÉ RED WARNING TAPE IN BACKFILL 12" BELOW FINISHED GRADE ("CAUTION - BURIED ELECTRIC LINE BELOW").
- (3) SEE DIAGRAM 3/E0-02 FOR PANELBOARD GROUNDING AND BONDING DETAILS.
- (4) SEE EXHAUST FAN WIRING DIAGRAM 2/E0-02.
- 5 RECEPTACLE OUTLET FOR GAS-FIRED INSTANTANEOUS WATER HEATERS. EXACT MOUNTING LOCATION TO BE FIELD-COORDINATED WITH MECHANICAL PIPING.
- 6 CONTROL POWER TRANSFORMER (TRANSFORMER & LOW VOLTAGE CONTROL WIRING PROVIDED BY CONTROLS CONTRACTOR). PRIMARY CIRCUIT TO BE PROVIDED BY ELECTRICAL CONTRACTOR. NOTE: TRANSFORMER TO BE PROVIDED WITH FACTORY-INSTALLED PRIMARY AND SECONDARY FUSE BLOCKS WITH FUSES AS REQUIRED.
- (7) MASTER SWITCH CONTROL FOR EXTERIOR RECEPTACLE OUTLETS (PROVIDE LABEL).
- (8) TO TOGGLE SWITCH ADJACENT TO PANEL "SWB" IN CHASE.
- 9 EXTERIOR LIGHTING MAINTENANCE SWITCH (PROVIDE LABEL). SEE EXTERIOR LIGHTING CONTROL WIRING DIAGRAM 1/E0-02.
- 0 OUTDOOR PHOTOSENSOR FOR CONTROL OF EXTERIOR LIGHTING FIXTURES (SEE EXTERIOR LIGHTING CONTROL WIRING DIAGRAM 1/E0-02 FOR DETAILS). MOUNT TO ROOF LINE FASCIA ON NORTH SIDE OF BUILDING.
- (11) SECURE LIGHTING FIXTURE TO UNDERSIDE OF ROOF JOISTS.
- (12) CHAIN-SUSPEND LIGHTING FIXTURE 8'-0" A.F.F. EXACT LOCATION TO BE FIELD-COORDINATED WITH MECHANICAL PIPING & DUCTWORK.
- (13) POWER RELAY PACK WITH OCCUPANCY SENSORS FOR CONTROL OF BATHROOM LIGHTING FIXTURES. CONNECT PER MANUFACTURER'S WIRING INSTRUCTIONS.
- (14) MASTER-OFF SWITCHES FOR MEN'S & WOMEN'S ROOM LIGHTING FIXTURES (PROVIDE LABELS). CONNECT PER OCCUPANCY SENSOR MANUFACTURER'S WIRING INSTRUCTIONS.
- 15 JUNCTION BOX FOR HAND DRYER (510W, 120V, 10). FIELD-COORDINATE EXACT LOCATION AND PROVIDE ALL CIRCUITING TO HAND DRYER AS REQUIRED PER DRYER MANUFACTURER'S INSTALLATION INSTRUCTIONS.
- (16) TIME CLOCK CONTROL FOR EXHAUST FAN EF/5 (TIME CLOCK & CONTROL WIRING TO EXHAUST FAN PROVIDED BY CONTROLS CONTRACTOR). POWER SUPPLY CIRCUIT TO BE PROVIDED BY ELECTRICAL CONTRACTOR.

AVAILABLE FAULT CURRENT AT PANELBOARD PRIOR TO PURCHASING EQUIPMENT. COORDINATE WITH ELECTRIC UTILITY AND SITE ENGINEER.

ALL CIRCUIT BREAKERS WITHIN PANELBOARD SHALL BE HACR RATED.

CONTRACT	BRIDGE NO.	х	
T200507303			EX
	DRAWN BY:	АНН	
COUNTY			-
SUSSEX	CHECKED BY:	JRF	

XIST. SOUTHWEST BATH HOUSE **BUILDING 9** ELECTRICAL PLAN

SHEET NO. CD282 TOTAL SHTS.

E9-01